





CITY ENGINEER'S OFFICE
 1805 NE 30th AVE, BLDG #600
 OCALA, FLORIDA 34470

CONTRACT PLANS

FPN NO. 435547-3-54-01
 ITB NO. CIP/230168

NW 44th AVENUE EXTENSION PHASE 2 NW 46TH AVENUE BETWEEN W. SILVER SPRINGS BLVD. AND NW 11TH ST.

100% PLANS
 DATE: 9/25/2023

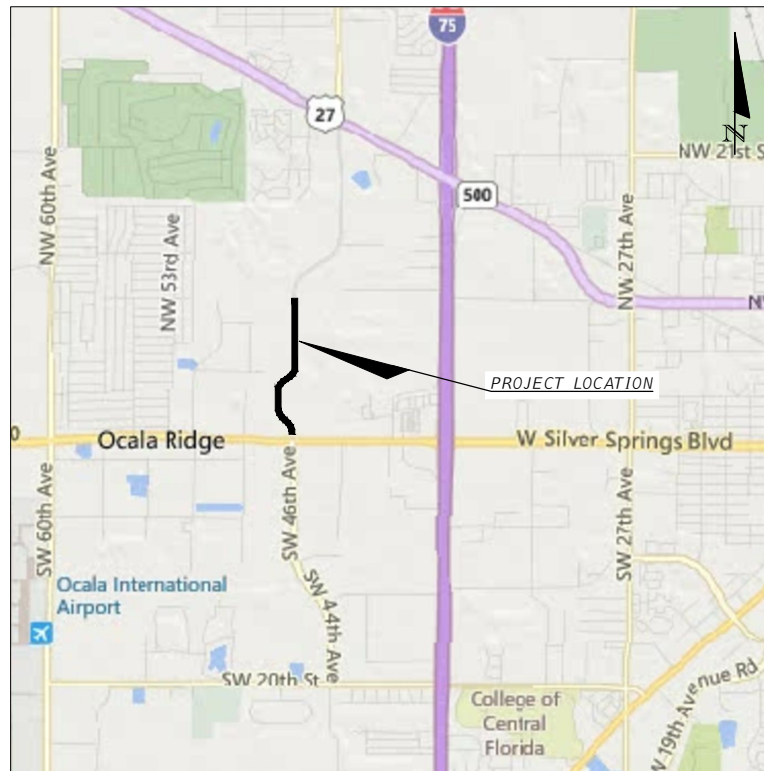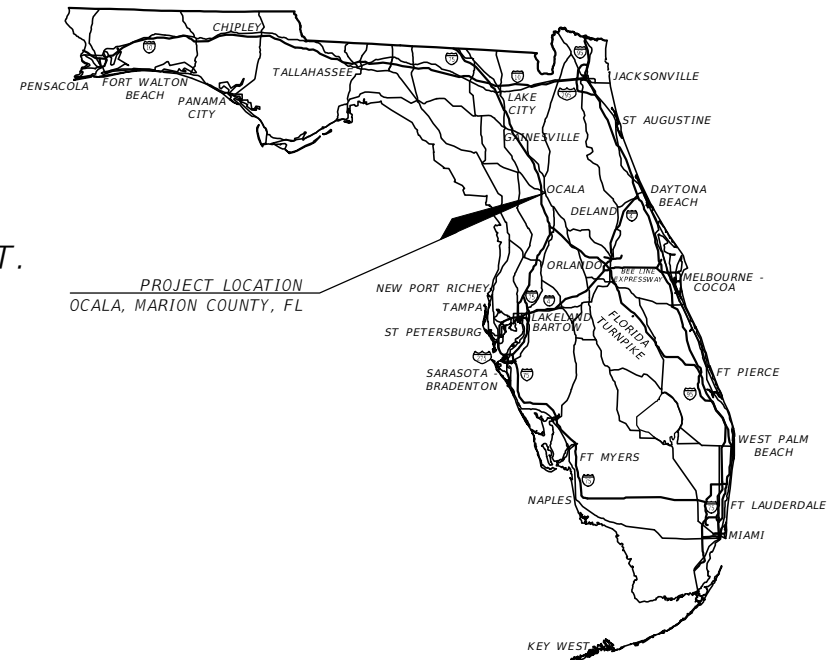

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LOCAL UTILITIES

UTILITY COMPANY	PHONE NUMBER	EMERGENCY
OCALA PUBLIC WORKS (TRAFFIC)	(352) 351-6733	
OCALA ELECTRIC UTILITY	(352) 351-6620	(352) 351-6666 (LEAVE MESSAGE)
OCALA WATER RESOURCES	(352) 351-6772	(352) 351-6775
COX COMMUNICATIONS	(888) 269-9693	
CENTURYLINK	(352) 368-8817	
TECO GAS	(352) 622-0112	(352) 622-0111

GOVERNING DOCUMENTS:

U.S. Department of Transportation, Manual on Uniform Traffic Control Devices (2009 Version With Revisions)

Florida Department of Transportation, Standard Plans for Road and Bridge Construction (2022-2023 Version)

Florida Department of Transportation, Standard Specifications for Road and Bridge Construction (FY 2023-24 Version)

Florida Department of Transportation, Manual of Uniform Minimum Standards for Design, Construction, & Maintenance of Streets & Highways "Florida Green Book" (2018)

City of Ocala, Standard Specifications For Construction of Streets, Stormwater, Traffic, Water & Sewer Infrastructure (February 2023)

DESIGN SPEED:


35 MPH = STA 200+00 TO STA 220+10 (POSTED 35 MPH)
 50 MPH = STA 221+10 TO STA 240+67.45 (POSTED 40 MPH)

SCOPE OF WORK:

CONSTRUCTION OF 4,000 FEET MORE-OR-LESS SECTION OF 4-LANE DIVIDED ROADWAY FROM W SILVER SPRINGS BLVD. (AKA STATE ROAD 40) TO NW 11th STREET WITH DRAINAGE, FACILITIES AND POTABLE WATER AND SANITARY GRAVITY LINES.



REVISIONS				PREPARED BY	NW 44th AVENUE EXTENSION PHASE 2	SHEET NO.
DATE	DESCRIPTION	DATE	DESCRIPTION	NOEL JOHN COOPER, P.E. P.E. LICENSE NUMBER 69534 STATE OF FLORIDA, DATE: _____ VALID ONLY WITH EMBOSSED SEAL.		<h1>KEY SHEET</h1>
11/30/22	Revised posted speed note (STA 200+00 to 220+10)	4/6/23	Revised project name & clean up sheets			
1/24/23	Revised date & sheets #: 8, 42, 44, 45, 53, & 56	8/8/23	Revised date on cover sheet & revised signature sheet			
1/25/23	Removed sheets #: 79 & 80					
3/8/23	Revised sheets #: 1, 3 & 78					

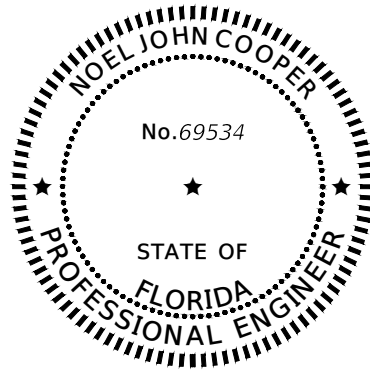

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on the date adjacent to the seal.


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CITY OF OCALA
CITY ENGINEER'S OFFICE
1805 NE 30TH AVE., BLDG. 300
OCALA, FL 34470

THE ABOVE NAMED PROFESSIONAL ENGINEER SHALL BE RESPONSIBLE FOR THE FOLLOWING SHEETS IN ACCORDANCE WITH RULE 61G15-23.004, F.A.C.

PLAN INDEX

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- GENERAL NOTES
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- ROADWAY PROFILES
- DRAINAGE RETENTION PLAN
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- SCHEDULE OF DRAINAGE STRUCTURES
- PIPE SCHEDULE
- DRAINAGE DETAILS
- ROADWAY CROSS-SECTIONS
- SIGNAGE AND STRIPING PLAN

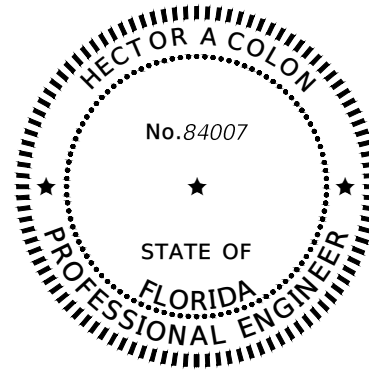

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
PLAN INDEX

- UTILITY PLANS & PROFILE
- UTILITY NOTES

REVISIONS					PREPARED BY	NW 44th AVENUE EXTENSION PHASE 2	SHEET NO.
DATE	DESCRIPTION	DATE	DESCRIPTION			SIGNATURE SHEET	2
4/6/23	Revised plan index			NOEL JOHN COOPER, P.E. P.E. LICENSE NUMBER 69534 STATE OF FLORIDA, DATE: _____ VALID ONLY WITH EMBOSSED SEAL.		SIGNATURE SHEET	2
5/9/23	Revised Engineer Credential						
8/8/23	Revised Engineer Signature						

ITEM No.	ITEM DESCRIPTION	UNIT	QTY.
G-01	Mobilization	LS	1
G-02	Maintenance And Guarantee Bond	LS	1
G-03	Project Sign	EA	2
G-05	Maintenance of Traffic	LS	1
G-06-1	Silt Fence	LF	8560
G-06-2	Inlet Protection	EA	4
G-09	Clearing and Grubbing - Light	SY	16,903.20
G-10	Clearing and Grubbing - Heavy	SY	42,056.43
G-11	General Excavation	CY	23,614.00
G-12	Imported Backfill Material	CY	2,121.04
G-15	Finish Grading	SY	31,743.00
G-17	Remove and Replace Unsuitable Material	CY	7,840.00
G-18	Stabilized subgrade	SY	31,013.04
G-19-09	Limerock 10" Base	SY	27,413.22
G-21	Removal of Concrete Sidewalks and Driveways	SY	130.38
G-22	Removal of Concrete Curb & Gutter	LF	286
G-27-05	Mill Existing Asphalt Pavement at 4" Depth	SY	180.72
G-28	Compacted Roadway Subbase	SY	30,834.22
G-32-09	Asphalt Pavement FC 9.5 w/Poly	TN	1,508
G-32-12	SP 12.5 Asphalt Superpave	TN	4,523
G-33	Roadway Guardrail	LF	216
G-34-1	Object Marker, Type 1	EA	11
G-46-9	18" RCP STORMWATER PIPE, 0'-6'	LF	1,400
G-46-14	24" RCP STORMWATER PIPE, 6'-12'	LF	1,500
G-46-15	24" RCP STORMWATER PIPE, 12'-18'	LF	1,010
G-46-18	30" RCP STORMWATER PIPE, 6'-12'	LF	880
G-49-5	30" CONCRETE MITERED END	EA	3
G-52-0	Construction Survey	HR	80
G-53-1	As-Built Survey, Roadway	HR	40
G-53-2	As-Built Survey, Utilitiies	HR	25
G-54-2	ALUMINUM PEDESTRIAN BICYCLE RAIL	LF	161


ITEM No.	ITEM DESCRIPTION	UNIT	QTY.
G-56-07	Concrete Curb and Gutter, Type E	LF	5,930
G-56-10	Concrete Curb and Gutter, Type F	LF	7,982
G-58-04	Concrete Sidewalk, 4" Thick, 3,000 PSI	SY	4,298.40
G-58-06	Concrete Sidewalk and Driveways, 6" Thick, 3,000 PSI, Fiber Reinforced	SY	149.35
FDOT-400-2-11	Con. Class II, Retaining Wall (SPI - 400-011)	CY	102.70
G-61-C	Concrete Curb Ramp (CR - C) with Detectable Warning Surface	EA	2
G-61-F	Concrete Curb Ramp (CR - F) with Detectable Warning Surface	EA	4
G-80	Sod, Bahia	SY	31,743.00
G-89-11	Single Post Sign, F & I, Less than 12 ft ²	AS	31
G-89-12	Single Post Sign, F & I, More than 12 ft ²	AS	3
G-90-1	Single Post Sign, Relocate	AS	1
G-90-2	Single Post Sign, Remove	AS	4
G-91	Raised Retro-Reflective Pavement Marker w/ Adhesive	EA	621
G-93-121	Temporary Traffic Stripes and Markings, Standard, White, Solid, 6" Stripe	LF	8067
G-93-122	Temporary Traffic Stripes and Markings, Standard, White, Solid, 8" Stripe	LF	526
G-93-123	Temporary Traffic Stripes and Markings, Standard, White, Solid, 12" Stripe	LF	167
G-93-124	Temporary Traffic Stripes and Markings, Standard, White, Solid, 18" Stripe	LF	149
G-93-125	Temporary Traffic Stripes and Markings, Standard, White, Solid, 24" Stripe	LF	158
G-93-131	Temporary Solid 6" Skip Stripe 10' x 30' White (Gross)	LF	7,749
G-93-141	Temporary Solid 6" Skip Stripe 2' x 4' White (Gross)	LF	450
G-93-221	Temporary Traffic Stripes and Markings, Standard, Yellow, Solid, 6" Stripe	LF	7372
G-93-224	Temporary Traffic Stripes and Markings, Standard, Yellow, Solid, 18" Stripe	LF	344

REVISIONS				PREPARED BY	NW 44th AVENUE EXTENSION PHASE 2	SHEET NO.
DATE	DESCRIPTION	DATE	DESCRIPTION			
11/30/22	Revise Summary Of Pay Items Quantity				SUMMARY OF PAY ITEMS	3
1/19/23	Revise Pay Items Quantity (G15 & G80)					
1/25/23	Revised Summary Of Pay Items Quantity (Striping)					

NOEL JOHN COOPER, P.E.
P.E. LICENSE NUMBER 69534
STATE OF FLORIDA, DATE: _____
VALID ONLY WITH EMBOSSED SEAL.

ITEM No.	ITEM DESCRIPTION	UNIT	QTY.
G-93-231	Temporary Solid 6" Skip Stripe 10' x 30' Yellow (Gross)	LF	590
G-94-1-121	Thermoplastic Traffic Stripes and Markings, Standard, White, Solid, 6" Stripe	LF	8,067
G-94-1-122	Thermoplastic Traffic Stripes and Markings, Standard, White, Solid, 8" Stripe	LF	526
G-94-1-123	Thermoplastic Traffic Stripes and Markings, Standard, White, Solid, 12" Stripe	LF	167
G-94-1-124	Thermoplastic Traffic Stripes and Markings, Standard, White, Solid, 18" Stripe	LF	149
G-94-1-125	Thermoplastic Traffic Stripes and Markings, Standard, White, Solid, 24" Stripe	LF	158
G-94-1-131	ThermoPlastic Solid 6" Skip Stripe 10' x 30' White (Gross)	LF	7,749
G-94-1-141	ThermoPlastic Solid 6" Skip Stripe 2' x 4' White (Gross)	LF	450
G-94-1-221	Thermoplastic Traffic Stripes and Markings, Standard, Yellow, Solid, 6" Stripe	LF	8,372
G-94-1-224	Thermoplastic Traffic Stripes and Markings, Standard, Yellow, Solid, 18" Stripe	LF	344
G-94-1-231	ThermoPlastic Solid 6" Skip Stripe 10' x 30' Yellow (Gross)	LF	590
G-95-16	Thermoplastic Pavement Message	EA	20
G-95-17	Thermoplastic Pavement Arrow	EA	24
G-96-16	Temporary Pavement Message	EA	20
G-96-17	Temporary Pavement Arrow	EA	24
G-100-46	6' Type IV Concrete Traffic Separator	LF	816
G-105	Remove Stripe/Pavement/Message (Grind)	SF	9,650
G-106-15-1	TYPE 5 STORMWATER INLET, 0'-6'	EA	17
G-106-15-2	TYPE 5 STORMWATER INLET, 6'-12'	EA	10
G-106-15-3	TYPE 5 STORMWATER INLET, 12'-18'	EA	3
G-106-16-1	TYPE 6 STORMWATER INLET, 0'-6'	EA	5
G-106-16-2	TYPE 6 STORMWATER INLET, 6'-12'	EA	1

ITEM No.	ITEM DESCRIPTION	UNIT	QTY.
S-01-1-08-2	8" PVC, 6' - 12'	LF	730
S-01-1-08-3	8" PVC, 12' - 18'	LF	1,253
S-01-1-12-2	12" PVC, 6' - 12'	LF	750
S-01-1-12-3	12" PVC, 12' - 18'	LF	736
S-02-2	SEWER MANHOLE W/ EPOXY, 6' - 12'	EA	4
S-02-3	SEWER MANHOLE W/ EPOXY, 12' - 18'	EA	5
S-02-6	SEWER MANHOLE W/ HDPE LINER, 6' - 12'	EA	1
S-23-2-08	DIP MJ FITTINGS 8"	EA	4
W-01-1-12	12" PVC WATER MAIN	LF	4,100
W-01-2-08	8" DIP WATER MAIN	LF	750
W-03-2-08	DIP MJ FITTINGS 8"	EA	4
W-03-2-12	DIP MJ FITTINGS 12"	EA	20
W-05-1-08	8" GATE VALVE W/ SST STEM & VALVE BOX	EA	8
W-05-2-12	12" BUTTERFLY VALVE & VALVE BOX	EA	4
W-09-1-08	FH ASSEMBLY ON 8" MAIN, TYPE A	EA	8
W-09-1-12	FH ASSEMBLY ON 12" MAIN, TYPE A	EA	8
W-14-5	2" SINGLE WATER SERVICE - SHORT	EA	3
W-16-16-12	12" TAP ON EXISTING 16" WATER MAIN W/VALVE & SST STEM	EA	1
-	-	-	-

REVISIONS		PREPARED BY	NW 44th AVENUE EXTENSION PHASE 2	SHEET NO.
DATE	DESCRIPTION			
11/30/22	Revised Summary Of Pay Items Quantity	 NOEL JOHN COOPER, P.E. P.E. LICENSE NUMBER 69534 STATE OF FLORIDA, DATE: _____ VALID ONLY WITH EMBOSSED SEAL.	SUMMARY OF PAY ITEMS	4
1/25/23	Revised Summary Of Pay Items Quantity (Striping)			
2/15/23	Revised Summary Of Pay Items Quantity (Striping)			

GENERAL NOTES:

1. ALL CONSTRUCTION WITHIN THE PROJECT AREA SHALL BE IN ACCORDANCE TO THE LATEST EDITION OF THE CITY OF OCALA'S "STANDARD SPECIFICATIONS FOR CONSTRUCTION OF STREETS, STORMWATER, TRAFFIC, WATER & SEWER INFRASTRUCTURE", JANUARY 2022 EDITION, THE FLORIDA DEPARTMENT OF TRANSPORTATION (FDOT) STANDARD PLANS FOR ROAD AND BRIDGE CONSTRUCTION, 2022-2023 EDITION, THE FDOT STANDARD SPECIFICATIONS FOR ROAD AND BRIDGE CONSTRUCTION, FY 2023-24 EDITION, AND THE UTILITY ACCOMMODATION MANUAL (UAM).
2. CONTRACTOR SHALL APPLY FOR CITY OF OCALA ROW PERMIT NO LESS THAN 5 BUSINESS DAYS PRIOR TO STARTING WORK.
3. THE CONTRACTOR SHALL BE NOISE SENSITIVE FOR NIGHT OPERATIONS IF THEY ARE REQUIRED.
4. CONTRACTOR SHALL REVIEW AND COMPLY WITH THE "SPECIAL PROVISIONS" AND OTHER ATTACHMENTS TO THE FDOT PERMIT FOR THIS PROJECT.
5. CONTRACTOR SHALL NOTIFY ALL PROPERTY OWNERS AFFECTED BY PROPOSED CONSTRUCTION ACTIVITIES IN ADVANCE OF SUCH OPERATIONS IN ACCORDANCE WITH FDOT AND/OR CITY OF OCALA NOTIFICATION REQUIREMENTS.
6. WHEN OPERATING OUTSIDE CITY OF OCALA RIGHT-OF-WAY, THE CONTRACTOR SHALL GIVE PROPER NOTIFICATION AND OBTAIN WRITTEN PERMISSION TO DO SO FROM THE OWNER OF EACH PARTICULAR PROPERTY.
7. A PRE-CONSTRUCTION CONFERENCE SHALL BE CONDUCTED BY THE CITY OF OCALA WITH THE CONTRACTOR, AND FDOT PERSONNEL.
8. THE CONTRACTOR SHALL BE RESPONSIBLE FOR EMPLOYING A FLORIDA LICENSED SURVEYOR AND MAPPER FOR CONDUCTING THE FOLLOWING DESCRIBED WORK: EXISTING SECTION CORNERS & 1/4 SECTION CORNERS, AND OTHER LAND MARKERS OR MONUMENTS, INCLUDING INDIVIDUAL LOT CORNERS, LOCATED WITHIN PROPOSED CONSTRUCTION AREA TO BE REFERENCED PRIOR TO CONSTRUCTION AND RESET AFTER CONSTRUCTION, IN ACCORDANCE WITH CHAPTERS 177 AND 472 OF THE FLORIDA STATUTES AND 5J17 OF THE FLORIDA ADMINISTRATION CODE.
9. ALL UNSUITABLE MATERIALS ENCOUNTERED SHALL BE DISPOSED OF AND REPLACED WITH APPROVED MATERIALS. NO TEMPORARY OR PERMANENT DEPOSITS SHALL BE MADE OUTSIDE OF THE PROPOSED R/W EXCEPT AS APPROVED BY ENGINEER.
10. EXCAVATED MATERIALS SHALL BE LOADED ONTO DUMP TRUCKS DIRECTLY BEHIND THE EQUIPMENT AND HAULED OFF TO THE DESIGNATED SITE. TRAFFIC CONTROL MEASURES SHALL BE PLACED ACCORDINGLY TO ACCOMMODATE THIS PROCESS.
11. ALL PIPE LENGTHS AND INVERTS SHOWN HERE IN ARE FROM C/L STRUCTURE TO C/L STRUCTURE OR END OF PIPE, UNLESS OTHERWISE NOTED.
12. CONTRACTOR TO FIELD VERIFY TOP ELEVATIONS OF ALL DRAINAGE STRUCTURES AND SEWER MANHOLES PRIOR TO FABRICATIONS.
13. ALL EXISTING MANHOLES, INLETS, AND VALVE COVERS THAT ARE RETAINED OR RELOCATED SHALL BE ADJUSTED TO MATCH PROPOSED FINISHED GRADE.
14. SOUTHWEST FLORIDA WATER MANAGEMENT DISTRICT NOTIFICATION: IF A SINKHOLE OR SOLUTION CHANNEL IS EXPOSED DURING CONSTRUCTION OF THE RETENTION BASIN, THE ENGINEER SHALL BE IMMEDIATELY CONTACTED. SOUTHWEST FLORIDA WATER MANAGEMENT DISTRICT MUST BE CONTACTED WITH 48 HOURS OF DISCOVERY AND CONTRACTOR MUST SUBMIT A DETAILED SINKHOLE EVALUATION AND REPAIR PLAN FOR APPROVAL BY THE DISTRICT WITHIN 30 DAYS OF DISCOVERY. A LICENSED QUALIFIED PROFESSIONAL MUST AUTHORIZE THE SINKHOLE REPAIR PLAN AND CERTIFY IT COMPLETE PRIOR TO POND CONSTRUCTION. REFERENCE SUBSECTIONS 40D-4.101(1)(e) AND 40D-4.301(1)(a), (e) AND (f), F.A.C.
15. WHERE MAILBOXES ARE TO BE RELOCATED AND/OR REMOVED, CONTRACTOR SHALL NOTIFY THE POSTMASTER OF THE OCALA POST OFFICE NO LESS THAN 7 BUSINESS DAYS (EXCLUDING WEEKENDS AND POSTAL HOLIDAYS).
16. SIDEWALKS, INCLUDING PORTIONS OF DRIVEWAYS (EXISTING OR PROPOSED) WITHIN SIDEWALK PATH, SHALL COMPLY WITH ADA ACCESSIBILITY STANDARDS. WHERE EXISTING DRIVEWAYS ARE NOT COMPLIANT, CONTRACTOR TO REMOVE AND REPLACE.
17. RESTORE AND RE-SOD ALL DISTURBED AREAS WITH ARGENTINE BAHIA IN ACCORDANCE WITH THE FDOT STANDARD SPECIFICATIONS. THE CONTRACTOR SHALL MAINTAIN THAT PORTION OF THE RIGHT-OF-WAY AFFECTED BY THE PERMIT UNTIL VEGETATION IS ESTABLISHED. PERFORM ALL WORK NECESSARY, INCLUDING WATERING AND FERTILIZING, TO SUSTAIN AN ESTABLISHED TURF UNTIL FINAL ACCEPTANCE, AT NO ADDITIONAL EXPENSE TO FDOT OR THE CITY OF OCALA. PROVIDE FILLING, LEVELING, AND REPAIRING OF ANY WASHED OR ERODED AREAS, AS MAY BE NECESSARY.
18. THE CONTRACTOR IS RESPONSIBLE FOR MOWING, AT NO ADDITIONAL EXPENSE TO FDOT OR THE CITY OF OCALA, ANY AREA WITHIN PUBLIC RIGHT-OF-WAYS WHERE THE PERMITTED WORK OR WHERE UTILITY LOCATE FLAGS PLACED FOR PERMITTED WORK CREATES A HINDRANCE FOR OR INTERFERES WITH MAINTENANCE ENTITY'S REGULAR MOWING OPERATIONS. THE CONTRACTOR SHALL BE RESPONSIBLE FOR MOWING UNTIL ALL SUCH HINDRANCES ARE REMOVED SO THAT REGULAR MAINTENANCE ENTITY MOWING CAN BE RESUMED. THE CONTRACTOR SHALL MEET THE MOWING REQUIREMENTS ESTABLISHED BY THE DEPARTMENT'S MAINTENANCE RATING PROGRAM (MRP). CONTACT THE LOCAL FDOT MAINTENANCE OFFICE FOR DETAILS (352.732.1338)
19. ALL UTILITY LOCATE FLAGS SHALL BE REMOVED BY THE CONTRACTOR WHEN THEY ARE NO LONGER NEEDED.
20. CALL "FLORIDA SUNSHINE ONE-CALL" FOR UTILITY LOCATION SERVICES AT LEAST 2 BUSINESS DAYS PRIOR TO CONSTRUCTION (1-800-432-4770).
21. ELECTRICAL SERVICE WITHIN PROJECT BOUNDARIES IS PROVIDED BY OCALA ELECTRIC UTILITY (OEU).
22. A TEMPORARY ACCESS PERMIT WILL NEED TO BE APPLIED FOR IF A CONSTRUCTION ENTRANCE TO SR 40 IS USED.
23. THE EXISTING SIDEWALK, UTILITY STRIP AND CURB WITHIN SR 40 RIGHT-OF-WAY WILL NOT BE DISTURBED.

ENVIRONMENTAL NOTES:


1. THE CITY OF OCALA OPERATES UNDER A FDEP NPDES 'GENERAL PERMIT' THAT REQUIRES THE CITY AND, IN TURN, ITS CONTRACTORS TO FOLLOW CERTAIN ENVIRONMENTAL PRACTICES AND PROCEDURES TO PREVENT THE POLLUTION OF THE CITY'S GROUNDWATER AND STORMWATER SYSTEM.
2. ALL WATER COLLECTED AND PUMPED DURING TRENCH DEWATERING ACTIVITIES SHALL BE DISPOSED OF IN UPLAND AREAS INTO DISCHARGE LOCATIONS THAT SHALL BE A MINIMUM OF 75 FEET FROM THE NEAREST WATER BODY OR WETLAND AREA TO ALLOW FOR MAXIMUM OVERLAND FILTRATION OF SOIL PARTICLES.
3. STAKED SILT SCREEN, TURBIDITY BARRIERS OR OTHER PERIMETER CONTROL METHODS APPROVED BY FDEP SHALL BE UTILIZED AS SILT BARRIERS AND PLACED IN LOCATIONS SHOWN ON THE PLANS AND AT OTHER LOCATIONS AS REQUIRED TO KEEP SEDIMENT FROM REACHING PRIVATE PROPERTY. THESE BARRIERS SHALL BE INSTALLED BEFORE COMMENCING WITH ANY CONSTRUCTION WITHIN OR ADJACENT TO PRIVATE PROPERTY. THE CONTRACTOR SHALL MONITOR AND MAINTAIN ALL SILT BARRIERS AND FENCING INCLUDING DAILY INSPECTIONS TO CHECK THEIR INTEGRITY. ANY LOOSE OR DAMAGED SILT BARRIERS AND FENCING SHALL BE IMMEDIATELY REPAIRED OR REPLACED AS NECESSARY. ONCE CONSTRUCTION IS COMPLETED AND FINISHED GRADING AND STABILIZATION HAS BEEN ACHIEVED, SILT BARRIERS AND FENCING SHALL BE COMPLETELY REMOVED TO THE SATISFACTION OF THE ENGINEER AND BEFORE FINAL ACCEPTANCE.
4. THE CONTRACTOR SHALL NOT REMOVE ANY TREES WITHOUT COORDINATING SUCH REMOVAL WITH THE ENGINEER. IF ANY TREES ARE REMOVED IN WETLAND JURISDICTIONAL, OR NATIVE VEGETATION AREAS WITHOUT PROPER AUTHORIZATION, CONTRACTOR SHALL BE RESPONSIBLE FOR PREPARING A DETAILED RESTORATION AND/OR MITIGATION PLAN, SUBMITTING PLAN TO AND OBTAINING APPROVAL FROM FDEP, WATER MANAGEMENT DISTRICT, CITY, OWNER AND ENGINEER, AND COMPLETING ANY MONITORING AND MAINTENANCE REQUIREMENTS IMPOSED AS A RESULT OF TREE REMOVAL.

THE CONTRACTOR SHALL:

5. HANDLE, COLLECT, AND DISPOSE OF HAZARDOUS MATERIALS, SANITARY WASTE, AND CONSTRUCTION WASTE MATERIALS ACCORDING TO THE APPLICABLE STATE LAWS AND REGULATIONS, CITY ORDINANCES, OR AS DIRECTED BY THE CITY.
6. DESIGNATE AN AREA FOR DISCHARGE OF SURPLUS CONCRETE AND CONCRETE TRUCK DRUM WASH WATER. INSTALL A CONTAINMENT BERM AROUND THIS DESIGNATED AREA TO PREVENT RUNOFF BEYOND THE DESIGNATED AREA. ALL SURPLUS CONCRETE SHALL BE REMOVED FROM THE PROJECT SITE PRIOR TO FINAL INSPECTION.
7. STORE AND USE PETROLEUM AND OTHER HAZARDOUS PRODUCTS ACCORDING TO RECOMMENDED PROCEDURES.
8. FOLLOW GOOD HOUSEKEEPING PRACTICES TO MINIMIZE THE RISK OF SPILLS OR UNINTENDED EXPOSURE OF PETROLEUM AND OTHER HAZARDOUS MATERIALS TO STORMWATER RUNOFF OR SEEPAGE INTO THE GROUNDWATER.
9. HAVE PRE-PREPARED PROCEDURES CLEARLY POSTED FOR SPILL CONTAINMENT AND CLEAN-UP.
10. HAVE READILY AVAILABLE REMEDIATION MATERIALS FOR SPILL CONTAINMENT AND CLEAN-UP.
11. UPON RELEASE, IMMEDIATELY INITIATE RECOMMENDED METHODS FOR SPILL CONTAINMENT AND CLEAN-UP.
12. WITHIN 24-HOURS OF THE SPILL/RELEASE, NOTIFY THE 'STATE WARNING POINT' (AT 1.800.320.0519 OR 1.850.413.9911) OF ALL RELEASES EQUAL TO OR EXCEEDING THE REPORTABLE QUANTITY.


SIGNAGE AND STRIPING NOTES:

1. THE CONTRACTOR SHALL CONTACT THE CITY OF OCALA PUBLIC WORKS DEPT. - TRAFFIC OPERATIONS (352) 351-6733 48 HOURS PRIOR TO COMMENCEMENT. THE CONTRACTOR SHALL CONTACT THE LOCAL FLORIDA DEPARTMENT OF TRANSPORTATION MAINTENANCE OFFICE 48 HOURS PRIOR TO CONSTRUCTION NEAR W SILVER SPRINGS BLVD. (SR 40). ALL ITEMS THAT REQUIRE RELOCATION OR REPLACEMENT WILL BE THE RESPONSIBILITY OF THE CONTRACTOR.
2. ALL SIGN ASSEMBLIES AND SIGN PANELS TO BE RELOCATED SHALL BE RELOCATED OUT OF THE CONSTRUCTION AREA, THEN RE-INSTALLED AFTER CONSTRUCTION IS COMPLETED. ANY DAMAGED SIGNAGE SHALL BE REPLACED AT CONTRACTOR'S EXPENSE.
3. CONTRACTOR TO REPAIR OR REPLACE ALL PAVEMENT MARKINGS, TRAFFIC LOOPS OR HOMERUNS OUTSIDE OF THE PROJECT AREA THAT ARE DAMAGED DURING CONSTRUCTION.
4. TEMPORARY STRIPING AND MARKING SHALL BE PART OF THIS CONTRACT AND SHALL BE IN ACCORDANCE WITH THE MANUAL OF UNIFORM TRAFFIC CONTROL DEVICES. TEMPORARY STRIPING SHALL BE WATER-BASED PAINT. TEMPORARY STOP LINES SHALL BE INSTALLED IMMEDIATELY AFTER NEW SURFACE IS IN PLACE WHERE STOP LINES ARE SHOWN ON THE PLANS; ALL OTHER TEMPORARY STRIPING AND MARKING SHALL BE INSTALLED AS SOON AS POSSIBLE AFTER NEW SURFACE IS IN PLACE. CONTRACTOR SHALL BE PAID FOR ONLY ONE APPLICATION OF TEMPORARY STRIPING PER ITEM. TEMPORARY STRIPING AND MARKING UTILIZED FOR TEMPORARY TRAFFIC CONTROL SHALL BE PART OF THE TEMPORARY TRAFFIC CONTROL SCHEDULE.
5. THERMOPLASTIC STRIPING, AS DEFINED UNDER FLORIDA DEPARTMENT OF TRANSPORTATION STANDARD SPECIFICATION FOR ROAD AND BRIDGE CONSTRUCTION #711, IS REQUIRED FOR FINISHED CONSTRUCTION ON CITY OF OCALA RIGHTS OF WAY. WHERE ROADWAY PAVEMENT IS INSTALLED OR REPLACED, THERMOPLASTIC STRIPING SHALL BE INSTALLED AT LEAST 14 DAYS AFTER FINAL PAVING; OTHERWISE THERMOPLASTIC STRIPING IS TO BE INSTALLED CONCURRENT TO OTHER PROJECT WORK. CONTRACTOR SHALL BE PAID FOR ONLY ONE APPLICATION OF THERMOPLASTIC STRIPING PER ITEM.
6. WHERE CROSSWALKS ARE PROPOSED, CONTRACTOR TO ENSURE THAT ANY EXISTING STOP LINES ARE MIN. 4' FROM THE PROPOSED CROSSWALK LINES.

REVISIONS				NOEL JOHN COOPER, P.E. P.E. LICENSE NUMBER 69534 STATE OF FLORIDA, DATE: _____ VALID ONLY WITH EMBOSSED SEAL.	PREPARED BY	NW 44th AVENUE EXTENSION PHASE 2	SHEET NO.
DATE	DESCRIPTION	DATE	DESCRIPTION			<h1 style="text-align: center;">GENERAL NOTES</h1>	5
3/6/23	ADDED GENERAL NOTE #22						
4/6/23	Revised general note #1						

EROSION CONTROL NOTES:

1. THE CONTRACTOR SHALL PREVENT THE DISCHARGE OF SEDIMENT DUE TO CONSTRUCTION OPERATIONS. ALL NEW AND EXISTING DRAIN PIPES AND STRUCTURES SHALL BE FLUSHED CLEAN PRIOR TO FINAL PAYMENT.
2. ALL STORM SEWER INLETS SHALL BE PROTECTED SO THAT SEDIMENT LADEN WATER WILL NOT ENTER THE STORM SYSTEM WITHOUT FIRST BEING FILTERED.
3. ALL DISTURBED AREAS ARE TO BE SODDED. ALL STABILIZATION PRACTICES SHALL BE PERFORMED AS SOON AS PRACTICAL AT LOCATIONS WHERE CONSTRUCTION ACTIVITIES HAVE TEMPORARILY OR PERMANENTLY CEASED. PERMANENT VEGETATION SHALL NOT BE CONSIDERED ESTABLISHED UNTIL GROUND COVER IS ACHIEVED AND, IN THE OPINION OF THE ENGINEER, PROVIDES ADEQUATE COVER AND IS MATURE ENOUGH TO CONTROL SOIL EROSION SATISFACTORILY, TO SURVIVE ADVERSE WEATHER CONDITIONS.
4. STAKED SILT FENCE SHALL BE PLACED IN ACCORDANCE WITH CITY OF OCALA SPECIFICATIONS.
5. THE CONTRACTOR WILL PROVIDE LITTER CONTROL AND COLLECTION WITHIN THE PROJECT BOUNDARIES DURING CONSTRUCTION ACTIVITIES. ALL FERTILIZERS, HYDROCARBON, OR OTHER CHEMICAL CONTAINERS SHALL BE DISPOSED OF BY THE CONTRACTOR ACCORDING TO EPA'S STANDARD PRACTICES AS DETAILED BY THE MANUFACTURER.
6. LOADED HAUL TRUCKS SHALL BE COVERED WITH TARPULIN. EXCESS DIRT ON THE ROAD SHALL BE REMOVED DAILY. AREAS WITHIN THE LIMITS OF CONSTRUCTION SHALL BE DAMPENED WITH WATER AS REQUIRED FOR DUST CONTROL.
7. THE CONTRACTOR WILL ADHERE TO ALL STATE AND LOCAL REGULATIONS.
8. THE CONTRACTOR WILL BE RESPONSIBLE FOR THE MAINTENANCE AND REPAIRS OF EROSION AND SEDIMENT CONTROL DEVICES, AND REMOVAL OF EROSION AND SEDIMENT CONTROL DEVICES AFTER THE NOTICE OF TERMINATION. MAINTENANCE AND REPAIR REQUIRED FOR THE CONTROL AND ABATEMENT OF EROSION AND WATER POLLUTION SHALL BE INCLUDED IN THE PROJECT COST.
9. TOXIC SUBSTANCES SHALL BE DISPOSED OF BY THE CONTRACTOR ACCORDING TO THE EPA'S STANDARD PRACTICES.
10. THE FOLLOWING PRACTICES WILL BE USED TO MAINTAIN EROSION AND SEDIMENT CONTROLS:
 - A. ALL MEASURES WILL BE MAINTAINED IN GOOD WORKING ORDER.
 - B. IF A REPAIR IS NECESSARY, IT WILL BE INITIATED WITHIN 24 HOURS OF REPORT.
 - C. ALL POLLUTION CONTROLS SHALL BE MAINTAINED AT ALL TIMES.
 - D. BUILT UP SEDIMENT WILL BE REMOVED FROM STAKED SILT FENCE WHEN IT HAS REACHED ONE-HALF THE HEIGHT OF THE SILT FENCE.
11. POLLUTION CONTROL MEASURES SHALL BE INSPECTED DAILY. WRITTEN DOCUMENTATION OF INSPECTIONS SHALL BE WRITTEN EVERY SEVEN CALENDAR DAYS AND WITHIN 24 HOURS OF A RAIN EVENT OF 0.5 INCHES OR GREATER.
12. THE CONTRACTOR WILL PROVIDE THE CITY OF OCALA WITH AN EROSION CONTROL PLAN THAT WILL INCLUDE SPILL REPORTING AND RESPONSE. IF CONTAMINATED SOIL OR GROUNDWATER IS ENCOUNTERED, CONTACT THE PROJECT ENGINEER.


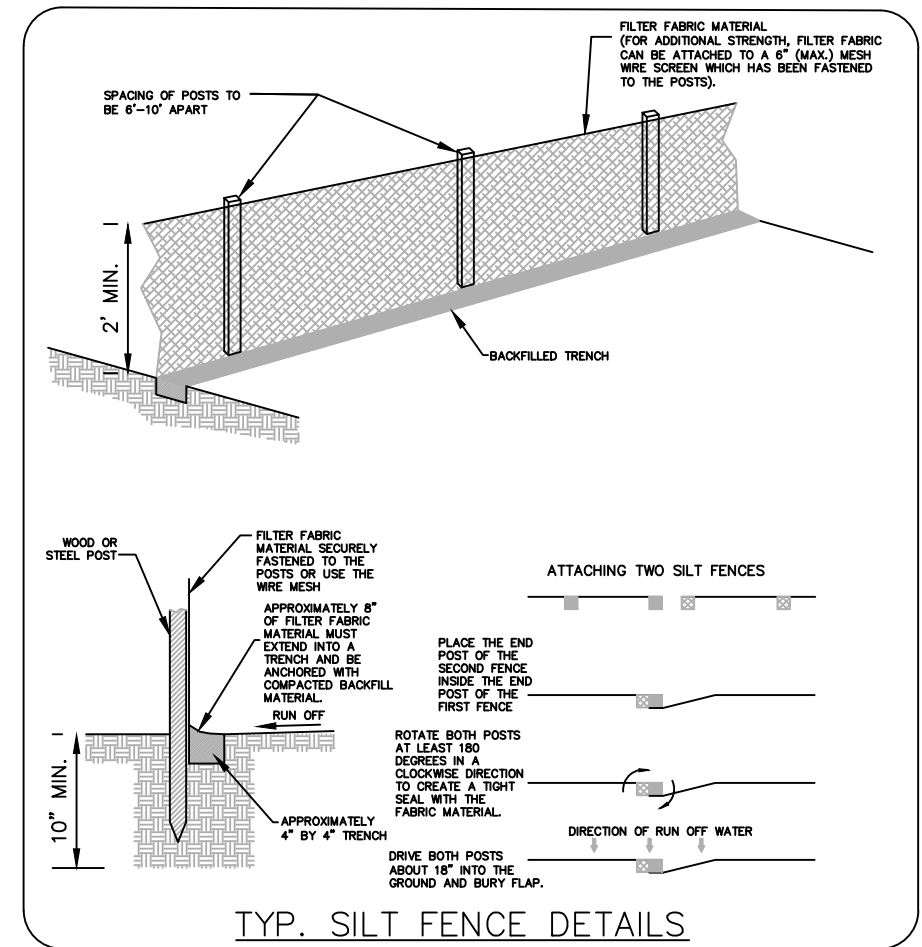


SURVEY & MAPPING NOTES:

1. COORDINATES AND BEARINGS SHOWN HEREON ARE BASED ON FLORIDA STATE PLANE COORDINATES, WEST ZONE AND WERE DERIVED FROM GPS OBSERVATIONS REFERENCED TO THE FDOT PERMANENT REFERENCE NETWORK.
2. ELEVATIONS SHOWN HEREON ARE BASED ON NATIONAL GEODETIC VERTICAL DATUM OF 1929 AND ARE REFERENCED TO CITY CONTROL POINTS SHOWN ON THIS DRAWING.
3. IT IS THE RESPONSIBILITY OF THE CONTRACTOR, PRIOR TO THE COMMENCEMENT OF CONSTRUCTION, TO ENSURE ALL EXISTING SURVEY MARKERS ARE LOCATED, CLEARLY MARKED AND PROTECTED, BY THE CONTRACTOR'S SURVEYOR.
4. ANY SURVEY MARKER, INCLUDING, BUT NOT LIMITED TO, PUBLIC LAND SURVEY SECTION CORNER MARKERS, BENCH MARKS, PROPERTY CORNERS, ETC., WHICH ARE DISTURBED DURING CONSTRUCTION SHALL BE REPLACED AT THE CONTRACTOR'S EXPENSE PRIOR TO FINAL PAYMENT.
5. ADDITIONALLY, SURVEY STAKES PLACED MARKING THE LOCATIONS OF MARKERS, PROPERTY LINES, RIGHT-OF-WAY LINES, OR ANY OTHER POINT, PLACED FOR CONSTRUCTION AND SUBSEQUENTLY DISTURBED OR DESTROYED DURING CONSTRUCTION SHALL BE REPLACED AS NEEDED AT THE RESPONSIBILITY OF THE CONTRACTOR.
6. RESETTLEMENT OF MONUMENTS AND MARKERS SHALL BE PERFORMED BY A PROFESSIONAL LAND SURVEYOR, LICENSED TO PRACTICE IN THE STATE OF FLORIDA AND SHOWN AS RE-SET ON AS-BUILT PLANS.
7. UNLESS PRIOR AGREEMENT IS MADE, IT SHALL NOT BE THE RESPONSIBILITY OF THE CITY SURVEYOR TO REPLACE ANY SURVEY MARKERS.

NOTES

1. PLACE CURB TYPE SEDIMENT BARRIERS ON GENTLY SLOPING STREET SEDIMENTS WHERE WATER CAN POND AND ALLOW SEDIMENT TO SEPARATE FROM RUNOFF.
2. SANDBAGS, OF EITHER BURLAP OR WOVEN GEOTEXTILE FABRIC, ARE FILLED WITH GRAVEL, LAYERED AND PACKED TIGHTLY.
3. LEAVE ONE SANDBAG GAP IN THE TOP ROW TO PROVIDE A SPILLWAY FOR OVERFLOW.
4. INSPECT BARRIERS AND REMOVE SEDIMENT AFTER EACH STORM EVENT. SEDIMENT AND GRAVEL MUST BE REMOVED FROM THE TRAVELED WAY IMMEDIATELY.

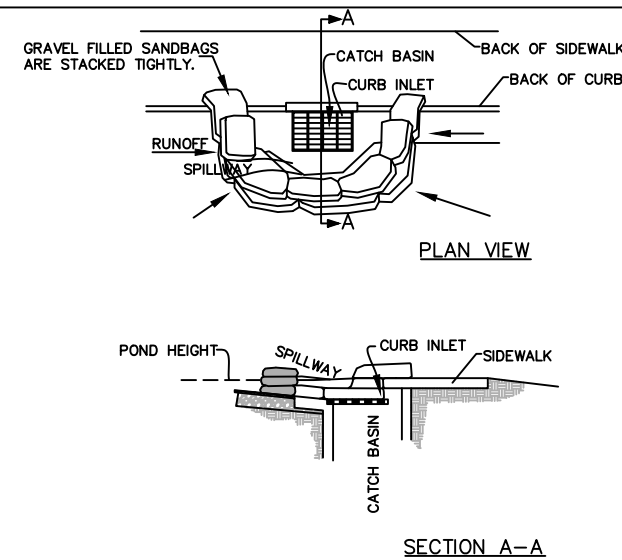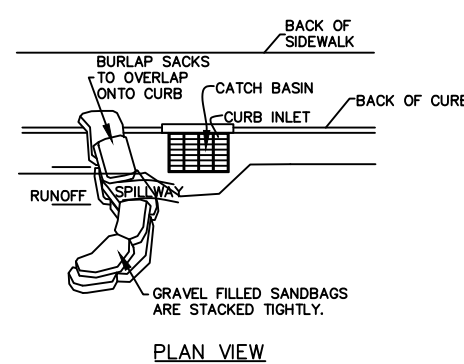

CURB AND GUTTER SEDIMENT BARRIER

1. PLACE GRAVEL FILLED BURLAP BAGS ON GENTLY SLOPING STREET SEGMENTS ACCORDING TO THE SPACING CHART. (SEE PLATE 4.08p)
2. PLACE TWO OR MORE BAGS AT EACH INTERVAL IN A MANNER WHICH PROVIDES MAXIMUM SUPPORT
3. WHEN STACKING SEVERAL BAGS HIGH, LEAVE A ONE BAG GAP TO PROVIDE AN OVERFLOW SPILLWAY.
4. SEDIMENTS MUST BE REMOVED AFTER EACH RAIN EVENT.

MAINTENANCE

1. THE STRUCTURE SHALL BE INSPECTED AFTER EACH RAIN AND REPAIR MADE AS NEEDED.
2. SEDIMENT SHALL BE REMOVED AND THE TRAP RESTORED TO ITS ORIGINAL DIMENSIONS WHEN THE SEDIMENT HAS TO 1/2 OF THE DESIGN DEPTH OF THE TRAP. REMOVED SEDIMENT SHALL BE DEPOSITED IN A SUITABLE AREA AND IN SUCH A MANNER THAT IT WILL NOT ERODE.
3. STRUCTURES SHALL BE REMOVED AND THE AREA STABILIZED WHEN THE REMAINING DRAINAGE AREA HAS BEEN PROPERLY STABILIZED.

CURB INLET SEDIMENT BARRIER

REVISIONS				NOEL JOHN COOPER, P.E. P.E. LICENSE NUMBER 69534 STATE OF FLORIDA, DATE: _____ VALID ONLY WITH EMBOSSED SEAL.	PREPARED BY OCALA CITY ENGINEER'S OFFICE	NW 44th AVENUE EXTENSION PHASE 2	SHEET NO. 6
DATE	DESCRIPTION	DATE	DESCRIPTION				
----	----	----	----			GENERAL NOTES	

ABBREVIATIONS & SYMBOLOGY

	CM	CONCRETE MONUMENT
	PP	POWER POLE
	LP	LAMP POLE
	GA	GUY ANCHOR
		SIGN
	MB	MAILBOX OR NEWSPAPER BOX
		TELEPHONE RISER
		TELEPHONE MANHOLE
	STM. MH	STORM MANHOLE
		CATCH BASIN
	WV	WATER VALVE
	WM	WATER METER
	FH	FIRE HYDRANT
	GV	GATE VALVE
		SANITARY MANHOLE
		SANITARY CLEANOUT
	PGL	PROFILE GRADE LINE

MES	MITERED END SECTION		
EXIST.	EXISTING		
PROP.	PROPOSED		
TYP.	TYPICAL		
MTL	METAL		
WD	WOOD		
TOB	TOP OF BANK		
TOE	TOE OF SLOPE		
WRA	WET RETENTION AREA		
DRA	DRY RETENTION AREA		
ERCP	ELLIPTICAL REINFORCED CONCRETE PIPE		
CMP	CORRUGATED METAL PIPE		
PED	PEDESTRIAN		
FDOT	FLORIDA DEPARTMENT OF TRANSPORTATION		
SPI	STANDARD PLANS INDEX (NUMBER)		
MUTCD	MANUAL ON UNIFORM TRAFFIC CONTROL DEVICES	GR	TL-3 GUARDRAIL (W-BEAM W/ TIMBER POSTS)
BOS	BACK OF SIDEWALK	COO	CITY OF OCALA
QTY	QUANTITY	CP	CONTROL POINT
NO.	NUMBER	CIRC	(CONTROL) IRON ROD AND CAP
CONST.	CONSTRUCT / INSTALL	CNL	(CONTROL) NAIL AND DISC
SWK	SIDEWALK	BM/BMK	BENCHMARK
UE	UTILITY EASEMENT	COED	CITY OF OCALA ENGINEERING DEPARTMENT
TCE	TEMPORARY CONSTRUCTION EASEMENT	ELEV.	ELEVATION (NGVD)

LEGEND


	EXISTING DRAINAGE PIPE		PROPOSED DRAINAGE PIPE
	EDGE OF EXISTING CURB		EDGE OF PROPOSED CURB
	EDGE OF EXISTING SIDEWALK		EDGE OF PROPOSED SIDEWALK
	EDGE OF EXISTING DRIVEWAY (ALL TYPES)		EDGE OF PROPOSED DRIVEWAY (ALL TYPES)
	EXISTING FENCES		PROPOSED FENCES
	EXISTING OVERHEAD POWER		PROPOSED OVERHEAD POWER
	EXISTING TOP OF BANK/TOE OF SLOPE		PROPOSED GRAVITY WALL
	EXISTING POTABLE WATER		PROPOSED POTABLE WATER
	EXISTING GRAVITY SANITARY SEWER		PROPOSED GRAVITY SANITARY SEWER
	EXISTING SANITARY FORCE MAIN		PROPOSED PEDESTRIAN HANDRAIL
	EXISTING BURIED TELEPHONE LINE		PROPOSED TL-3 GUARDRAIL
	EXISTING BURIED NATURAL GAS LINE		
	RIGHT-OF-WAY LINE		
	EXISTING PROPERTY LINE		
	EDGE OF EXISTING PAVEMENT		EDGE OF PROPOSED PAVEMENT
	EXISTING STRIPING TO BE RETAINED		PROPOSED STRIPING
	PALM TREE		
	OAK TREE		
	OTHER TREES (NOTE: NOT ALL INCLUSIVE)		

THE HATCHING AND SYMBOLOGY WITHIN THE ROADWAY PLAN SHEETS ARE DEFINED AS FOLLOWS:

	4" CONCRETE (MIN. 3,000 PSI)		PROPOSED 2" SP-12.5 ASPHALT PAVEMENT FOR STABILIZATION OF GUARDRAIL
	6" CONCRETE W/ FIBER MESH REINFORCEMENT (MIN. 3,000 PSI)		PROPOSED ASPHALT PAVEMENT AND LIMEROCK BASE PER TYPICAL SECTIONS (SHEET 11)
	DETECTABLE WARNING SURFACE (RED BRICK COLOR WHERE APPLICABLE)		MILL EXIST. ASPHALT PAVEMENT AND RETAIN EXIST. LIMEROCK. ADD 2 LIFTS SP-12.5 OF VARYING BUT EQUAL DEPTH TO 1" BELOW PROP. GRADE. ADD 1" FC-9.5.

REVISIONS				NOEL JOHN COOPER, P.E. P.E. LICENSE NUMBER 69534 STATE OF FLORIDA, DATE: _____ VALID ONLY WITH EMBOSSED SEAL.		NW 44th AVENUE EXTENSION PHASE 2		SHEET NO. 7
DATE	DESCRIPTION	DATE	DESCRIPTION			<p style="text-align: center;">LEGEND AND ABBREVIATIONS</p>		
4/6/23	Revised legend							

THE OFFICIAL RECORD OF THIS SHEET IS THE ELECTRONIC FILE DIGITALLY SIGNED AND SEALED UNDER RULE 61G15-23.004, F.A.C.

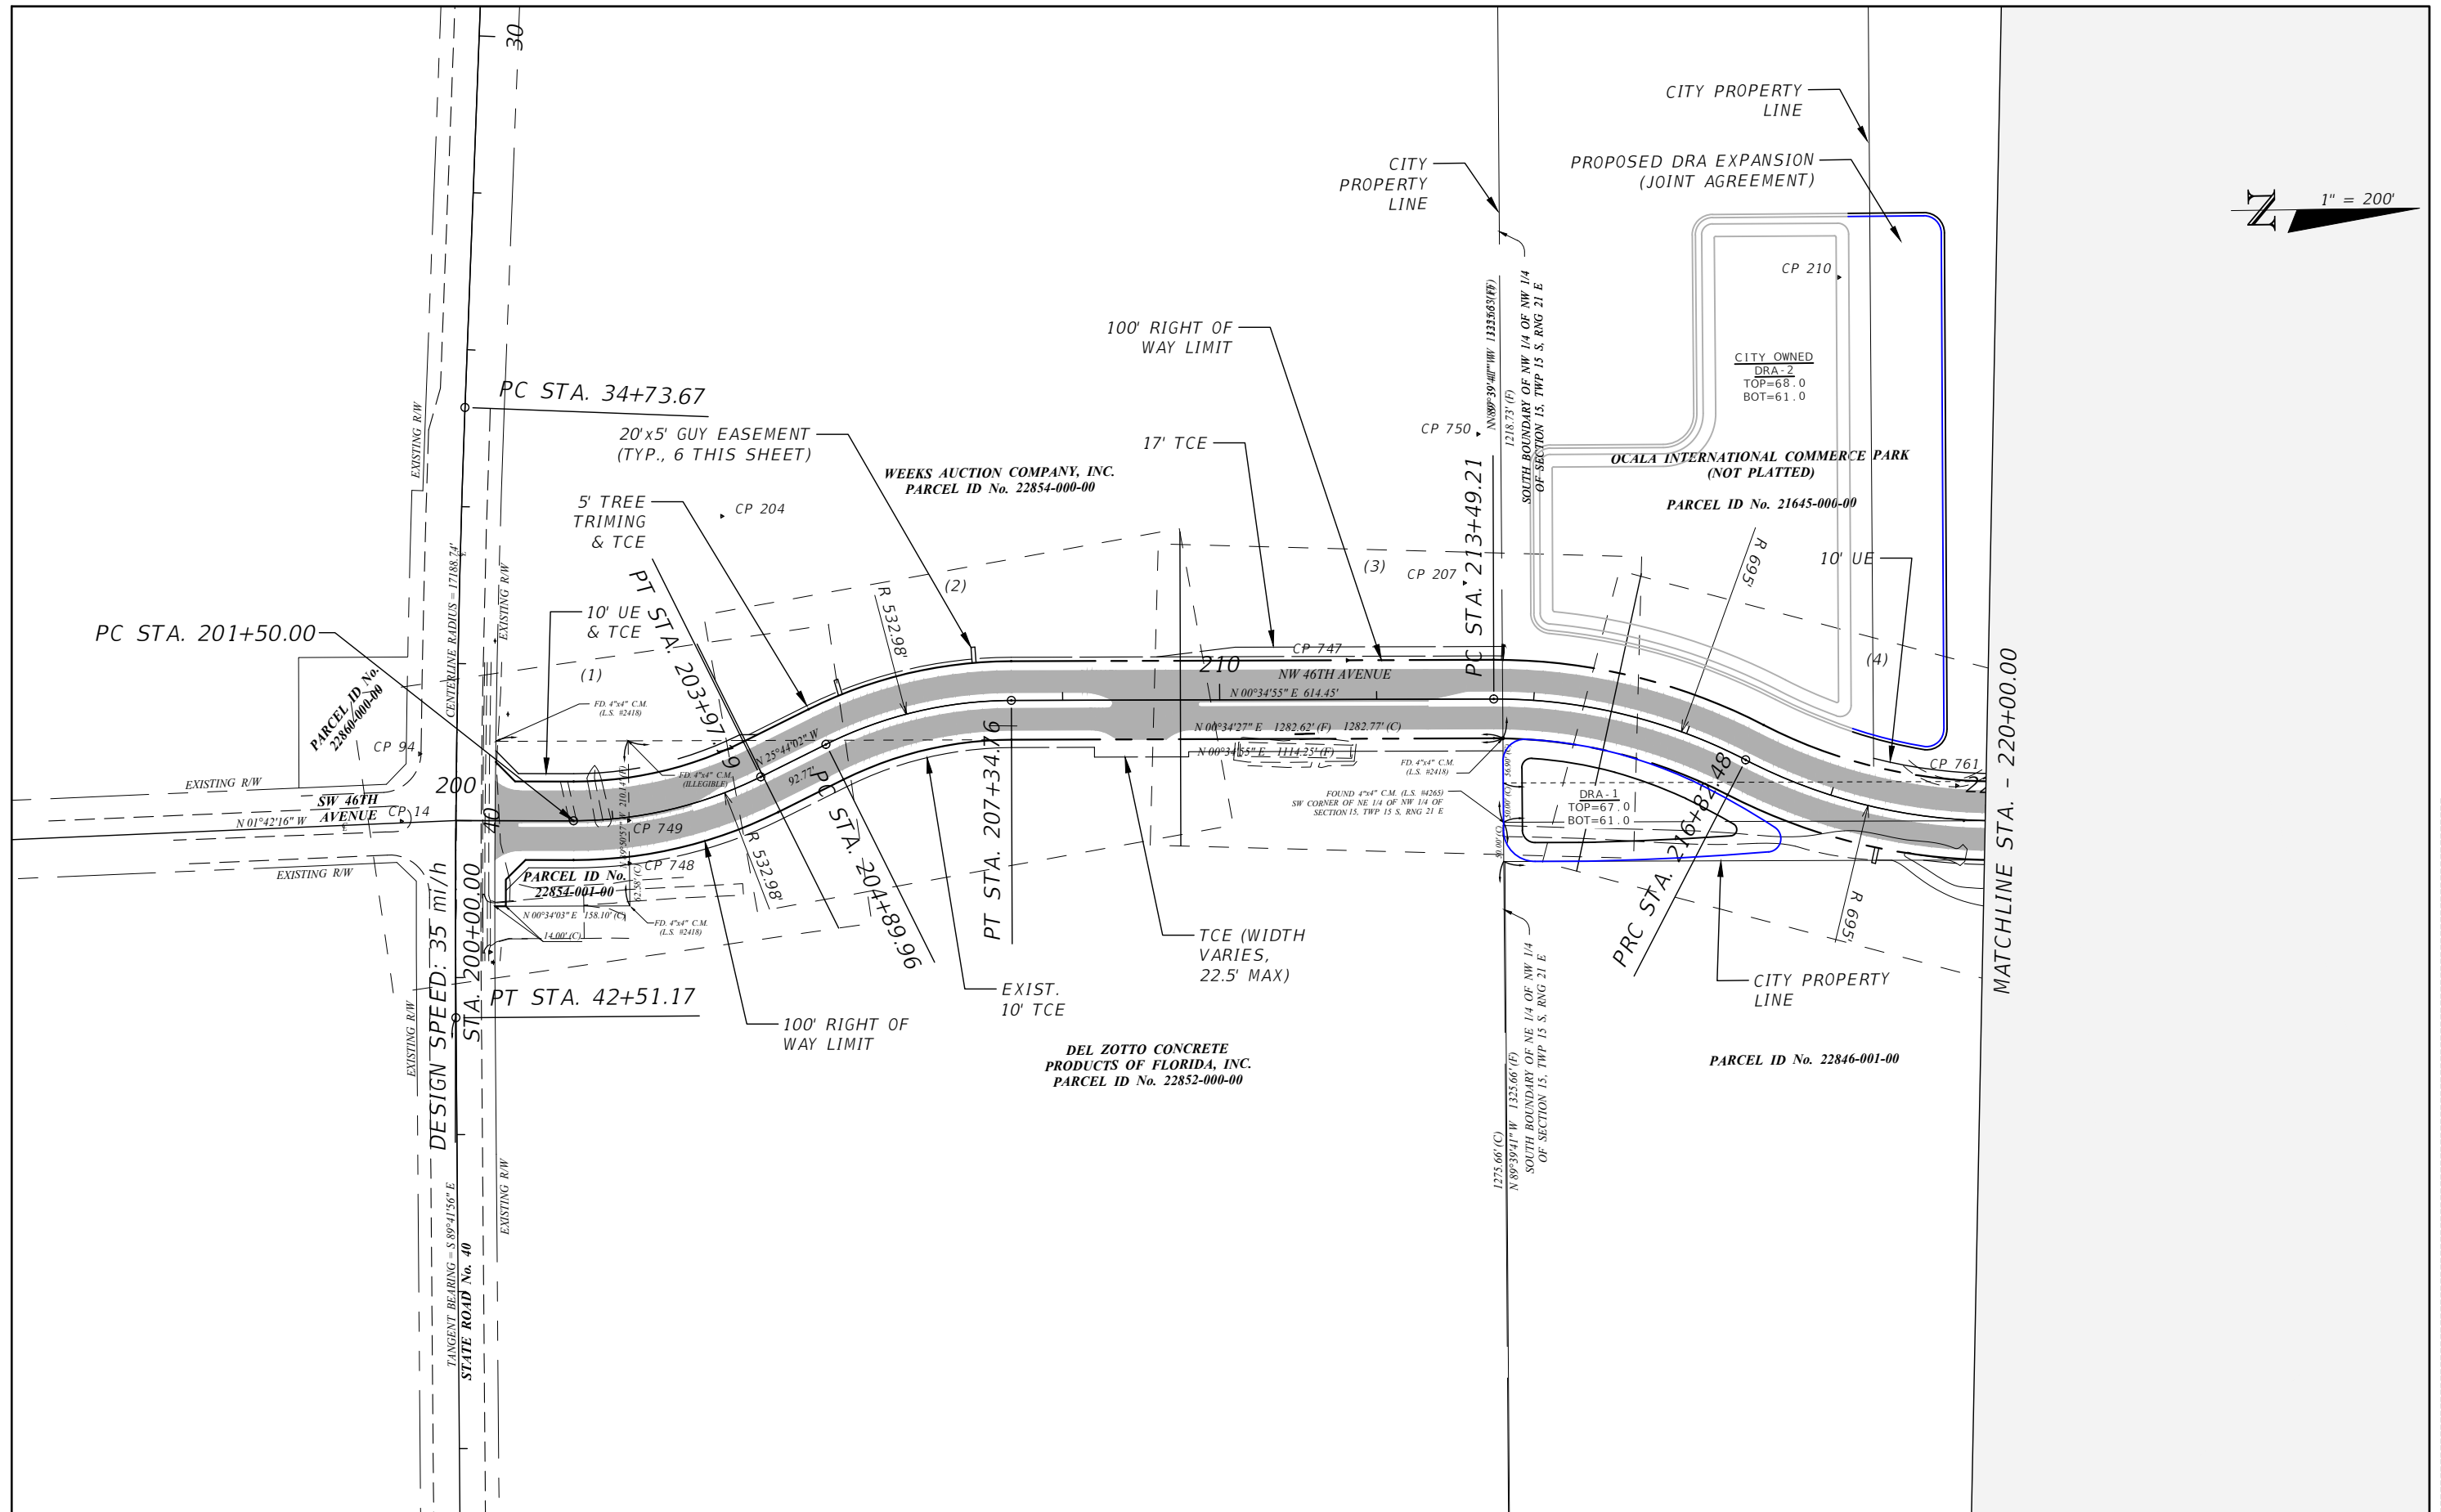

REVISIONS	
DATE	DESCRIPTION
1/24/23	REVISED TCE & PROPERTY LINE REFERENCES
3/23/23	REVISED STARTING LINE OF PROJECT AT S.R. 40

NOEL JOHN COOPER, P.E.
 P.E. LICENSE NUMBER 69534
 STATE OF FLORIDA, DATE: _____
 VALID ONLY WITH EMBOSSED SEAL.

PREPARED BY



Gary Anson

NW 44th AVENUE EXTENSION PHASE 2

PROJECT OVERVIEW (1)

SHEET NO.
8

16
15
10

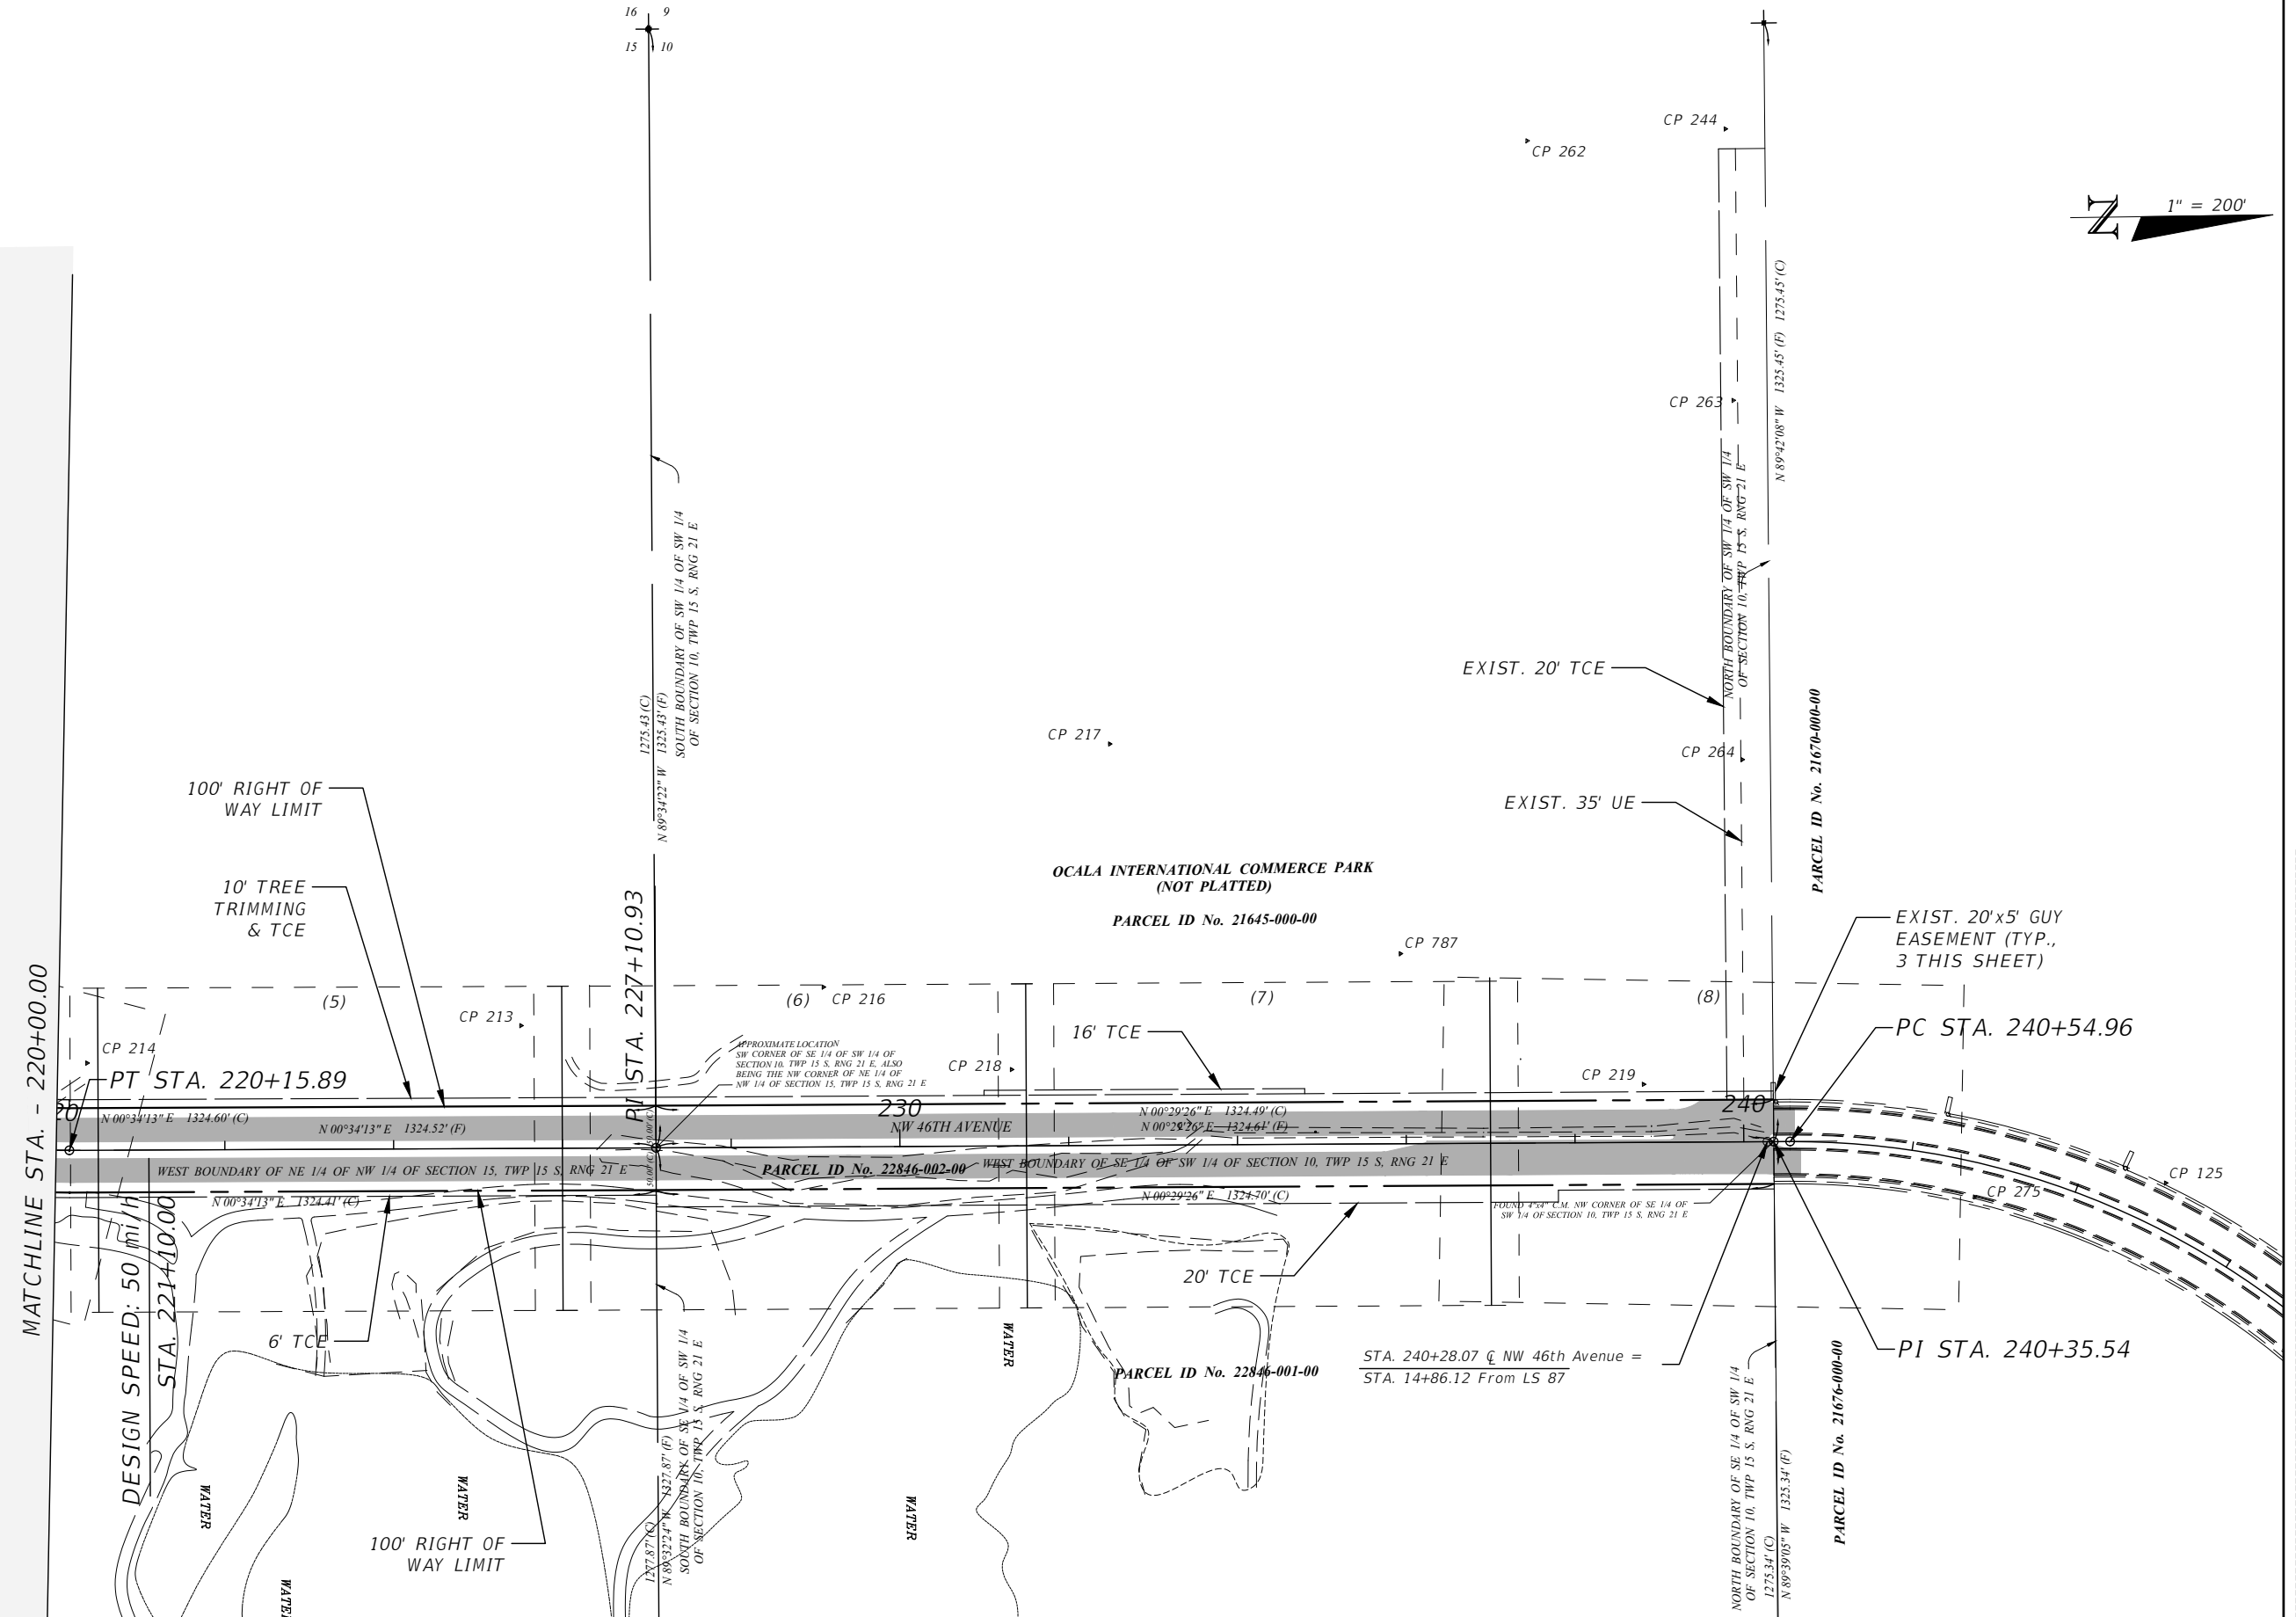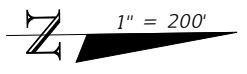

MATCHLINE STA. - 220+00.00

DESIGN SPEED: 50 mph
STA. 221+10.00

PI STA. 227+10.93

PARCEL ID No. 21670-000-00

PC STA. 240+54.96

PI STA. 240+35.54

STA. 240+28.07 @ NW 46th Avenue =
STA. 14+86.12 From LS 87

REVISIONS			
DATE	DESCRIPTION	DATE	DESCRIPTION

NOEL JOHN COOPER, P.E.
P.E. LICENSE NUMBER 69534
STATE OF FLORIDA, DATE: _____
VALID ONLY WITH EMBOSSED SEAL.

PREPARED BY


NW 44th AVENUE EXTENSION PHASE 2


PROJECT OVERVIEW (2)

SHEET NO.
9


Point Table

PT. NO.	POINT DESCRIPTION	(X) EASTING	(Y) NORTHING	SCALE FACTOR	CONVERGENCE	LATITUDE	LONGITUDE	BASELINE STATION	OFFSET	(Z) (NGVD) ELEVATION
14	CIRC /C00 CP	593057.149	1764044.513	0.99994574	-000° 05' 47"	029° 11' 10.285"	-082° 11' 52.012"	40+01.30	69.38 Rt	70.42
94	CNL /C00BM AKA TP23	592971.643	1764069.038	0.99994575	-000° 05' 48"	029° 11' 10.526"	-082° 11' 52.977"	39+15.56	46.76 Rt	71.34
125	CIRC /C0ED FD	593156.732	1768561.020	0.99994573	-000° 05' 47"	029° 11' 55.001"	-082° 11' 50.974"	244+91.77	52.17 Lt	66.08
204	CIRC /C00CP	592673.961	1764457.748	0.99994580	-000° 05' 49"	029° 11' 14.370"	-082° 11' 56.343"	204+96.71	319.43 Lt	73.77
207	CIRC /C00CP	592771.366	1765402.477	0.99994578	-000° 05' 49"	029° 11' 23.724"	-082° 11' 55.262"	213+12.25	148.01 Lt	65.52
210	IRC /C00CP	592388.279	1765884.374	0.99994584	-000° 05' 51"	029° 11' 28.489"	-082° 11' 59.593"	215+88.31	612.59 Lt	68.39
213	CIRC /C00CP	592942.820	1766614.792	0.99994576	-000° 05' 48"	029° 11' 35.730"	-082° 11' 53.351"	225+51.53	145.54 Lt	76.44
214	CIRC /C00CP	592979.910	1766100.013	0.99994575	-000° 05' 48"	029° 11' 30.634"	-082° 11' 52.922"	220+37.14	103.33 Lt	71.79
216	CIRC /C00CP	592902.278	1766973.743	0.99994576	-000° 05' 48"	029° 11' 39.283"	-082° 11' 53.815"	229+10.32	189.38 Lt	75.94
217	CIRC /C00CP	592619.060	1767317.157	0.99994580	-000° 05' 50"	029° 11' 42.678"	-082° 11' 57.017"	232+51.30	475.52 Lt	71.65
218	CIRC /C00CP	593003.072	1767195.348	0.99994575	-000° 05' 48"	029° 11' 41.478"	-082° 11' 52.682"	231+32.78	90.48 Lt	72.84
219	CIRC /C00CP	593031.056	1767943.948	0.99994574	-000° 05' 48"	029° 11' 48.890"	-082° 11' 52.380"	238+81.59	68.91 Lt	72.24
244	CIRC /C00CP	591900.780	1768056.893	0.99994591	-000° 05' 54"	029° 11' 49.989"	-082° 12' 05.136"	2+53.18	6.86 Lt	64.23
262	CNL /C00BM AKA TP10	591911.517	1767821.835	0.99994591	-000° 05' 54"	029° 11' 47.662"	-082° 12' 05.010"	0+18.35	8.19 Rt	65.90
263	CNL /C00CP AKATP8	592222.451	1768061.667	0.99994586	-000° 05' 52"	029° 11' 50.042"	-082° 12' 01.506"	6+07.33	33.32 Rt	65.76
264	CIRC /C00CP AKA TP7	592648.132	1768066.334	0.99994580	-000° 05' 50"	029° 11' 50.095"	-082° 11' 56.703"	10+33.17	26.16 Rt	71.61
275	CNL /C00BM AKA TBMK1	593170.140	1768334.533	0.99994572	-000° 05' 47"	029° 11' 52.759"	-082° 11' 50.818"	242+85.22	40.31 Rt	66.53
287	CIRC /C00CP	593225.244	1764155.647	0.99994572	-000° 05' 46"	029° 11' 11.388"	-082° 11' 50.117"	41+67.59	44.26 Lt	68.69
747	CIRC /SET 5/8" C00 CP	592867.893	1765252.128	0.99994577	-000° 05' 48"	029° 11' 22.237"	-082° 11' 54.170"	211+62.89	49.96 Lt	64.25
748	CIRC /C00CP	593114.478	1764334.070	0.99994573	-000° 05' 47"	029° 11' 13.153"	-082° 11' 51.370"	202+14.14	58.30 Rt	68.33
749	CIRC /C00CP	593059.950	1764334.028	0.99994574	-000° 05' 47"	029° 11' 13.151"	-082° 11' 51.986"	202+19.80	4.10 Rt	69.50
750	CIRC /SET 5/8" C00 CP	592581.981	1765422.256	0.99994581	-000° 05' 50"	029° 11' 23.917"	-082° 11' 57.399"	213+30.11	337.58 Lt	66.90
761	CIRC /C00 CP	593037.690	1766026.318	0.99994574	-000° 05' 47"	029° 11' 29.905"	-082° 11' 52.269"	219+60.57	42.75 Lt	71.23
787	CIRC /SET C00CP	592872.323	1767658.140	0.99994577	-000° 05' 48"	029° 11' 46.058"	-082° 11' 54.166"	235+94.44	225.19 Lt	73.63


REVISIONS				NOEL JOHN COOPER, P.E. P.E. LICENSE NUMBER 69534 STATE OF FLORIDA, DATE: _____ VALID ONLY WITH EMBOSSED SEAL.	PREPARED BY 	SW/NW 44th AVENUE EXTENSION PHASE 2 SURVEY CONTROL POINTS	SHEET NO. 10
DATE	DESCRIPTION	DATE	DESCRIPTION				
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NW 46TH AVENUE
 MAINLINE SECTION
 GRADES AS NOTED IN TABLE ON SHEET 12

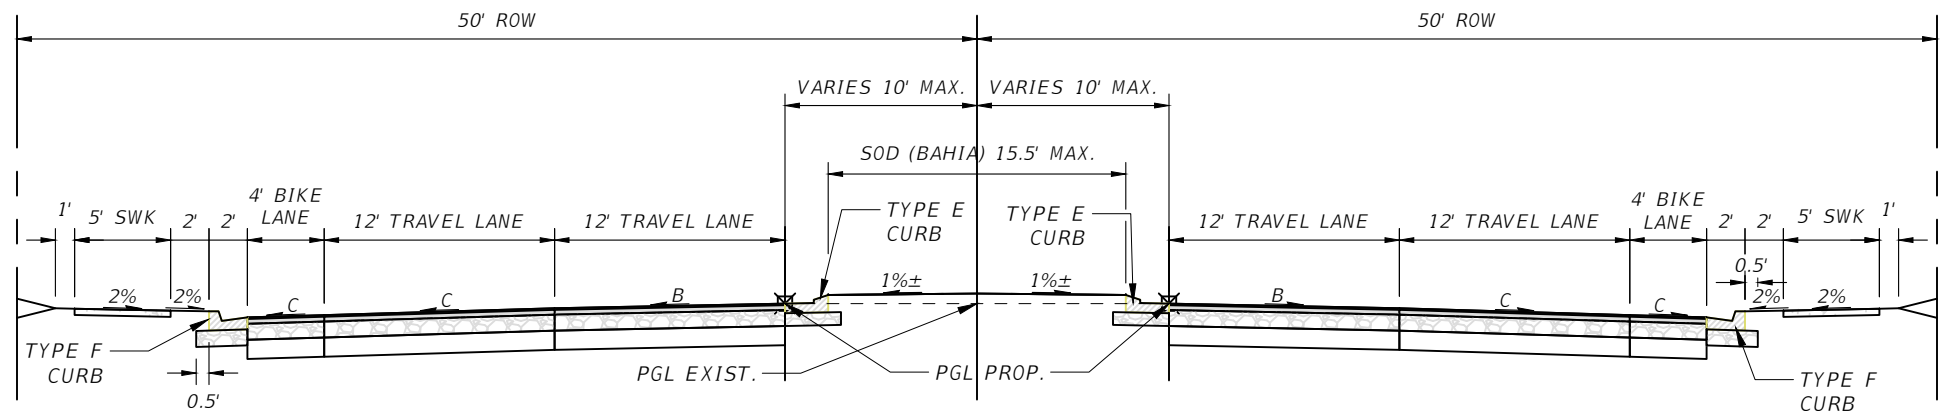


NW 46TH AVENUE
 NORTHBOUND LEFT TURN LANE SECTION
 (MIRROR FOR SOUTHBOUND LEFT TURN LANE)
 GRADES AS NOTED IN TABLE ON SHEET 12

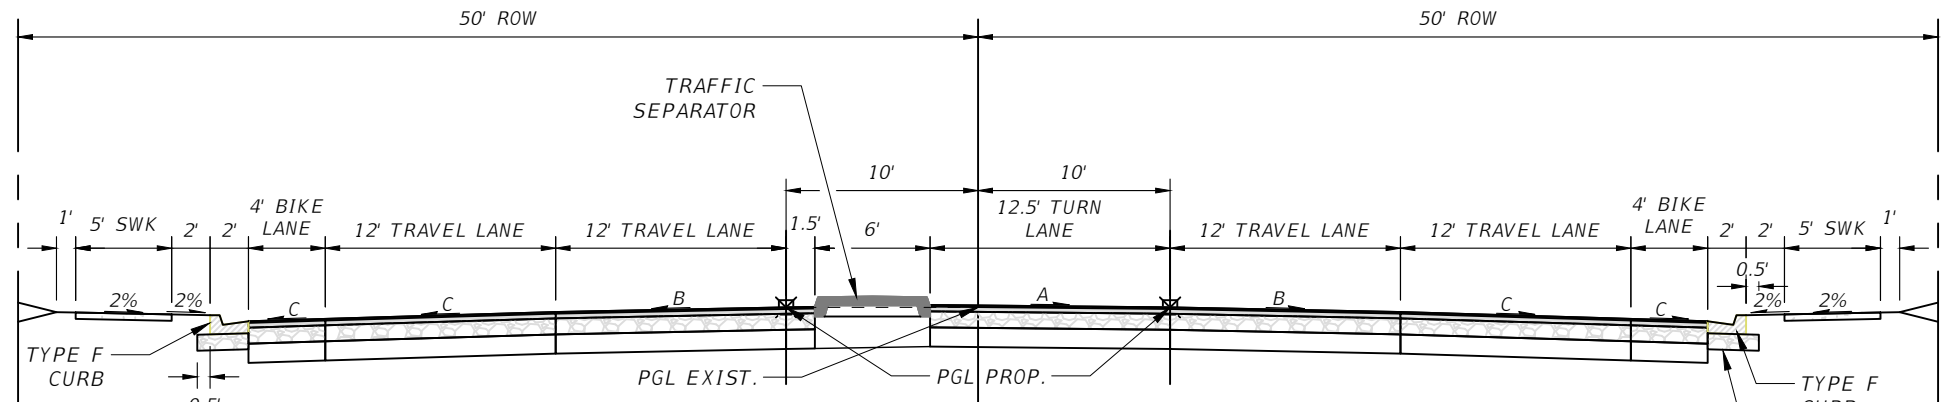

ASPHALT PAVEMENT DETAIL
 NOT TO SCALE

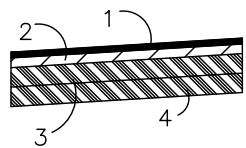- ASPHALT KEYNOTE LEGEND**
- 1 1" FC 9 FRICTIONAL ASPHALT
 - 2 3" SP 12.5 STRUCTURAL ASPHALT
 - 3 10" LIMEROCK BASE
 - 4 12" STABILIZED SUB-GRADE

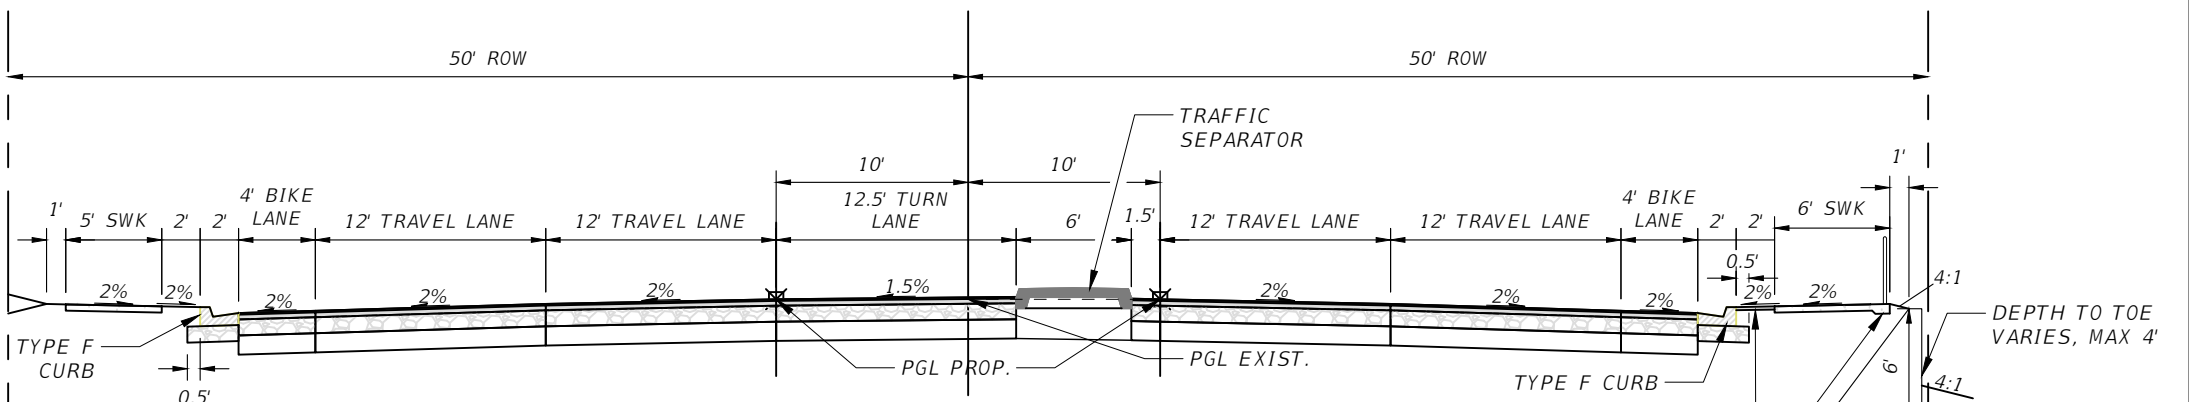


NW 46TH AVENUE
 SOUTHBOUND LEFT TURN LANE SECTION
 W/ GRAVITY WALL: 210+19 - 211+77



2" ASPHALT PAD FOR W-BEAM GUARDRAIL W/ TIMBER POST PER FDOT SPI 536-001. GUARDRAIL NOT SHOWN FOR CLARITY
 THICKENED SIDEWALK EDGE FOR GUIDERAIL PER FDOT SPI 515-070. GUIDERAIL NOT SHOWN FOR CLARITY
 SCHEME 2 GRAVITY WALL PER FDOT SPI 400-011

REVISIONS		PREPARED BY		NW 44th AVENUE EXTENSION PHASE 2		SHEET NO.	
DATE	DESCRIPTION	DATE	DESCRIPTION				
12/1/22	REVISED TURN LANE MINIMUM CROSS-SLOPE			OCALA CITY ENGINEER'S OFFICE Gary Anson		TYPICAL SECTIONS	
1/26/23	ADDED NOTES FOR CURBS AND SEPARATOR						


NOEL JOHN COOPER, P.E.
 P.E. LICENSE NUMBER 69534
 STATE OF FLORIDA, DATE: _____
 VALID ONLY WITH EMBOSSED SEAL.

Station	Description	SB Outside & Bike Lane [C]	Inside Lane [B]	Turn Lane [A]	Inside Lane [B]	NB Outside & Bike Lane [C]
200+32.00'	Edge of Exist. Pavement	1.40%	1.40%	1.40%	-1.40%	-1.40%
200+83.76'	Level Crown	0.00%	0.00%	0.00%	0.00%	0.00%
201+50.00'	Point of Curvature					
201+55.80'	Reverse Crown	-2.00%	-2.00%	-2.00%	2.00%	2.00%
201+66.56'	Begin Full Superelevation	-2.30%	-2.30%	-2.30%	2.30%	2.30%
203+71.13'	End Full Superelevation	-2.30%	-2.30%		2.30%	2.30%
203+97.19'	Point of Tangency					
204+43.58'	Level Crown	0.00%	0.00%		0.00%	0.00%
204+89.96'	Point of Curvature					
205+16.03'	Begin Full Superelevation	2.30%	2.30%		-2.30%	-2.30%
207+18.20'	End Full Superelevation	2.30%	2.30%		-2.30%	-2.30%
207+28.96'	Reverse Crown	2.00%	2.00%		-2.00%	-2.00%
207+34.76'	Point of Tangency					
208+01.00'	Level Crown	0.00%	0.00%		-2.00%	-2.00%
208+37.40'	Begin Driveway Intersection	-1.50%	-1.50%		-1.50%	-1.50%
209+65.40'	End Driveway Intersection	-1.50%	-1.50%	-1.50%	-1.50%	-1.50%
210+01.40'	Begin Normal Crown	-2.00%	-2.00%	-1.50%	-2.00%	-2.00%
213+49.21'	Point of Curvature	-2.00%	-2.00%		-2.00%	-2.00%
216+82.48'	Point of Reverse Curvature	-2.00%	-2.00%		-2.00%	-2.00%
220+15.89'	Point of Tangency	-2.00%	-2.00%		-2.00%	-2.00%
220+66.29'	Begin Lane Grade Break	-2.00%	-2.00%		-2.00%	-2.00%
221+08.29'	Begin Normal Crown	-3.00%	-2.00%		-2.00%	-3.00%
238+31.76'	End Normal Crown	-3.00%	-2.00%	-1.50%	-2.00%	-3.00%
238+67.76'	End Lane Grade Break	-2.00%	-2.00%	-1.50%	-2.00%	-2.00%
239+39.76'	Level Crown	0.00%	0.00%	-0.40%	-2.00%	-2.00%
240+35.25'	Exist. Edge of Pavement	1.82%	1.82%		-2.03%	-2.03%
240+54.96'	Exist. Point of Curvature	2.93%	2.93%		-3.17%	-3.17%

REVISIONS				PREPARED BY	NW 44th AVENUE EXTENSION PHASE 2	SHEET NO.
DATE	DESCRIPTION	DATE	DESCRIPTION		TYPICAL SECTIONS	12
12/1/22	REVISED MINIMUM STANDARD SLOPE TO 1.5%					

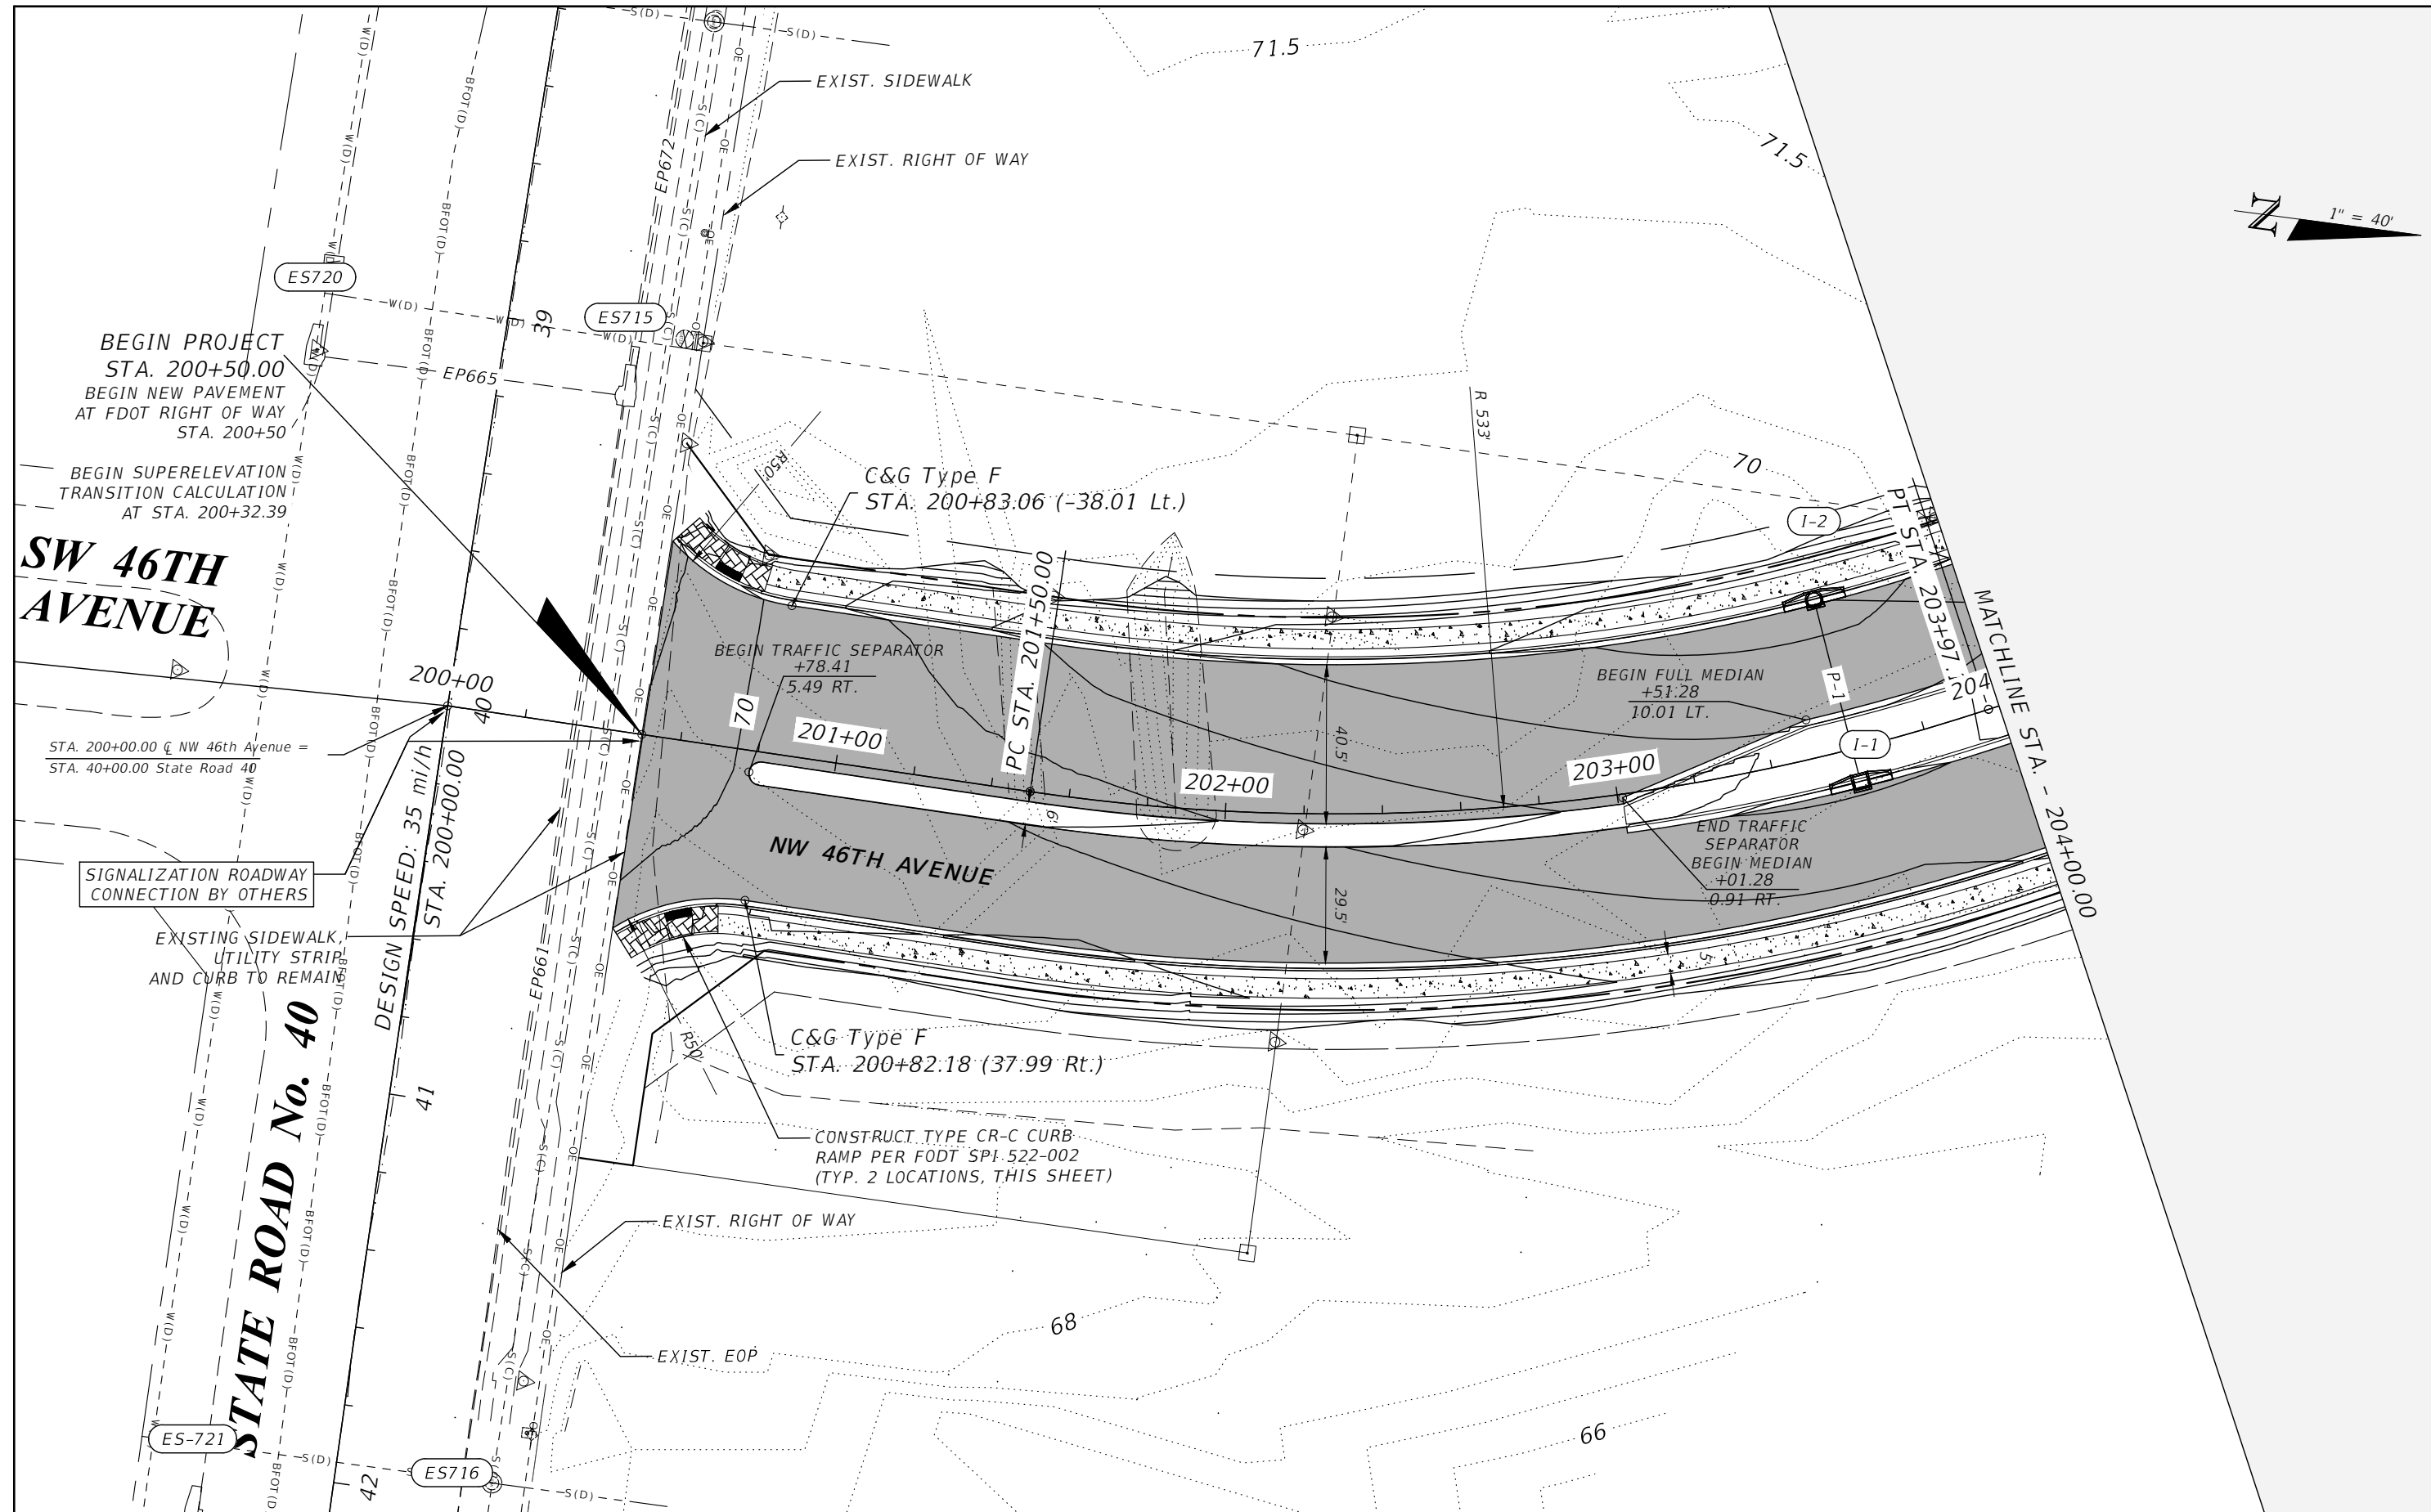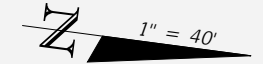

REVISIONS		PREPARED BY		NW 44th AVENUE EXTENSION PHASE 2		SHEET NO.			
DATE	DESCRIPTION	DATE	DESCRIPTION						
11/30/22	Added Match Exist			NOEL JOHN COOPER, P.E. P.E. LICENSE NUMBER 69534 STATE OF FLORIDA, DATE: _____ VALID ONLY WITH EMBOSSED SEAL.		OCALA CITY ENGINEER'S OFFICE			
2/9/23	Revised Project's Starting Point							ROADWAY PLAN (1)	
3/13/23	Added Note For Sidewalk & Other Entities To Remain								

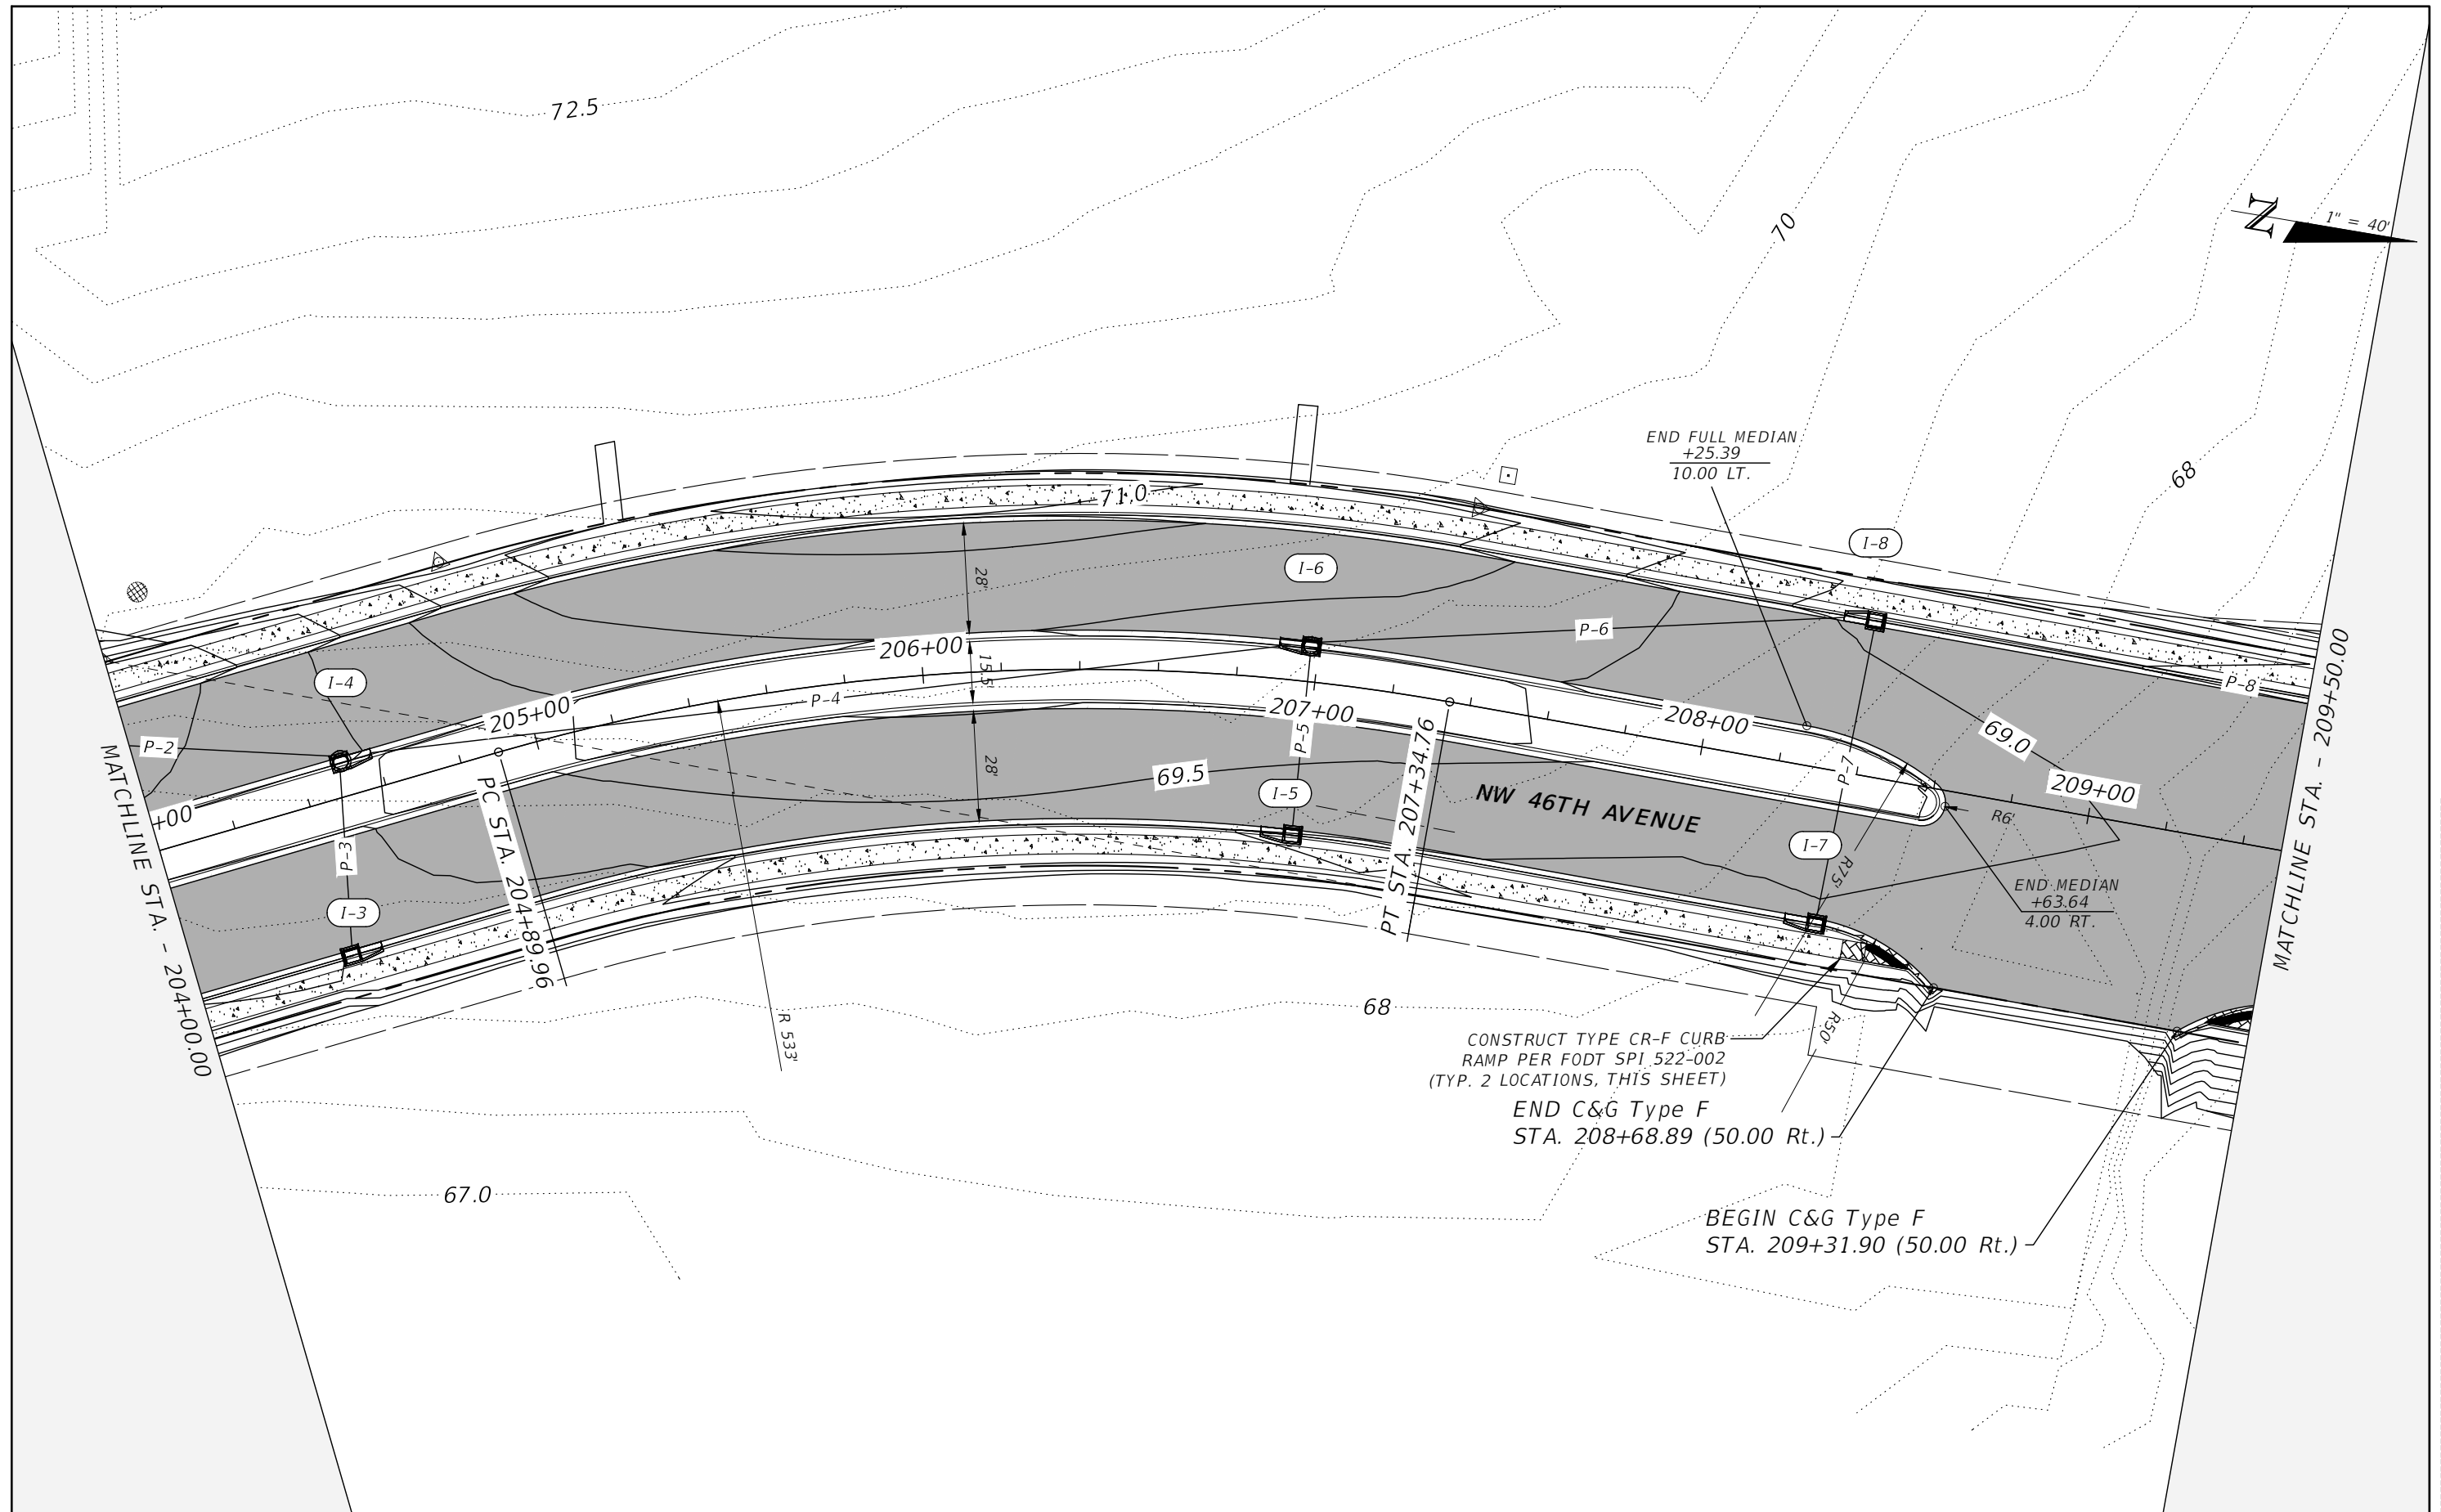

REVISIONS	
DATE	DESCRIPTION


NOEL JOHN COOPER, P.E.
 P.E. LICENSE NUMBER 69534
 STATE OF FLORIDA, DATE: _____
 VALID ONLY WITH EMBOSSED SEAL.

PREPARED BY

 Gary Anson

NW 44th AVENUE EXTENSION PHASE 2
ROADWAY PLAN (2)

SHEET NO.
 14

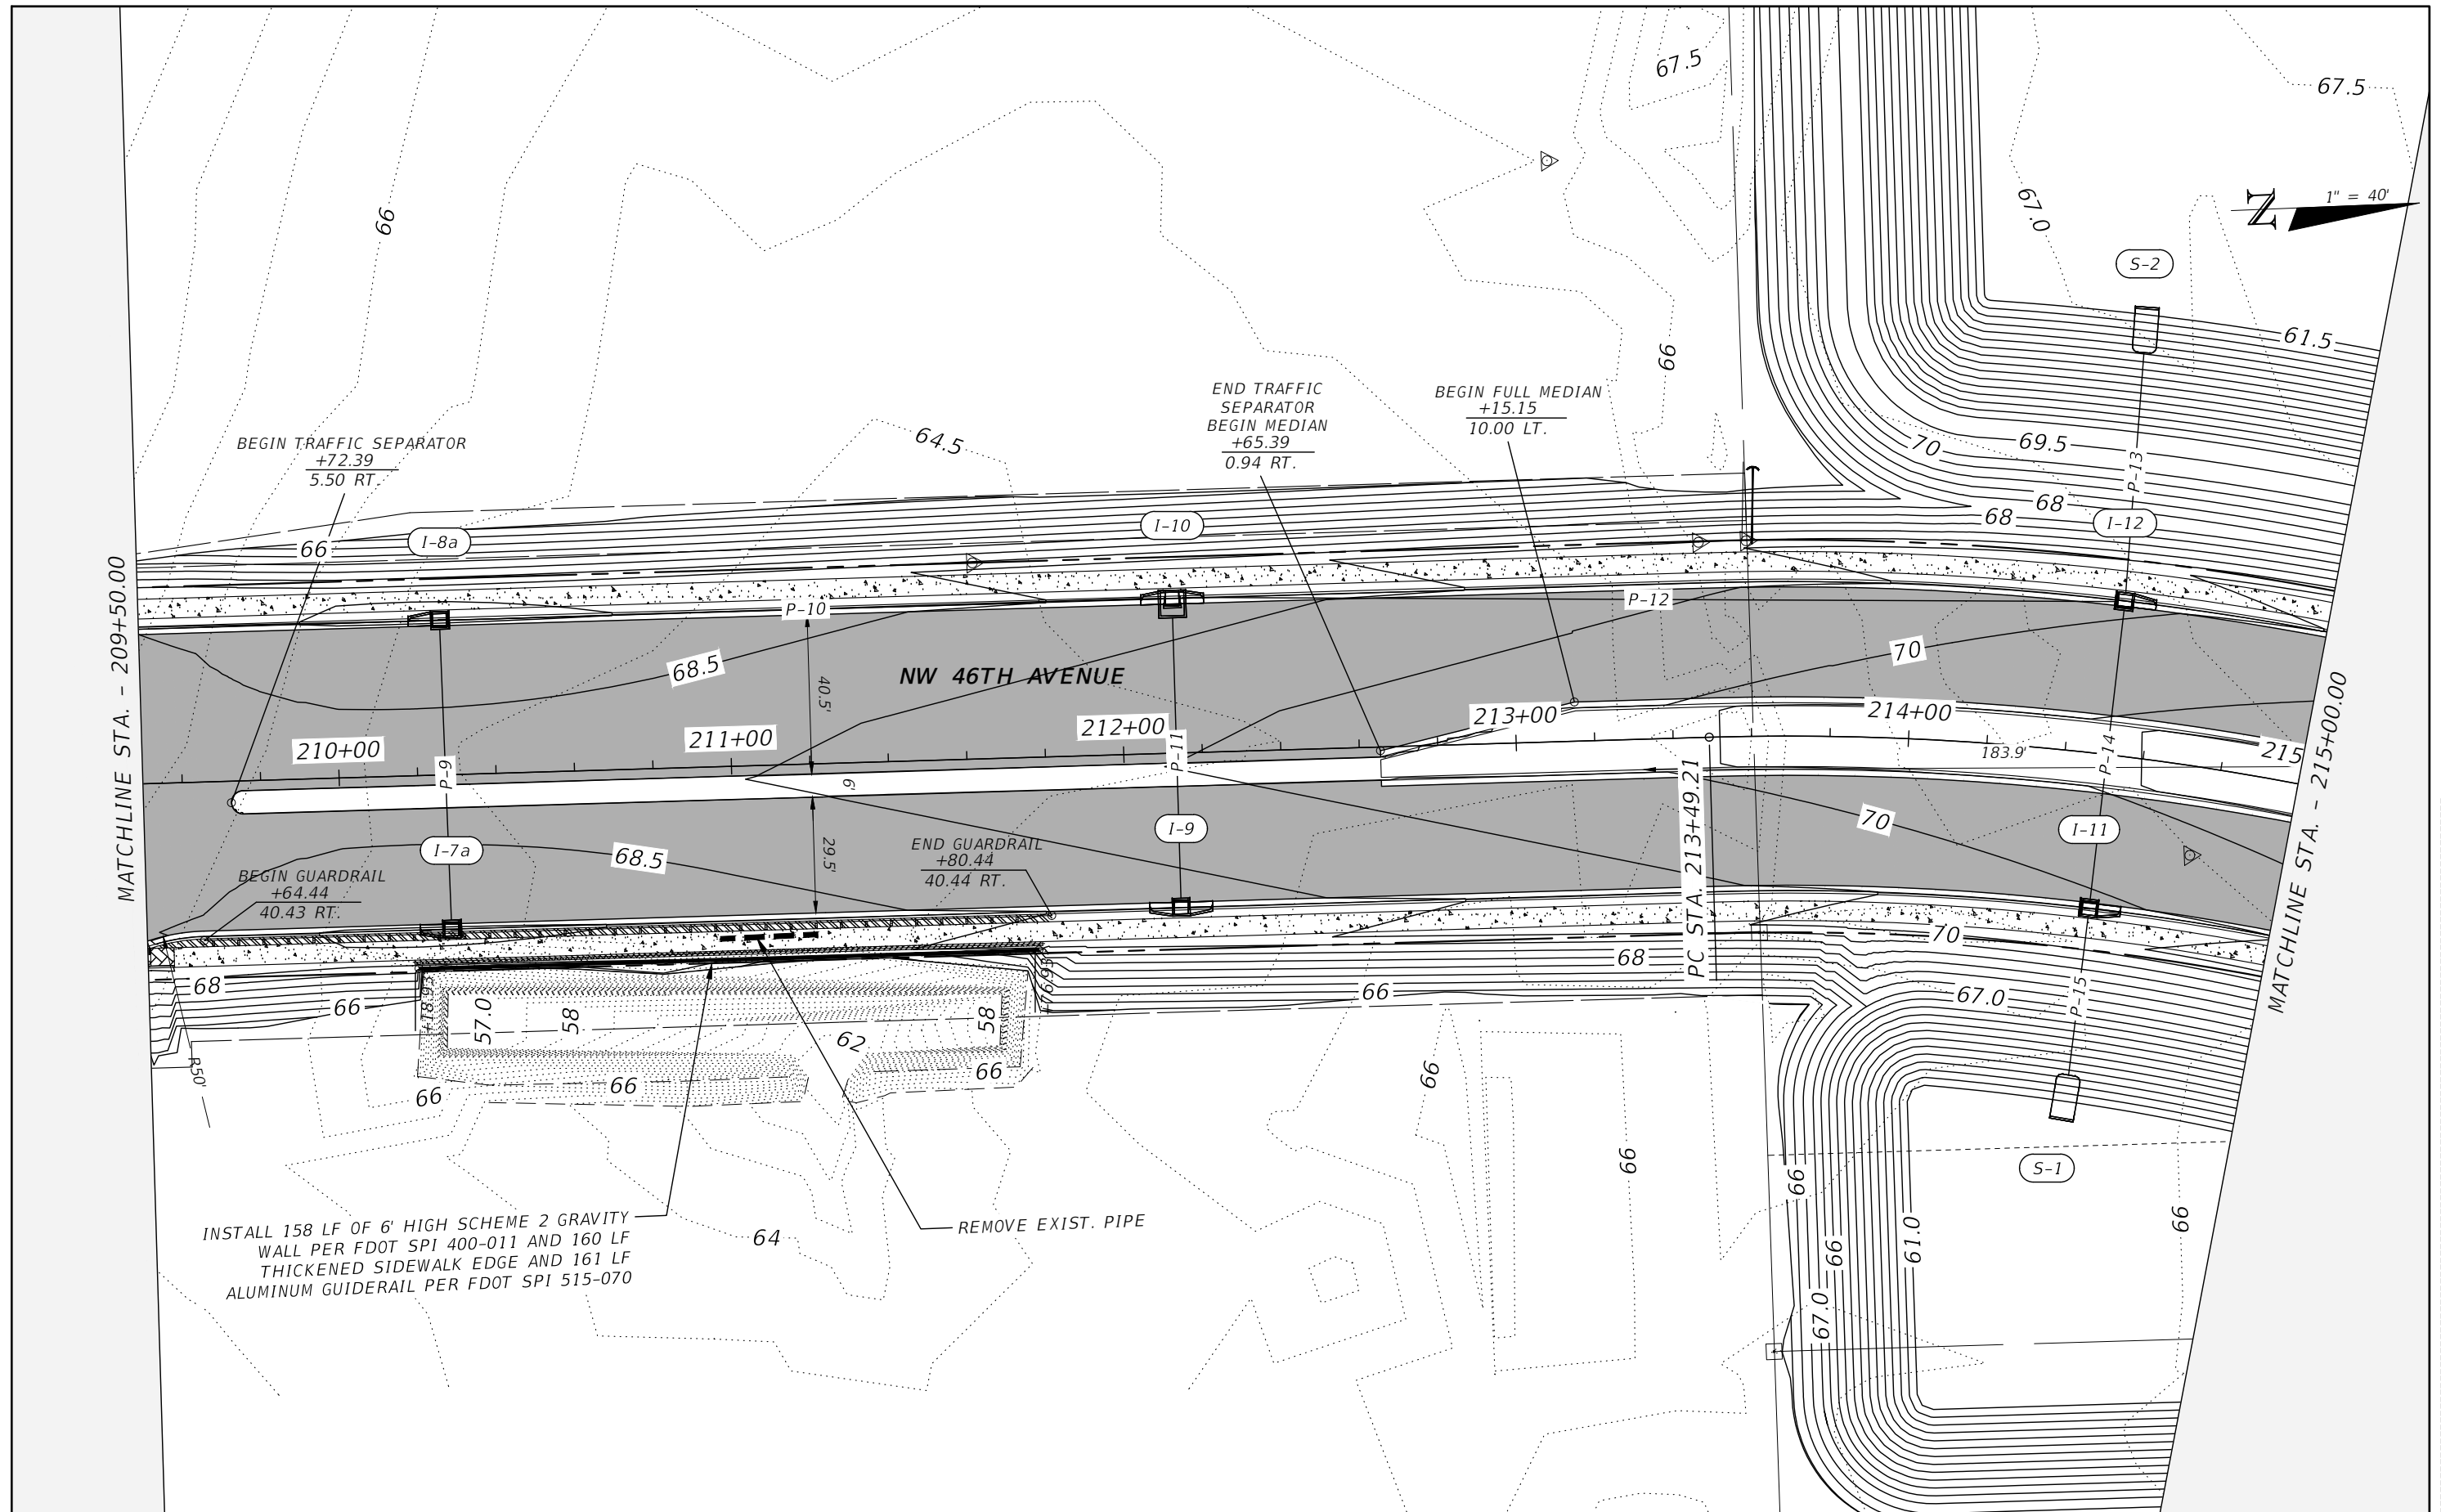

MATCHLINE STA. - 209+50.00

MATCHLINE STA. - 215+00.00

REVISIONS	
DATE	DESCRIPTION
4/6/23	Revised text for guiderail

NOEL JOHN COOPER, P.E.
 P.E. LICENSE NUMBER 69534
 STATE OF FLORIDA, DATE: _____
 VALID ONLY WITH EMBOSSED SEAL.

PREPARED BY






Gary Anson

NW 44th AVENUE EXTENSION PHASE 2

ROADWAY PLAN (3)

SHEET NO.
15

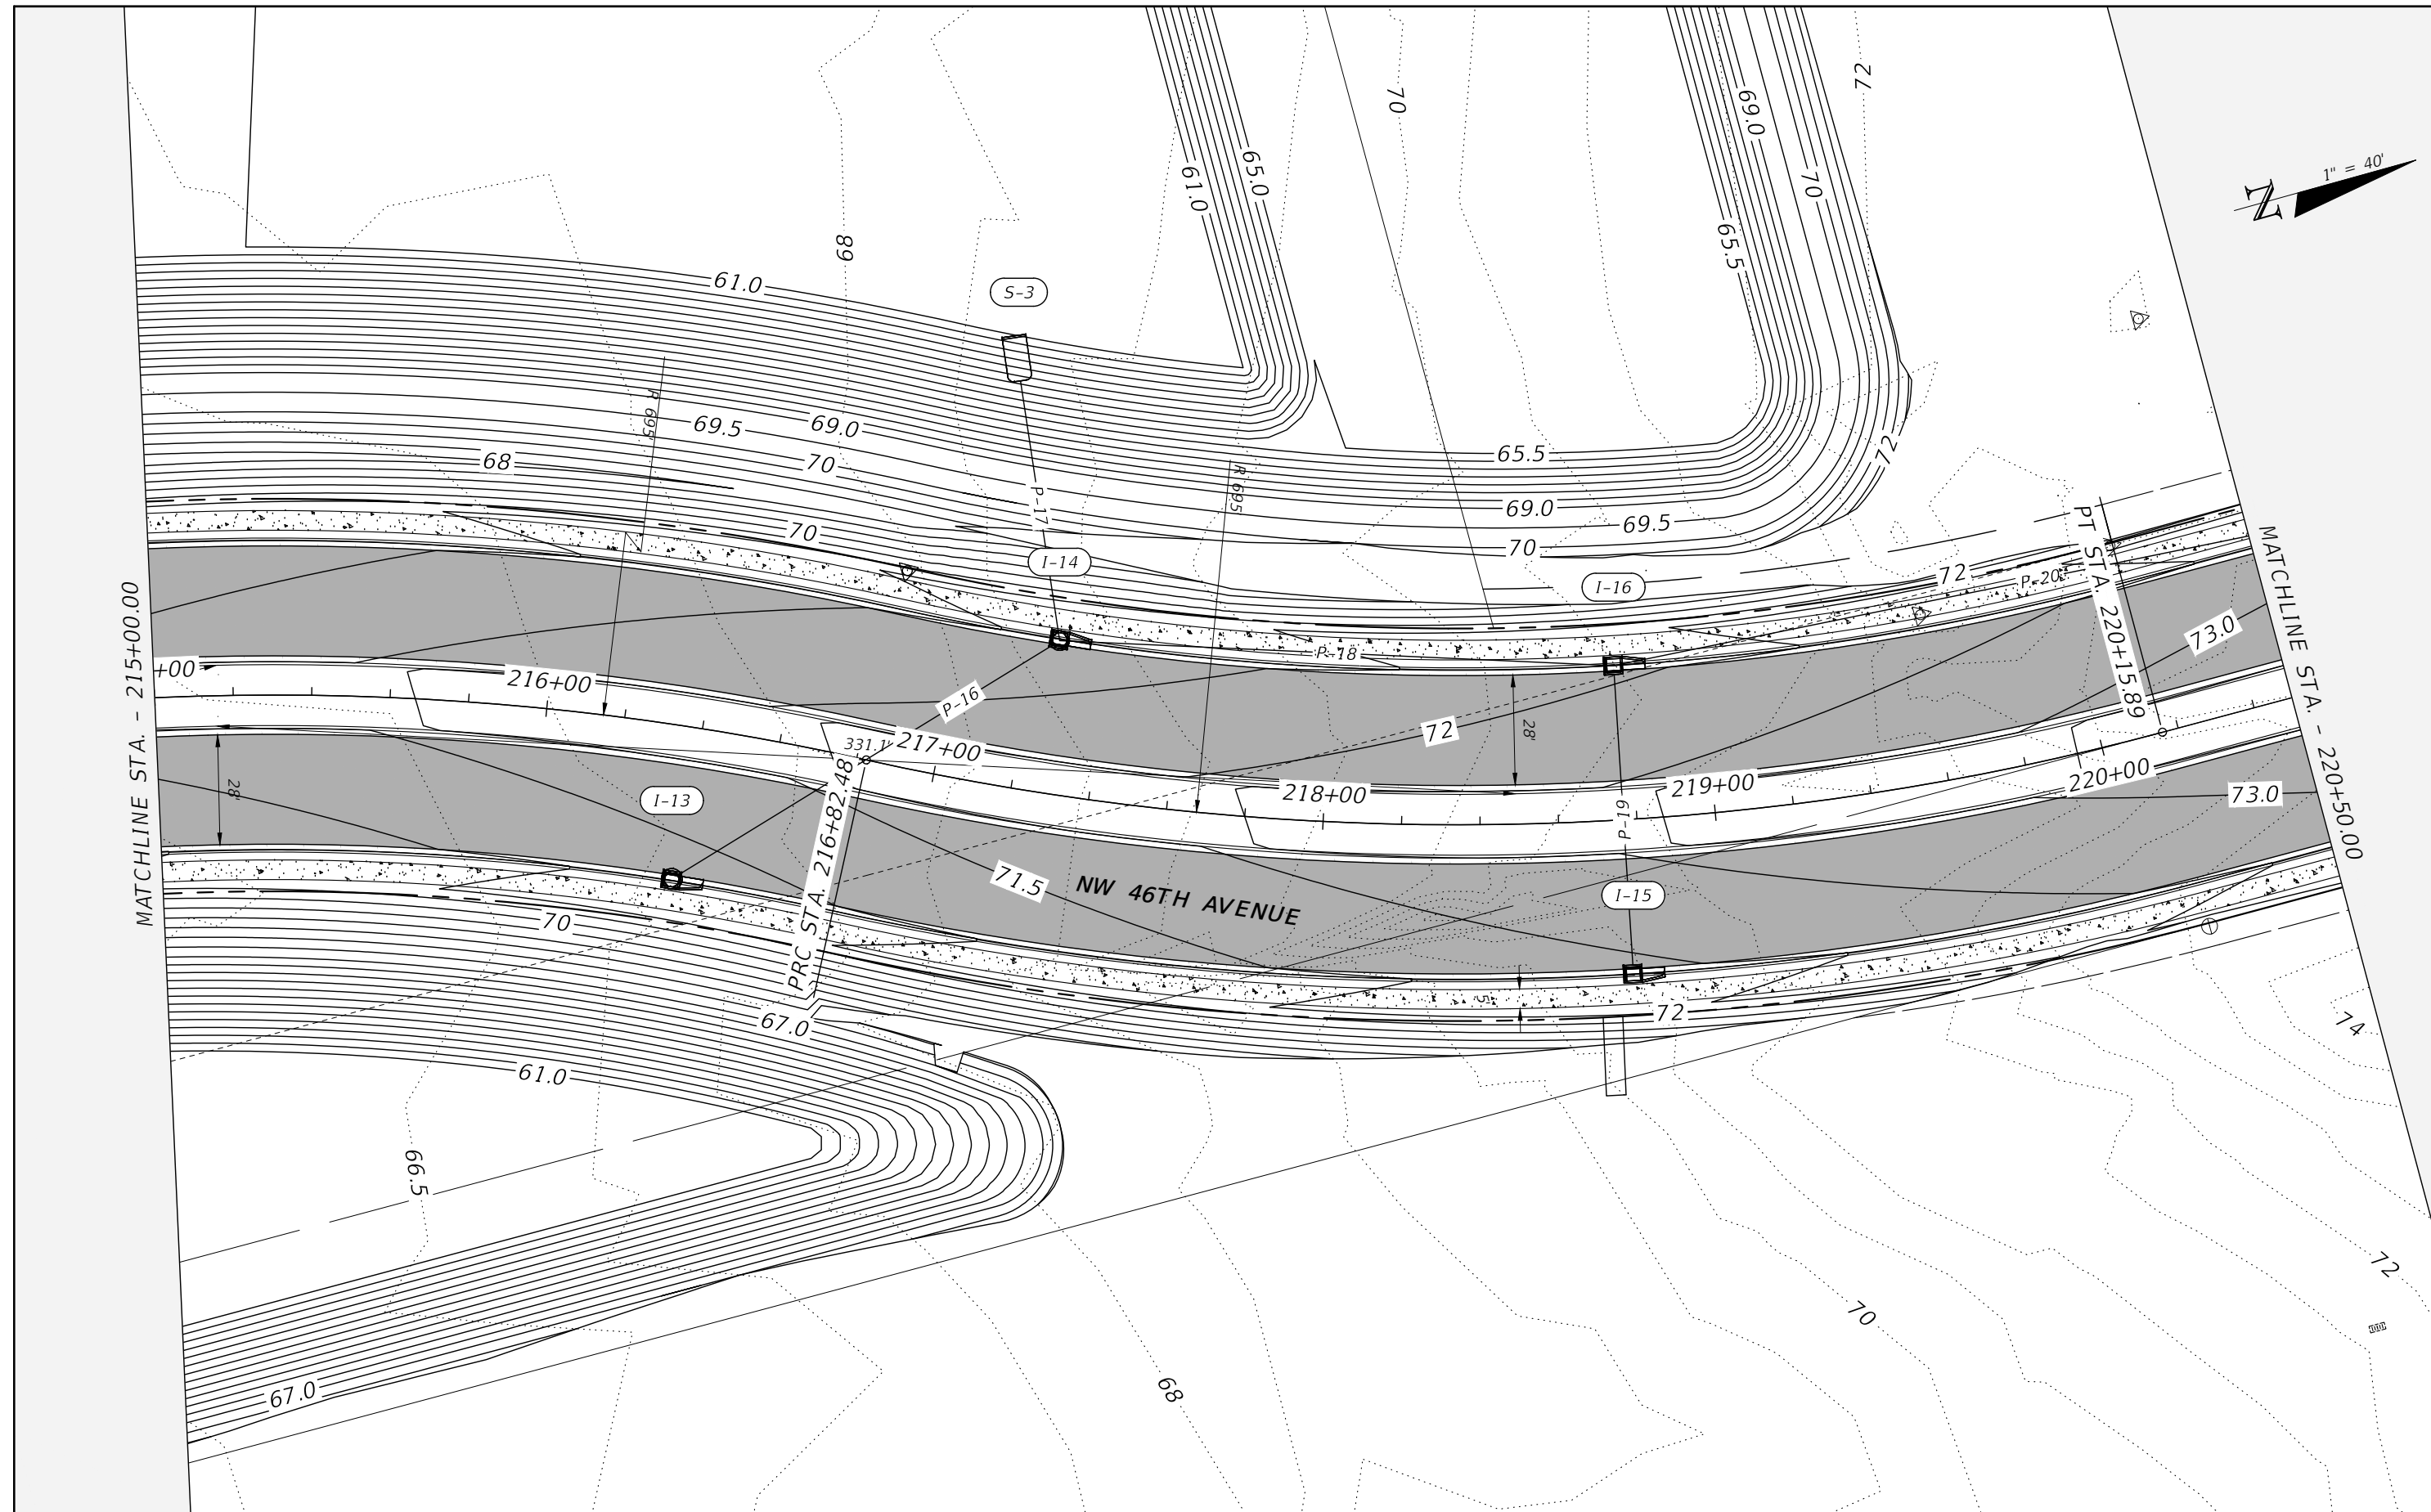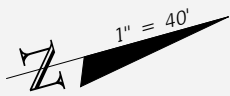

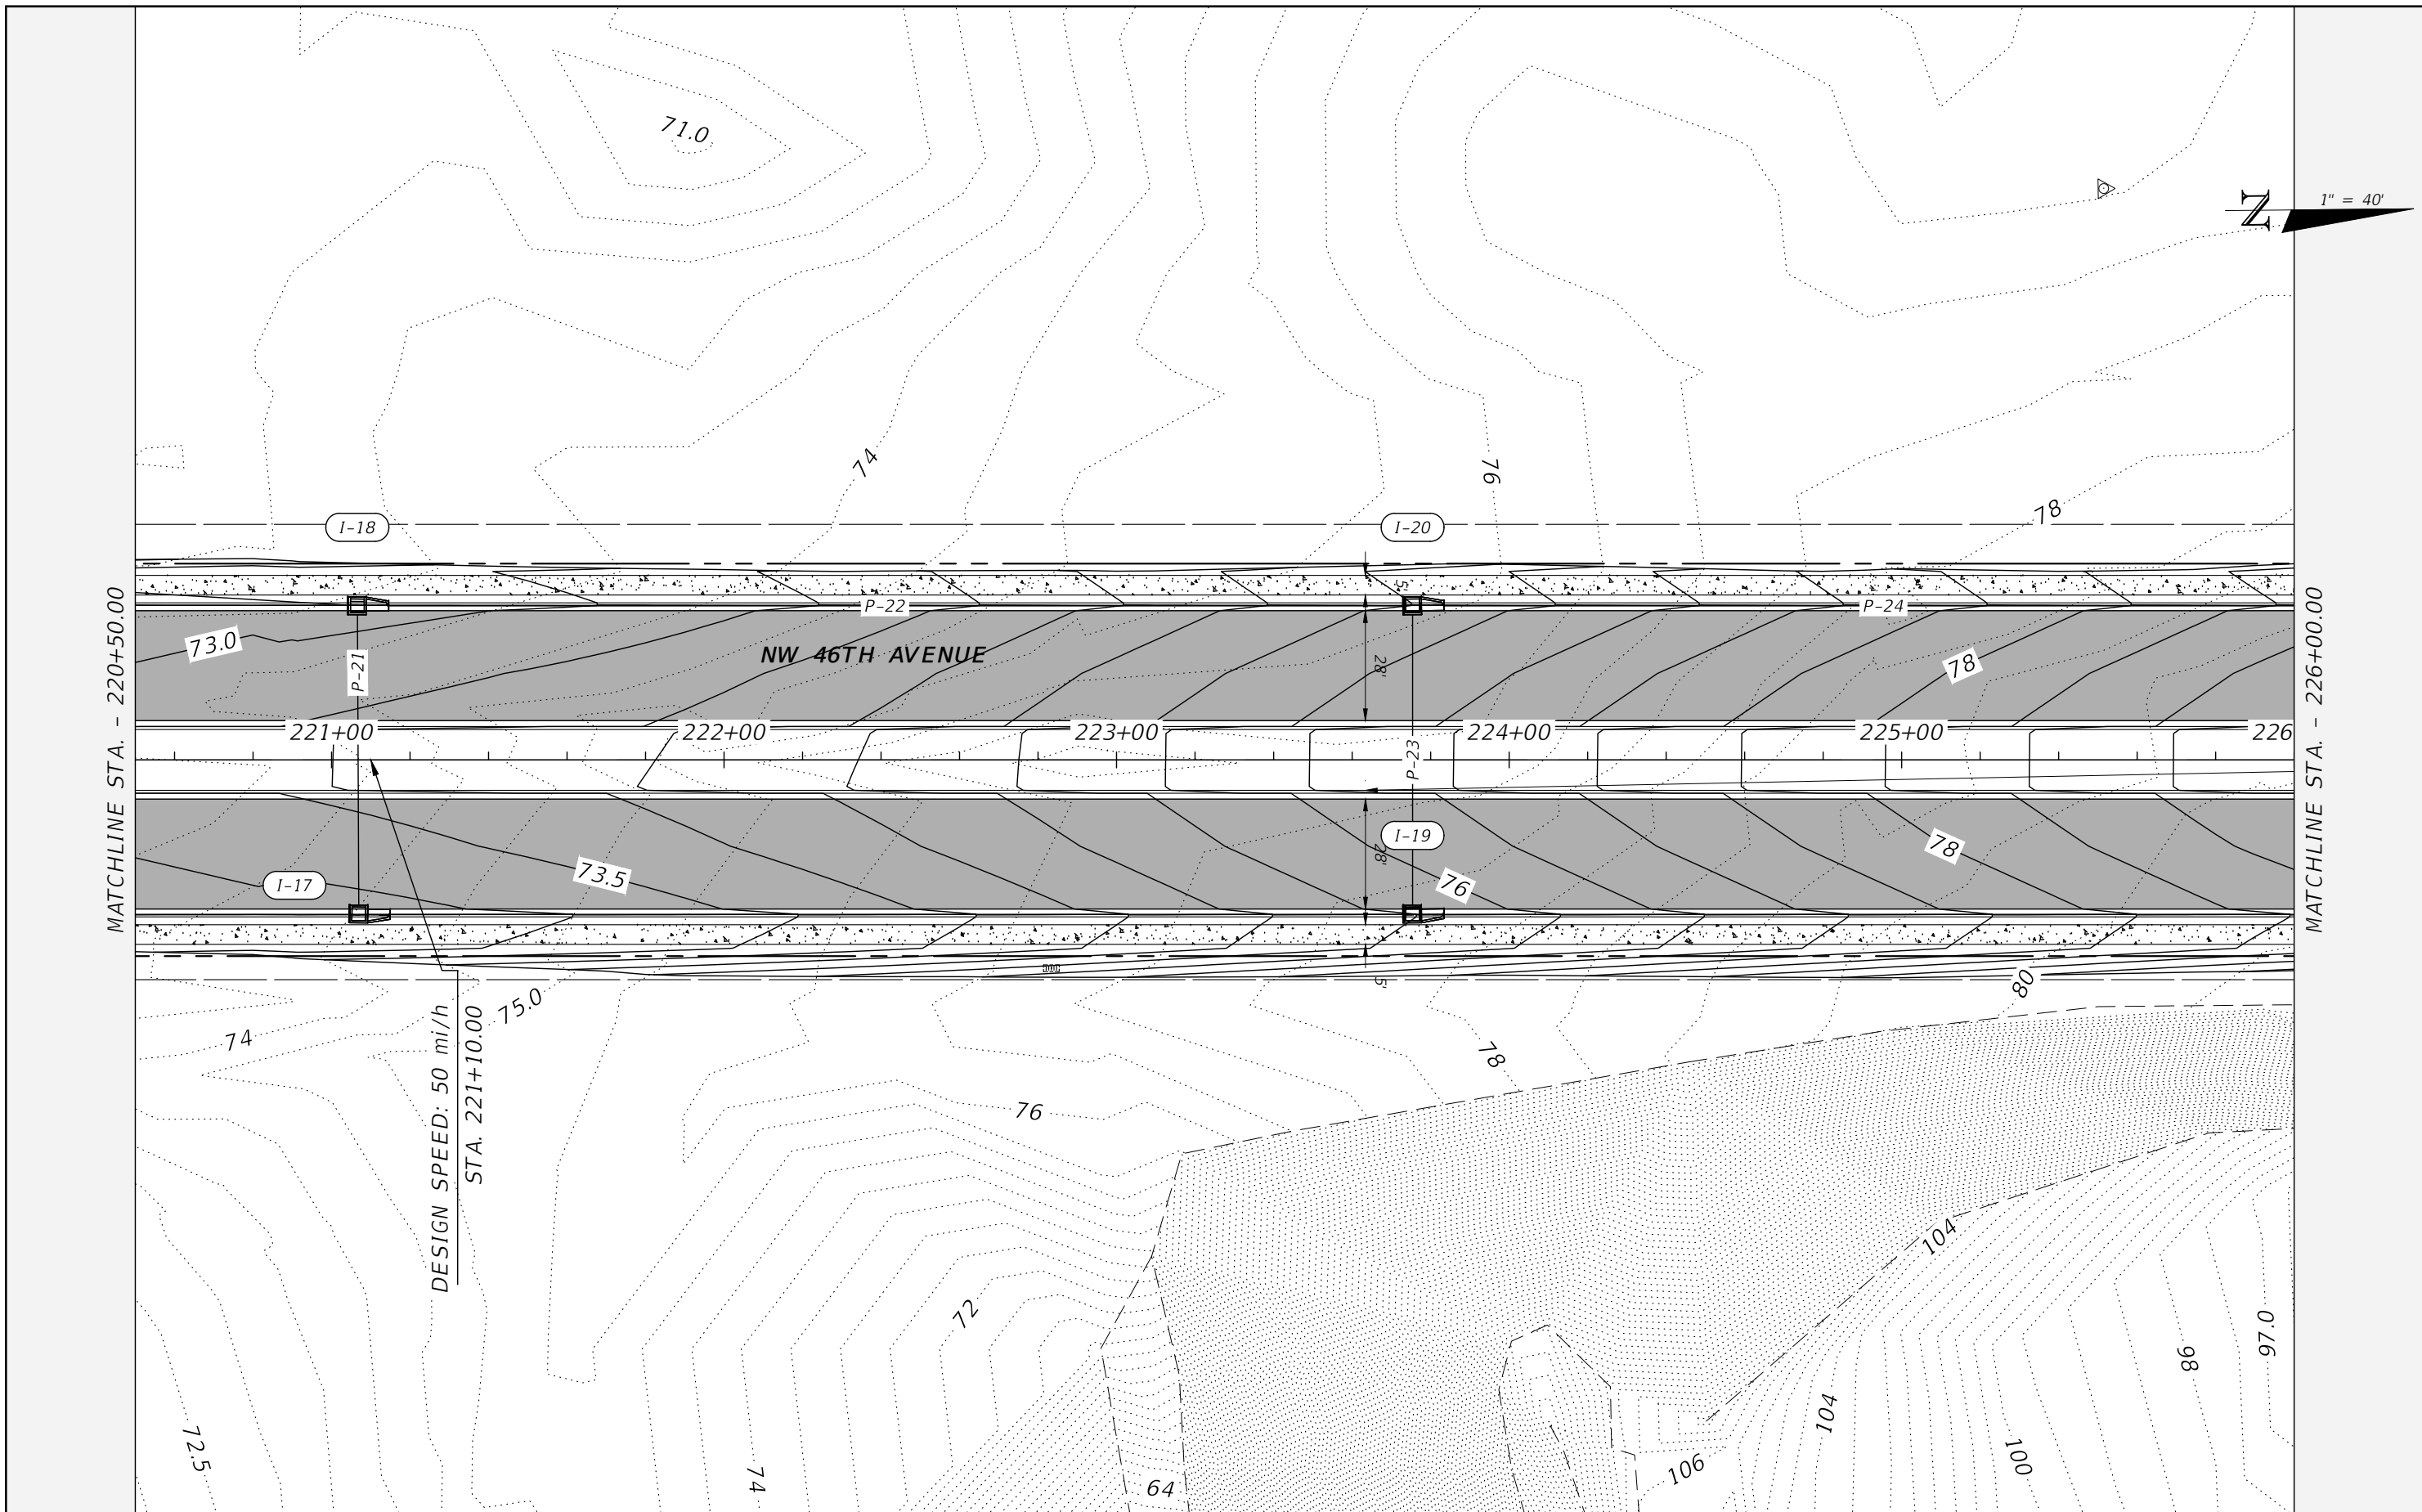

MATCHLINE STA. - 220+50.00

MATCHLINE STA. - 226+00.00

DESIGN SPEED: 50 mi/h
STA. 221+10.00


REVISIONS			
DATE	DESCRIPTION	DATE	DESCRIPTION

NOEL JOHN COOPER, P.E.
P.E. LICENSE NUMBER 69534
STATE OF FLORIDA, DATE: _____
VALID ONLY WITH EMBOSSED SEAL.

PREPARED BY
OCALA
CITY ENGINEER'S OFFICE

NW 44th AVENUE EXTENSION PHASE 2
ROADWAY PLAN (5)

SHEET NO.
17

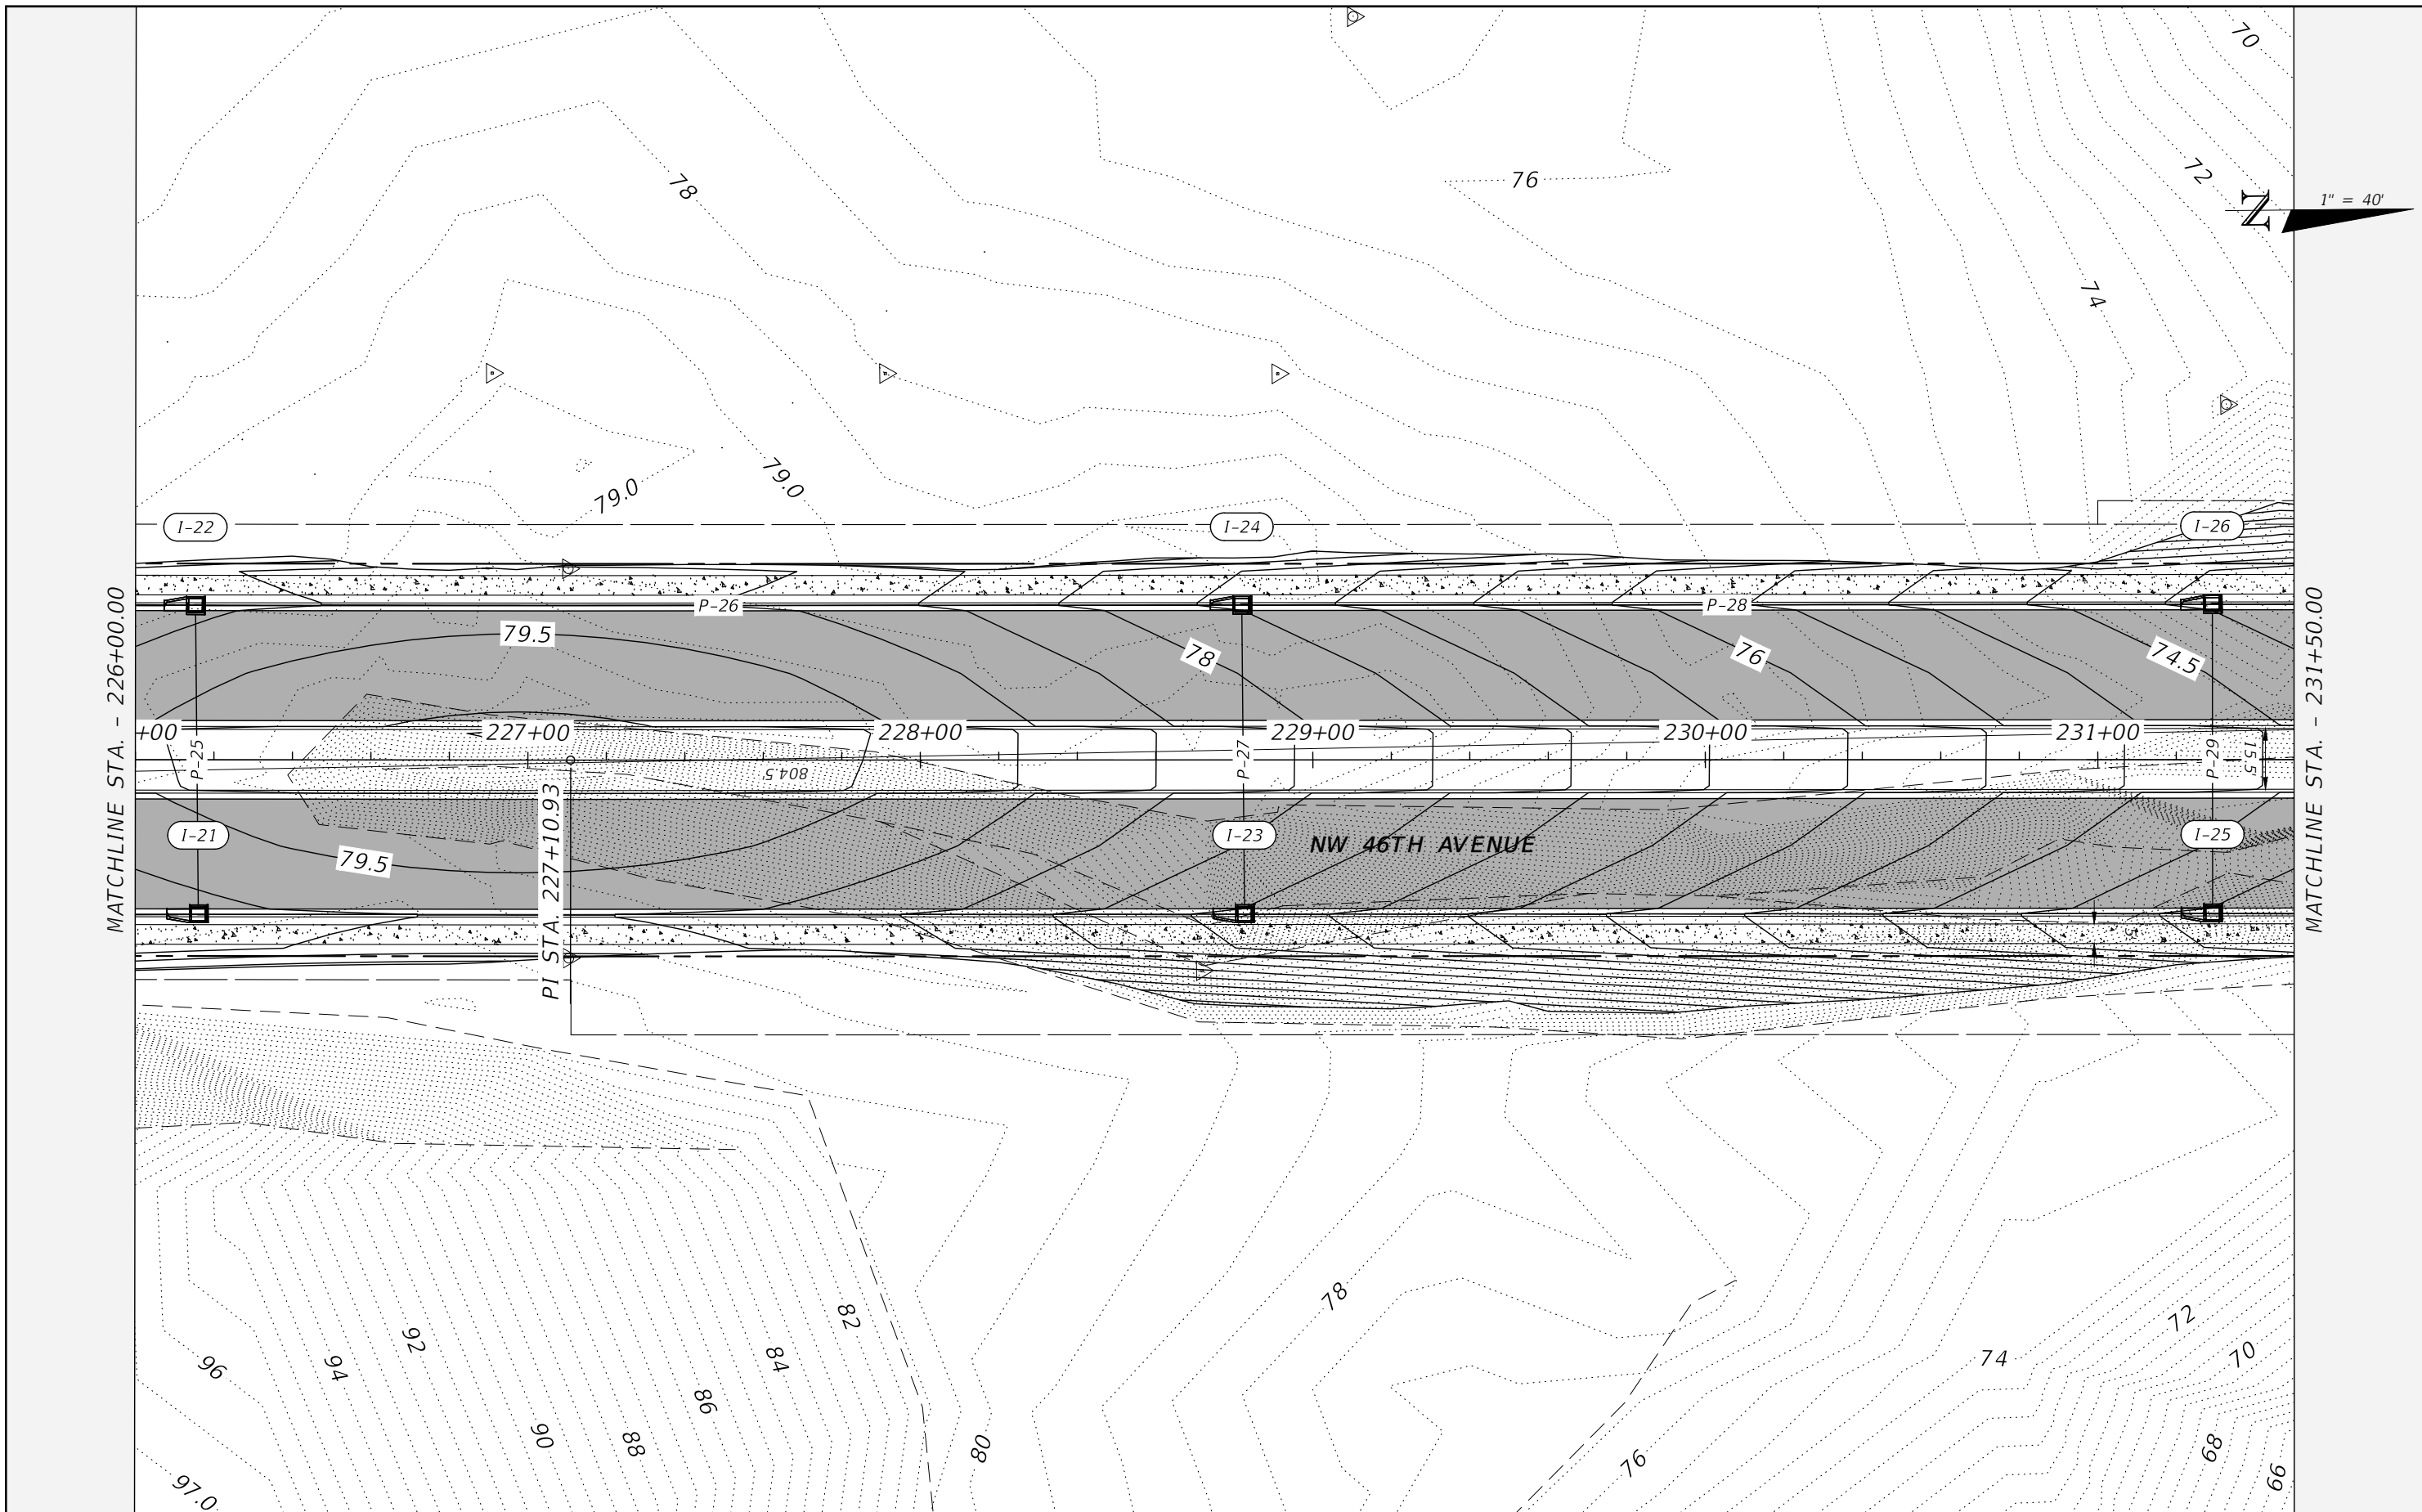

MATCHLINE STA. - 226+00.00

MATCHLINE STA. - 231+50.00

1" = 40'


REVISIONS			
DATE	DESCRIPTION	DATE	DESCRIPTION

NOEL JOHN COOPER, P.E.
 P.E. LICENSE NUMBER 69534
 STATE OF FLORIDA, DATE: _____
 VALID ONLY WITH EMBOSSED SEAL.

PREPARED BY



NW 44th AVENUE EXTENSION PHASE 2
ROADWAY PLAN (6)

SHEET NO.
 18

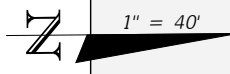

MATCHLINE STA. - 231+50.00

MATCHLINE STA. - 237+00.00

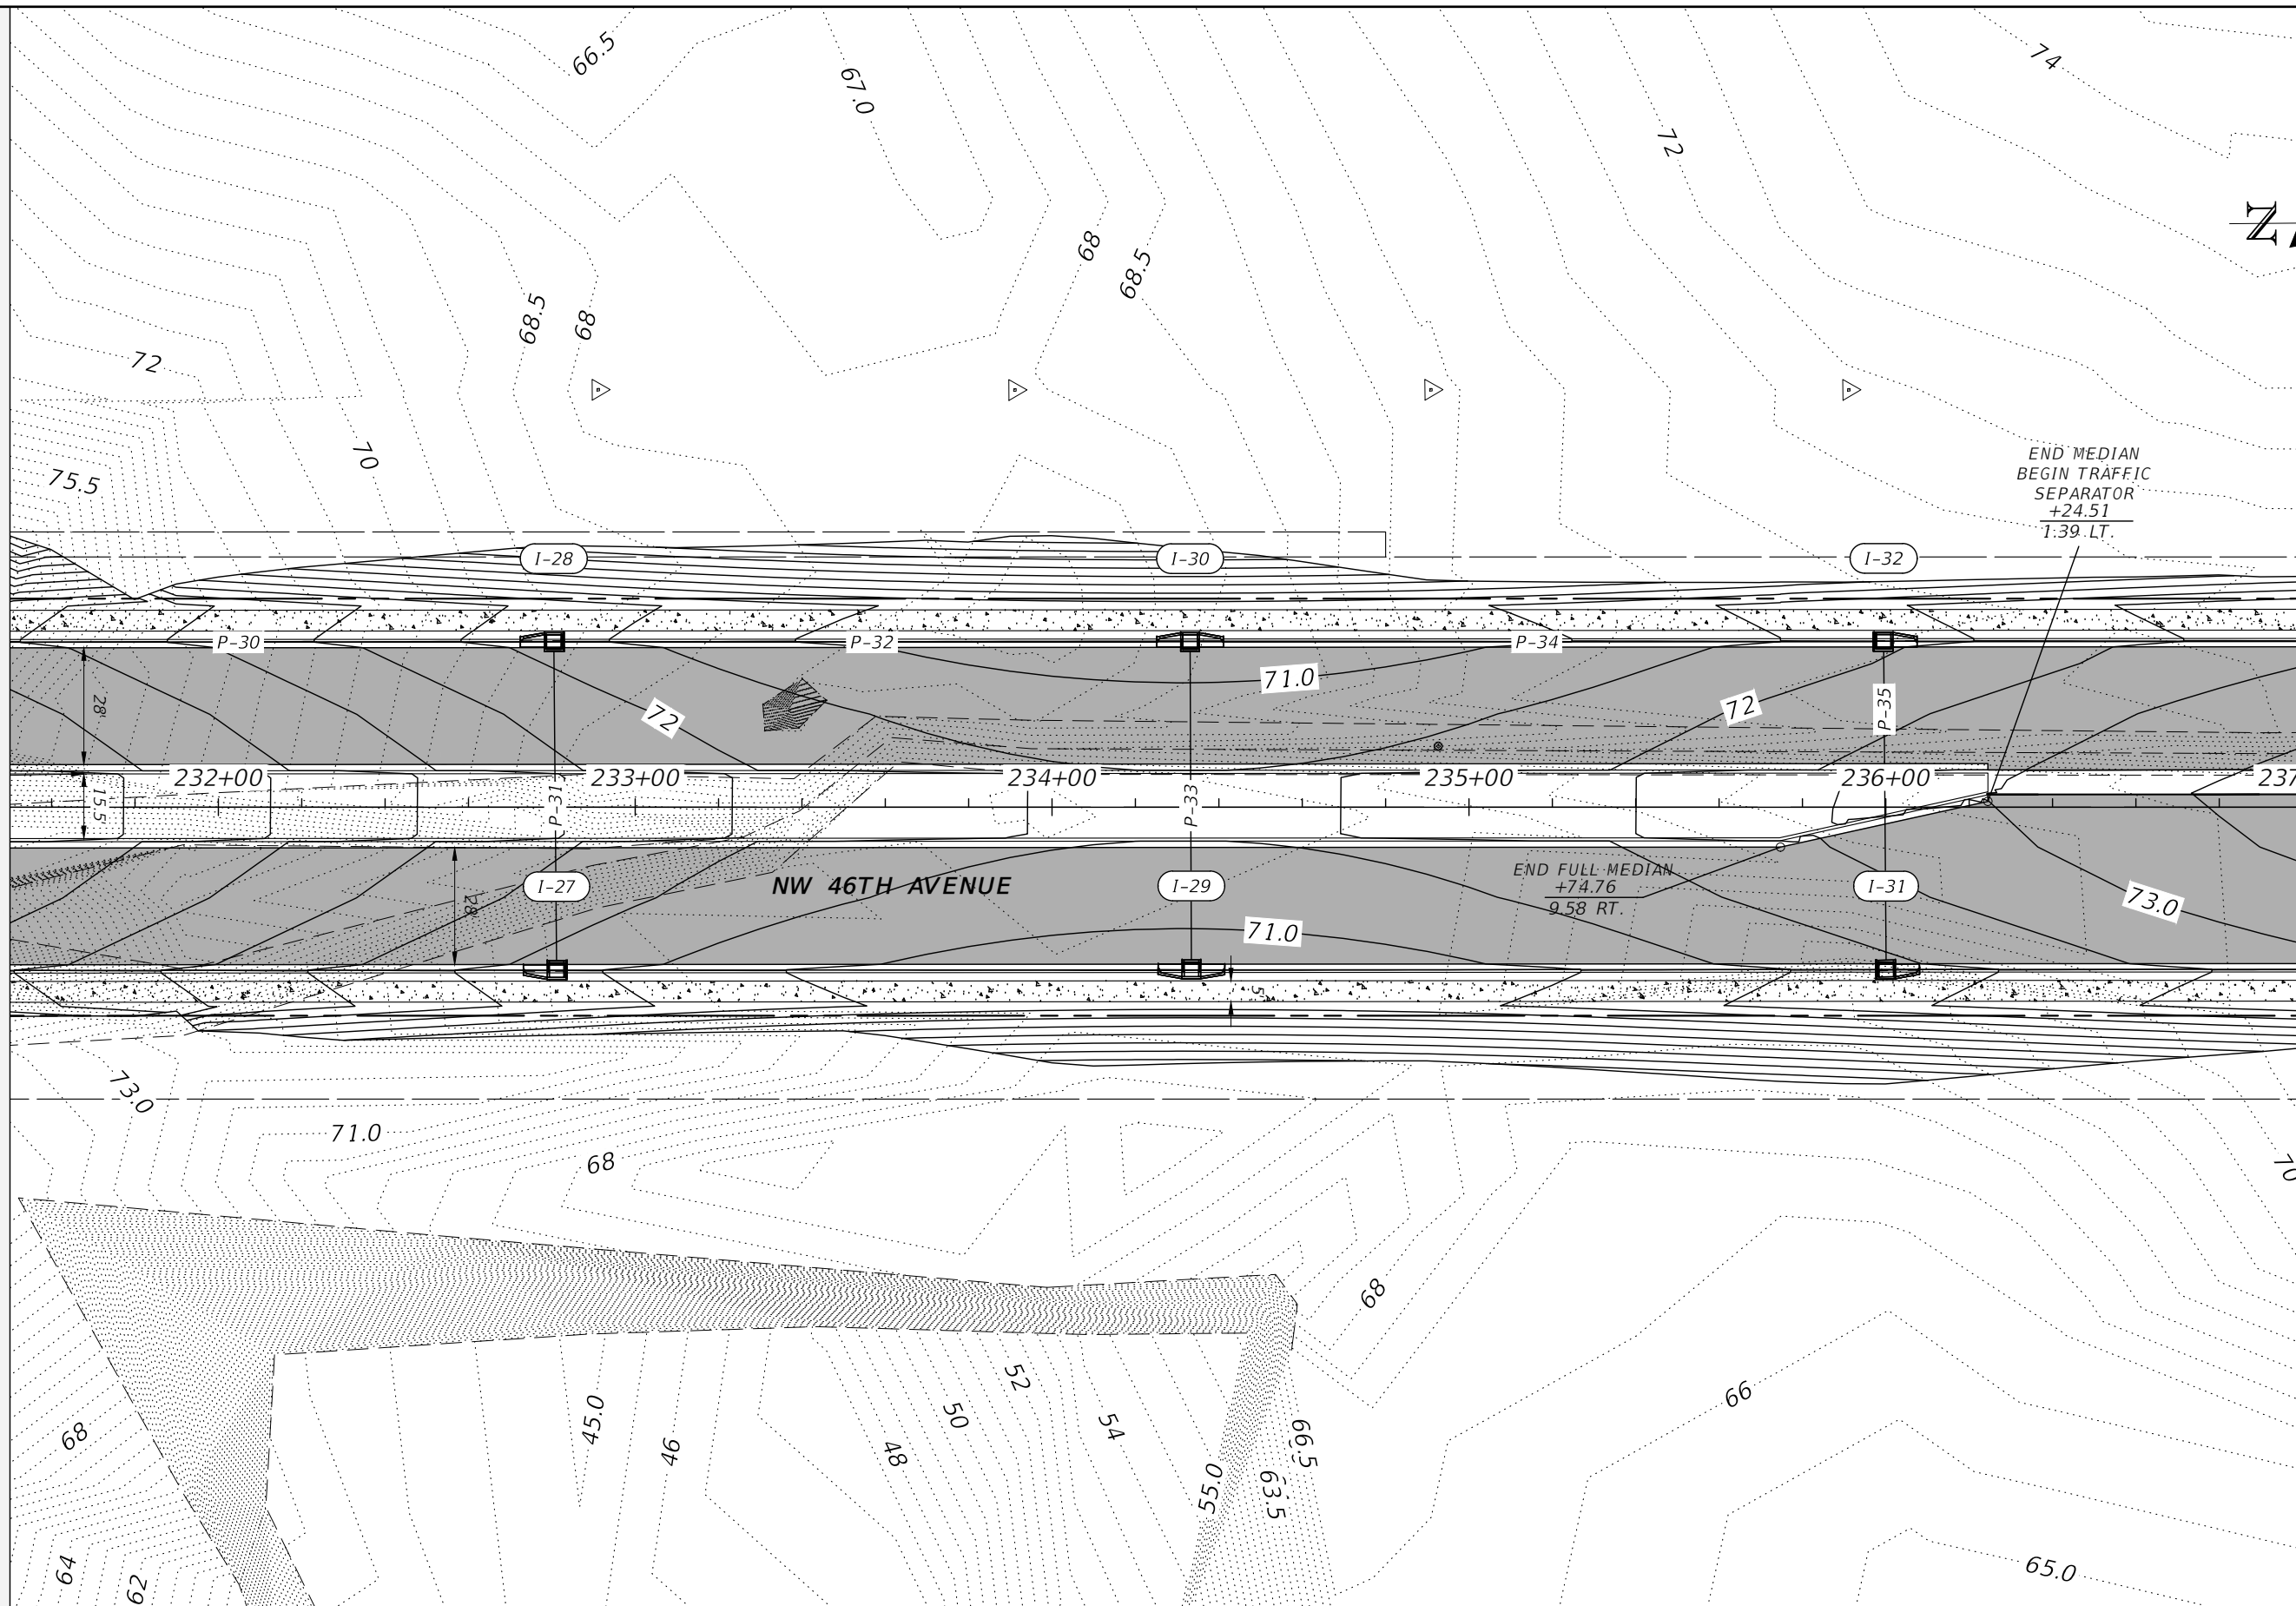

REVISIONS			
DATE	DESCRIPTION	DATE	DESCRIPTION



NOEL JOHN COOPER, P.E.
 P.E. LICENSE NUMBER 69534
 STATE OF FLORIDA, DATE: _____
 VALID ONLY WITH EMBOSSED SEAL.

PREPARED BY

 Gary Anson

NW 44th AVENUE EXTENSION PHASE 2
ROADWAY PLAN (7)

SHEET NO.
 19

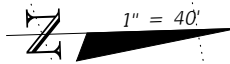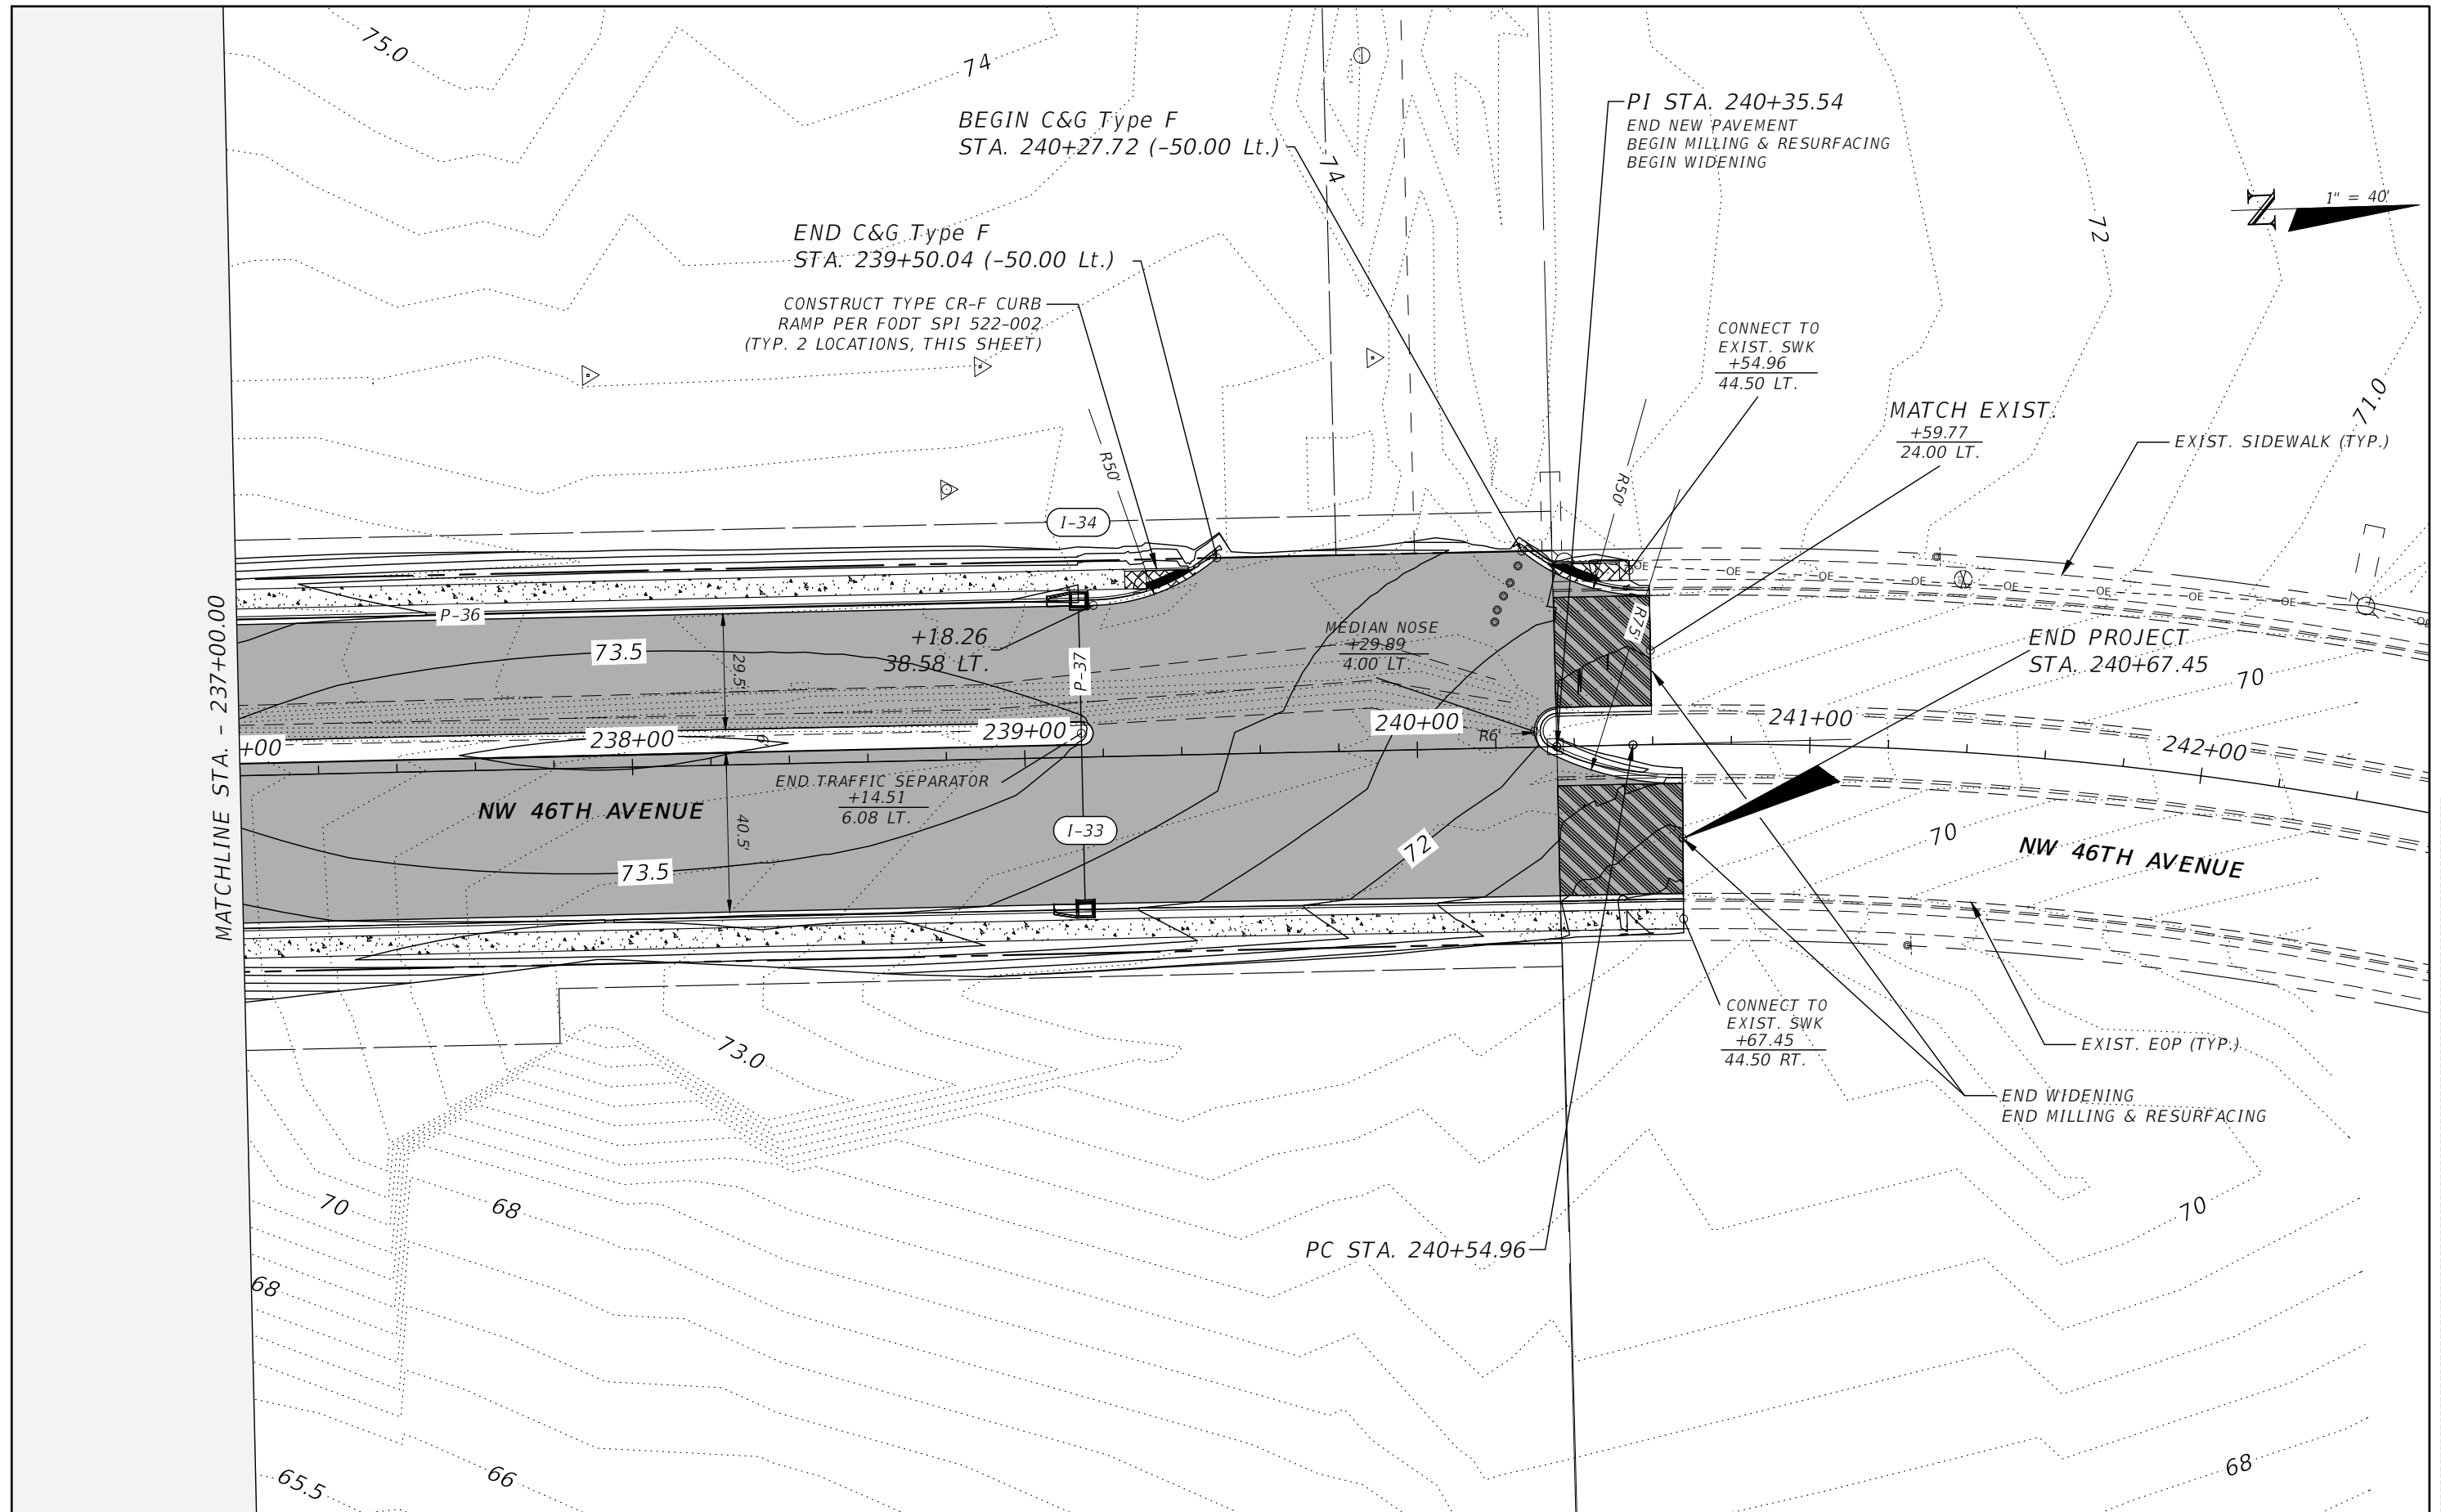

MATCHLINE STA. - 237+00.00

REVISIONS			
DATE	DESCRIPTION	DATE	DESCRIPTION
4/6/23	Revised hatch		

NOEL JOHN COOPER, P.E.
 P.E. LICENSE NUMBER 69534
 STATE OF FLORIDA, DATE: _____
 VALID ONLY WITH EMBOSSED SEAL.


PREPARED BY

Gary Anson

NW 44th AVENUE EXTENSION PHASE 2

ROADWAY PLAN (8)

SHEET NO.
20

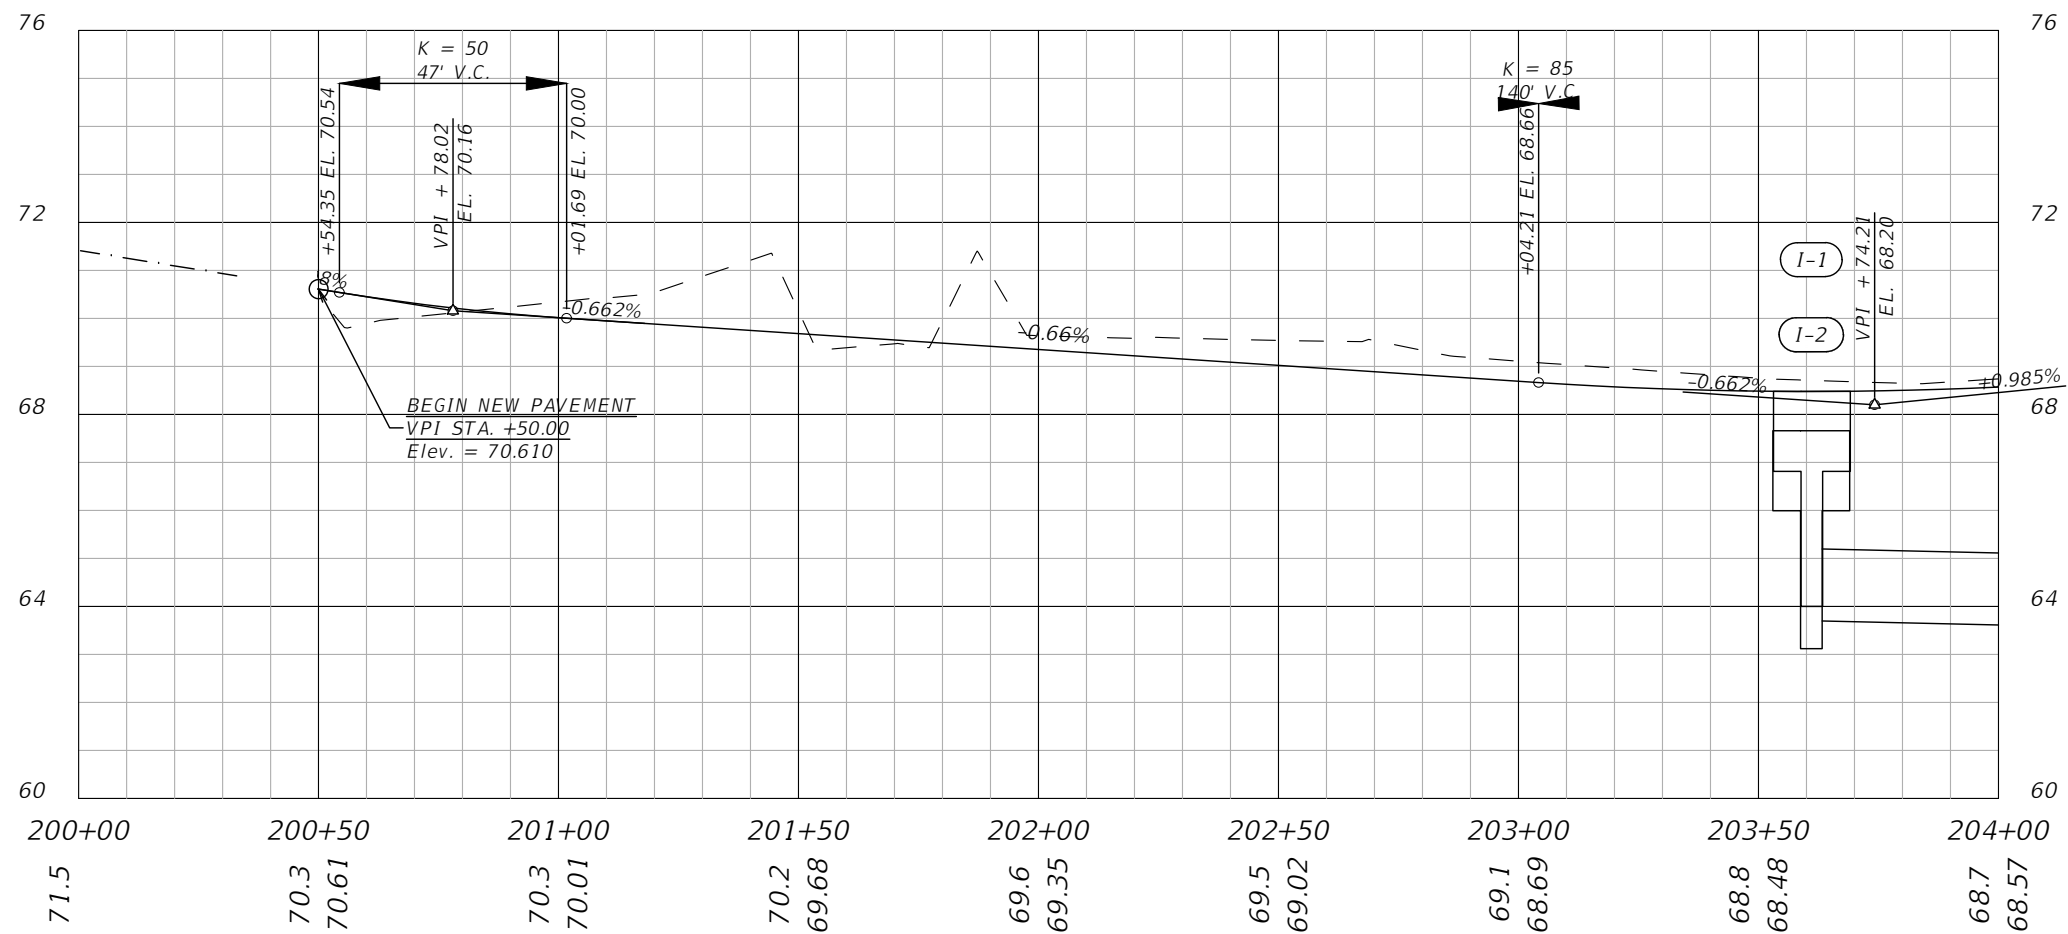

1" = 40' Horizontal
1" = 4' Vertical

STATION
EXIST. ELEV.
PROP. ELEV.

REVISIONS			
DATE	DESCRIPTION	DATE	DESCRIPTION
02/09/23	Revised Project's Starting Point		

NOEL JOHN COOPER, P.E.
P.E. LICENSE NUMBER 69534
STATE OF FLORIDA, DATE: _____
VALID ONLY WITH EMBOSSED SEAL.

PREPARED BY



OCALA
CITY ENGINEER'S OFFICE


NW 44th AVENUE EXTENSION PHASE 2

ROADWAY PROFILES

(1)

SHEET NO.
21

1" = 40' Horizontal
1" = 4' Vertical

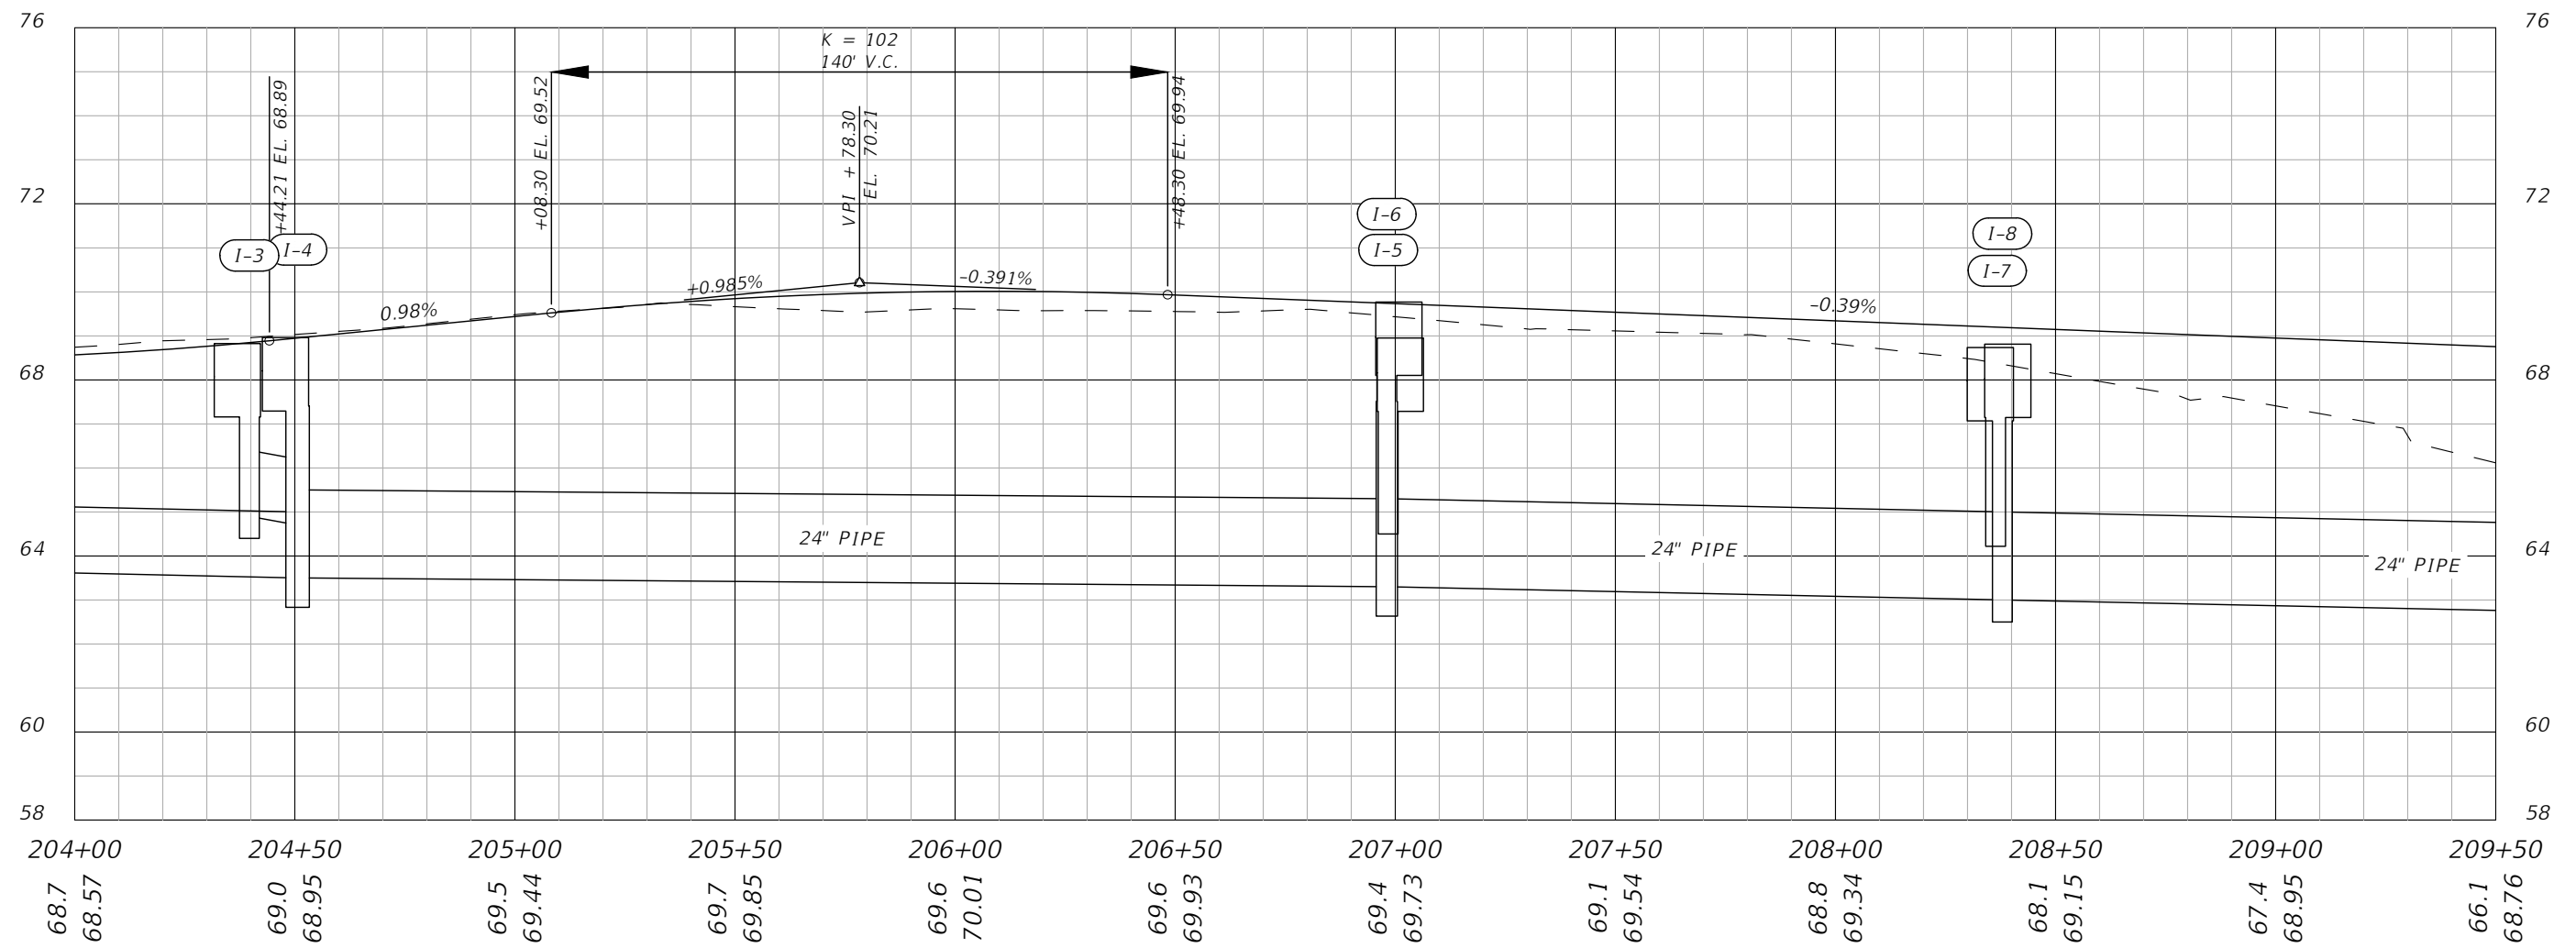

REVISIONS			
DATE	DESCRIPTION	DATE	DESCRIPTION

NOEL JOHN COOPER, P.E.
P.E. LICENSE NUMBER 69534
STATE OF FLORIDA, DATE: _____
VALID ONLY WITH EMBOSSED SEAL.

PREPARED BY




NW 44th AVENUE EXTENSION PHASE 2

ROADWAY PROFILES

(2)

SHEET NO.
22

1" = 40' Horizontal
1" = 4' Vertical

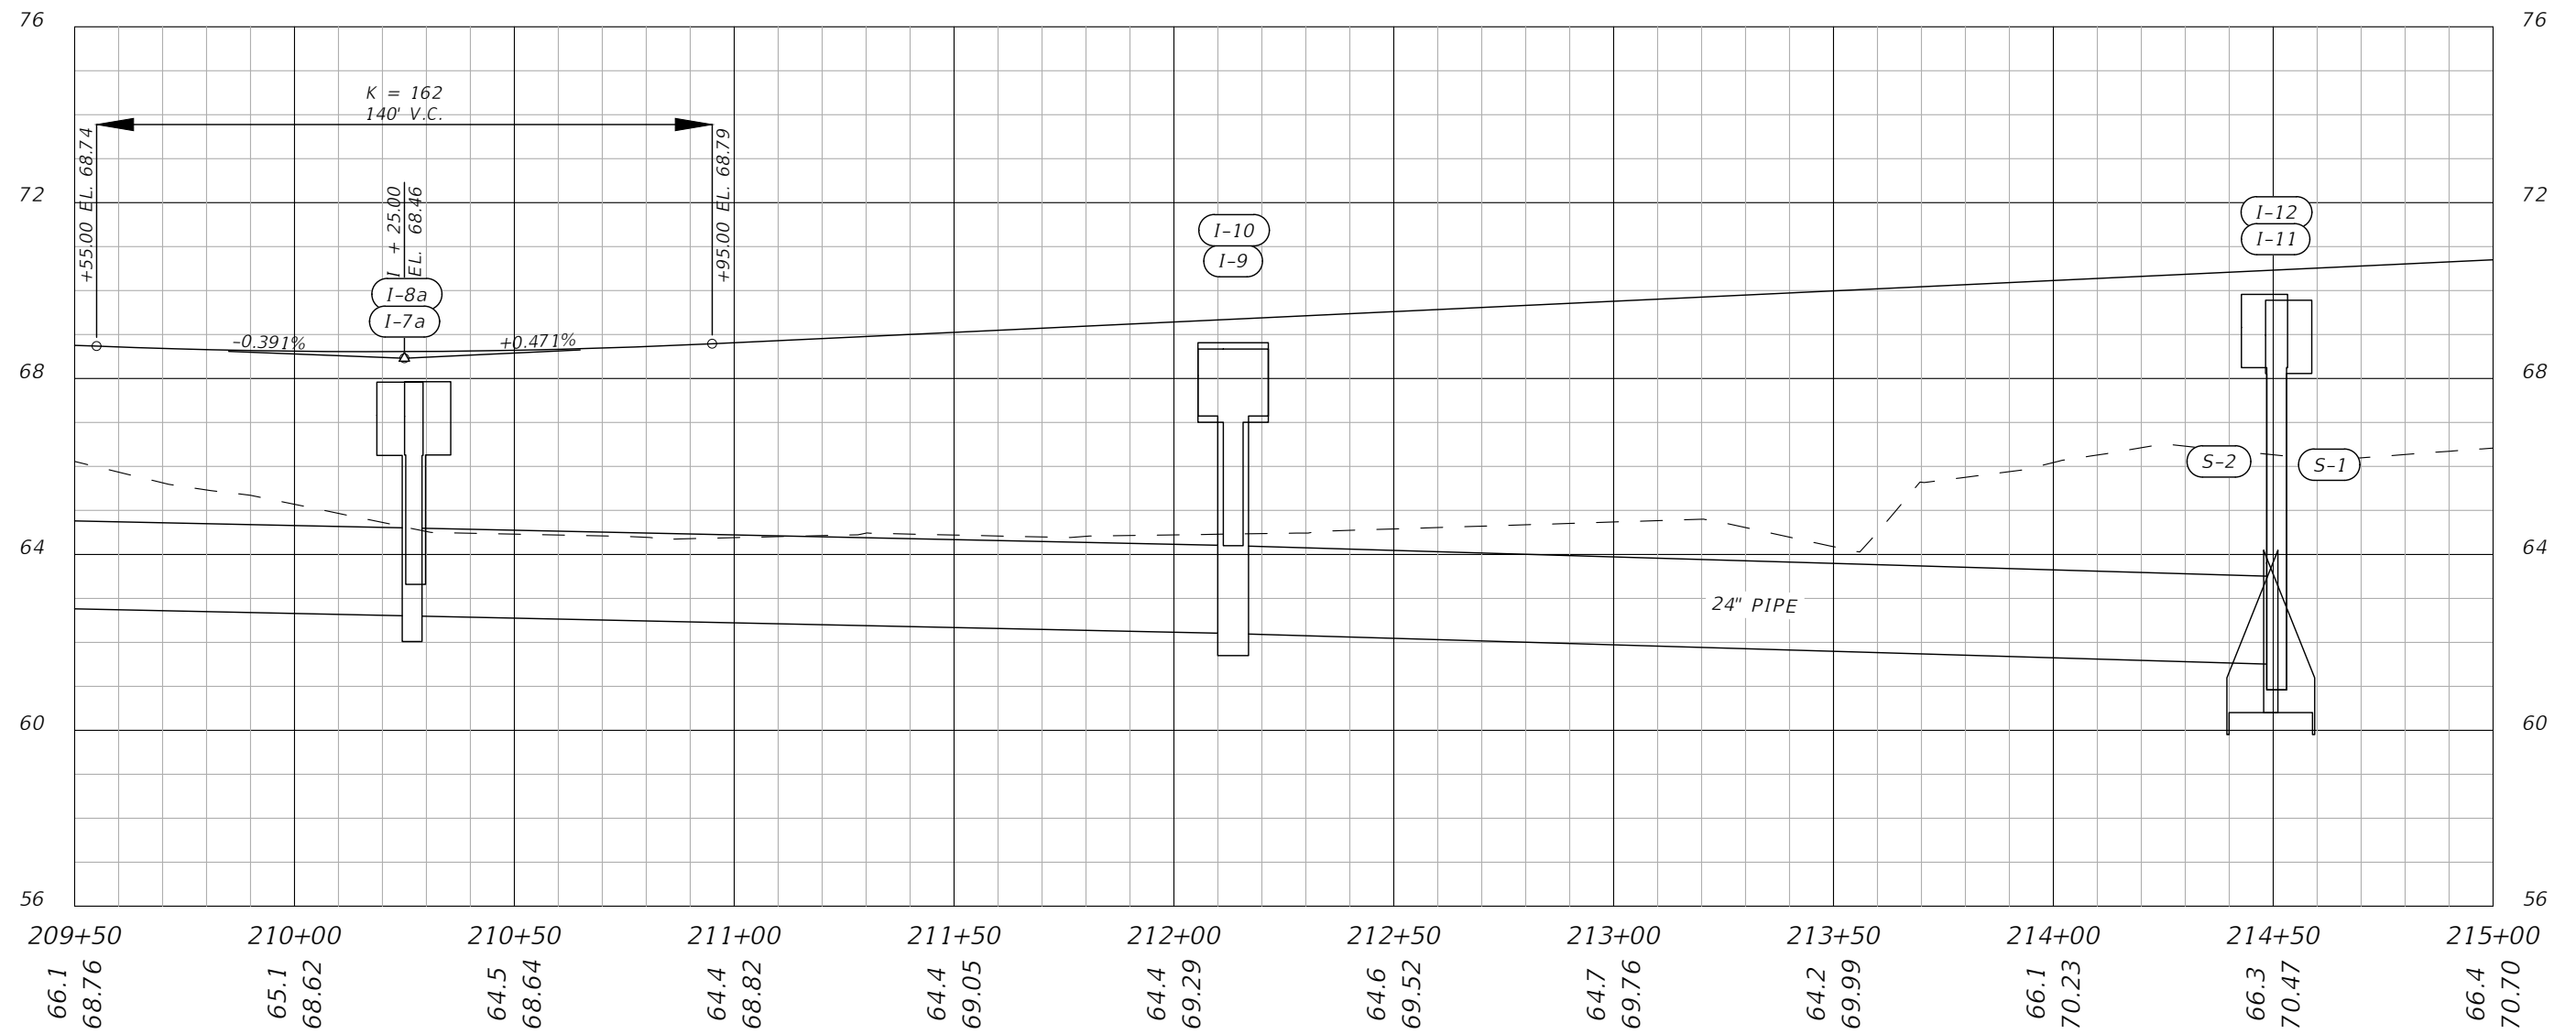

REVISIONS			
DATE	DESCRIPTION	DATE	DESCRIPTION

NOEL JOHN COOPER, P.E.
P.E. LICENSE NUMBER 69534
STATE OF FLORIDA, DATE: _____
VALID ONLY WITH EMBOSSED SEAL.

PREPARED BY


NW 44th AVENUE EXTENSION PHASE 2

ROADWAY PROFILES

(3)

SHEET NO.
23

1" = 40' Horizontal
1" = 4' Vertical

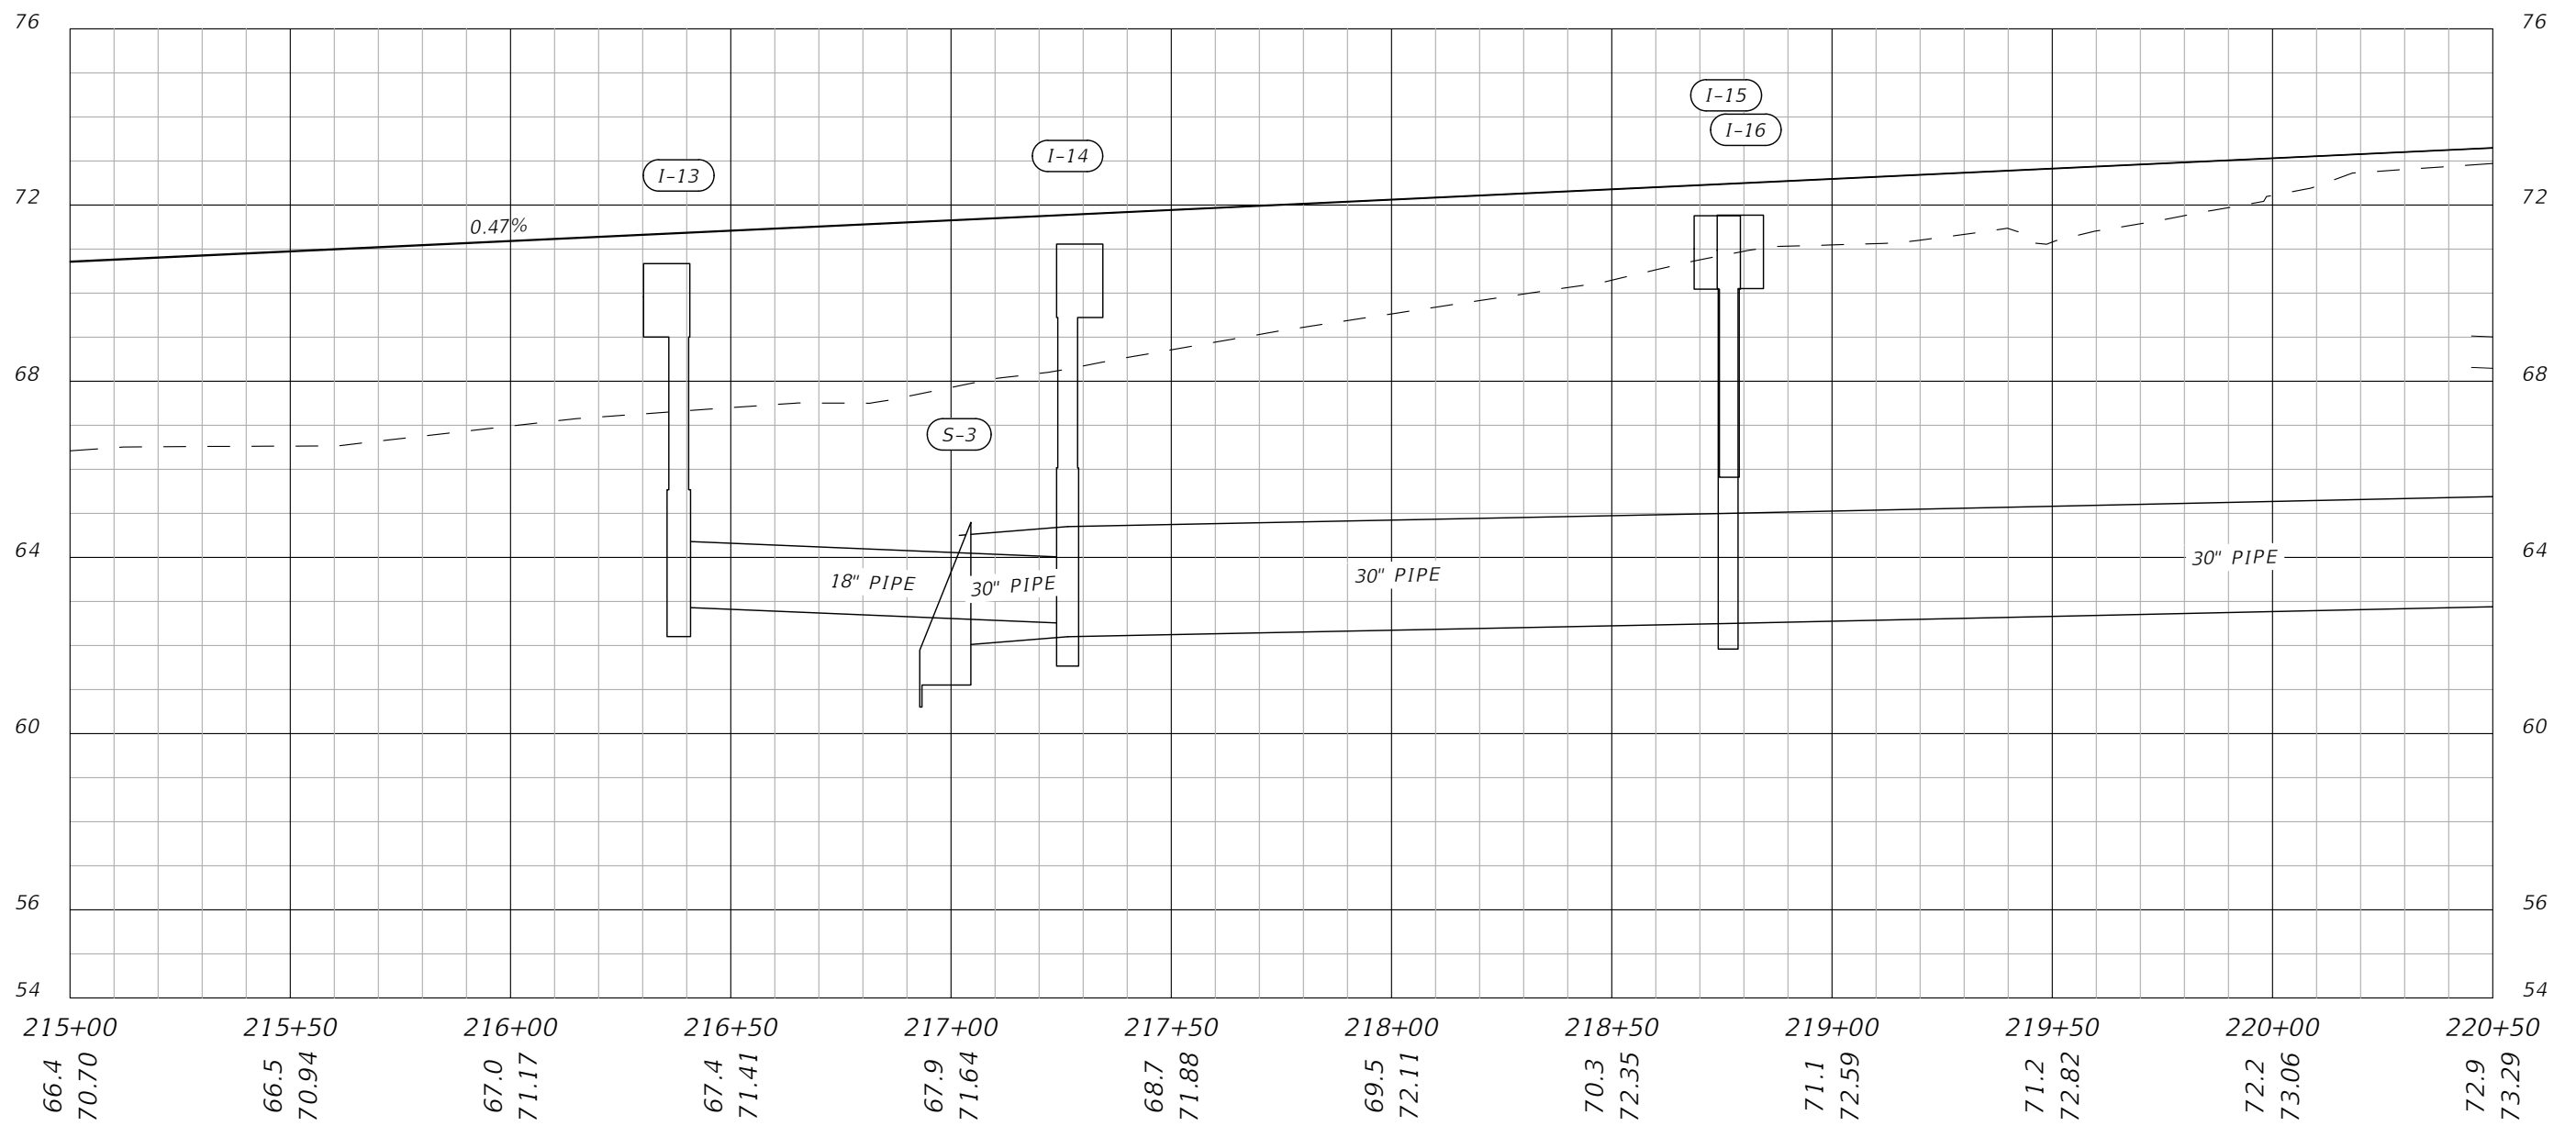

REVISIONS			
DATE	DESCRIPTION	DATE	DESCRIPTION

NOEL JOHN COOPER, P.E.
P.E. LICENSE NUMBER 69534
STATE OF FLORIDA, DATE: _____
VALID ONLY WITH EMBOSSED SEAL.

PREPARED BY




NW 44th AVENUE EXTENSION PHASE 2

ROADWAY PROFILES

(4)

SHEET NO.
24

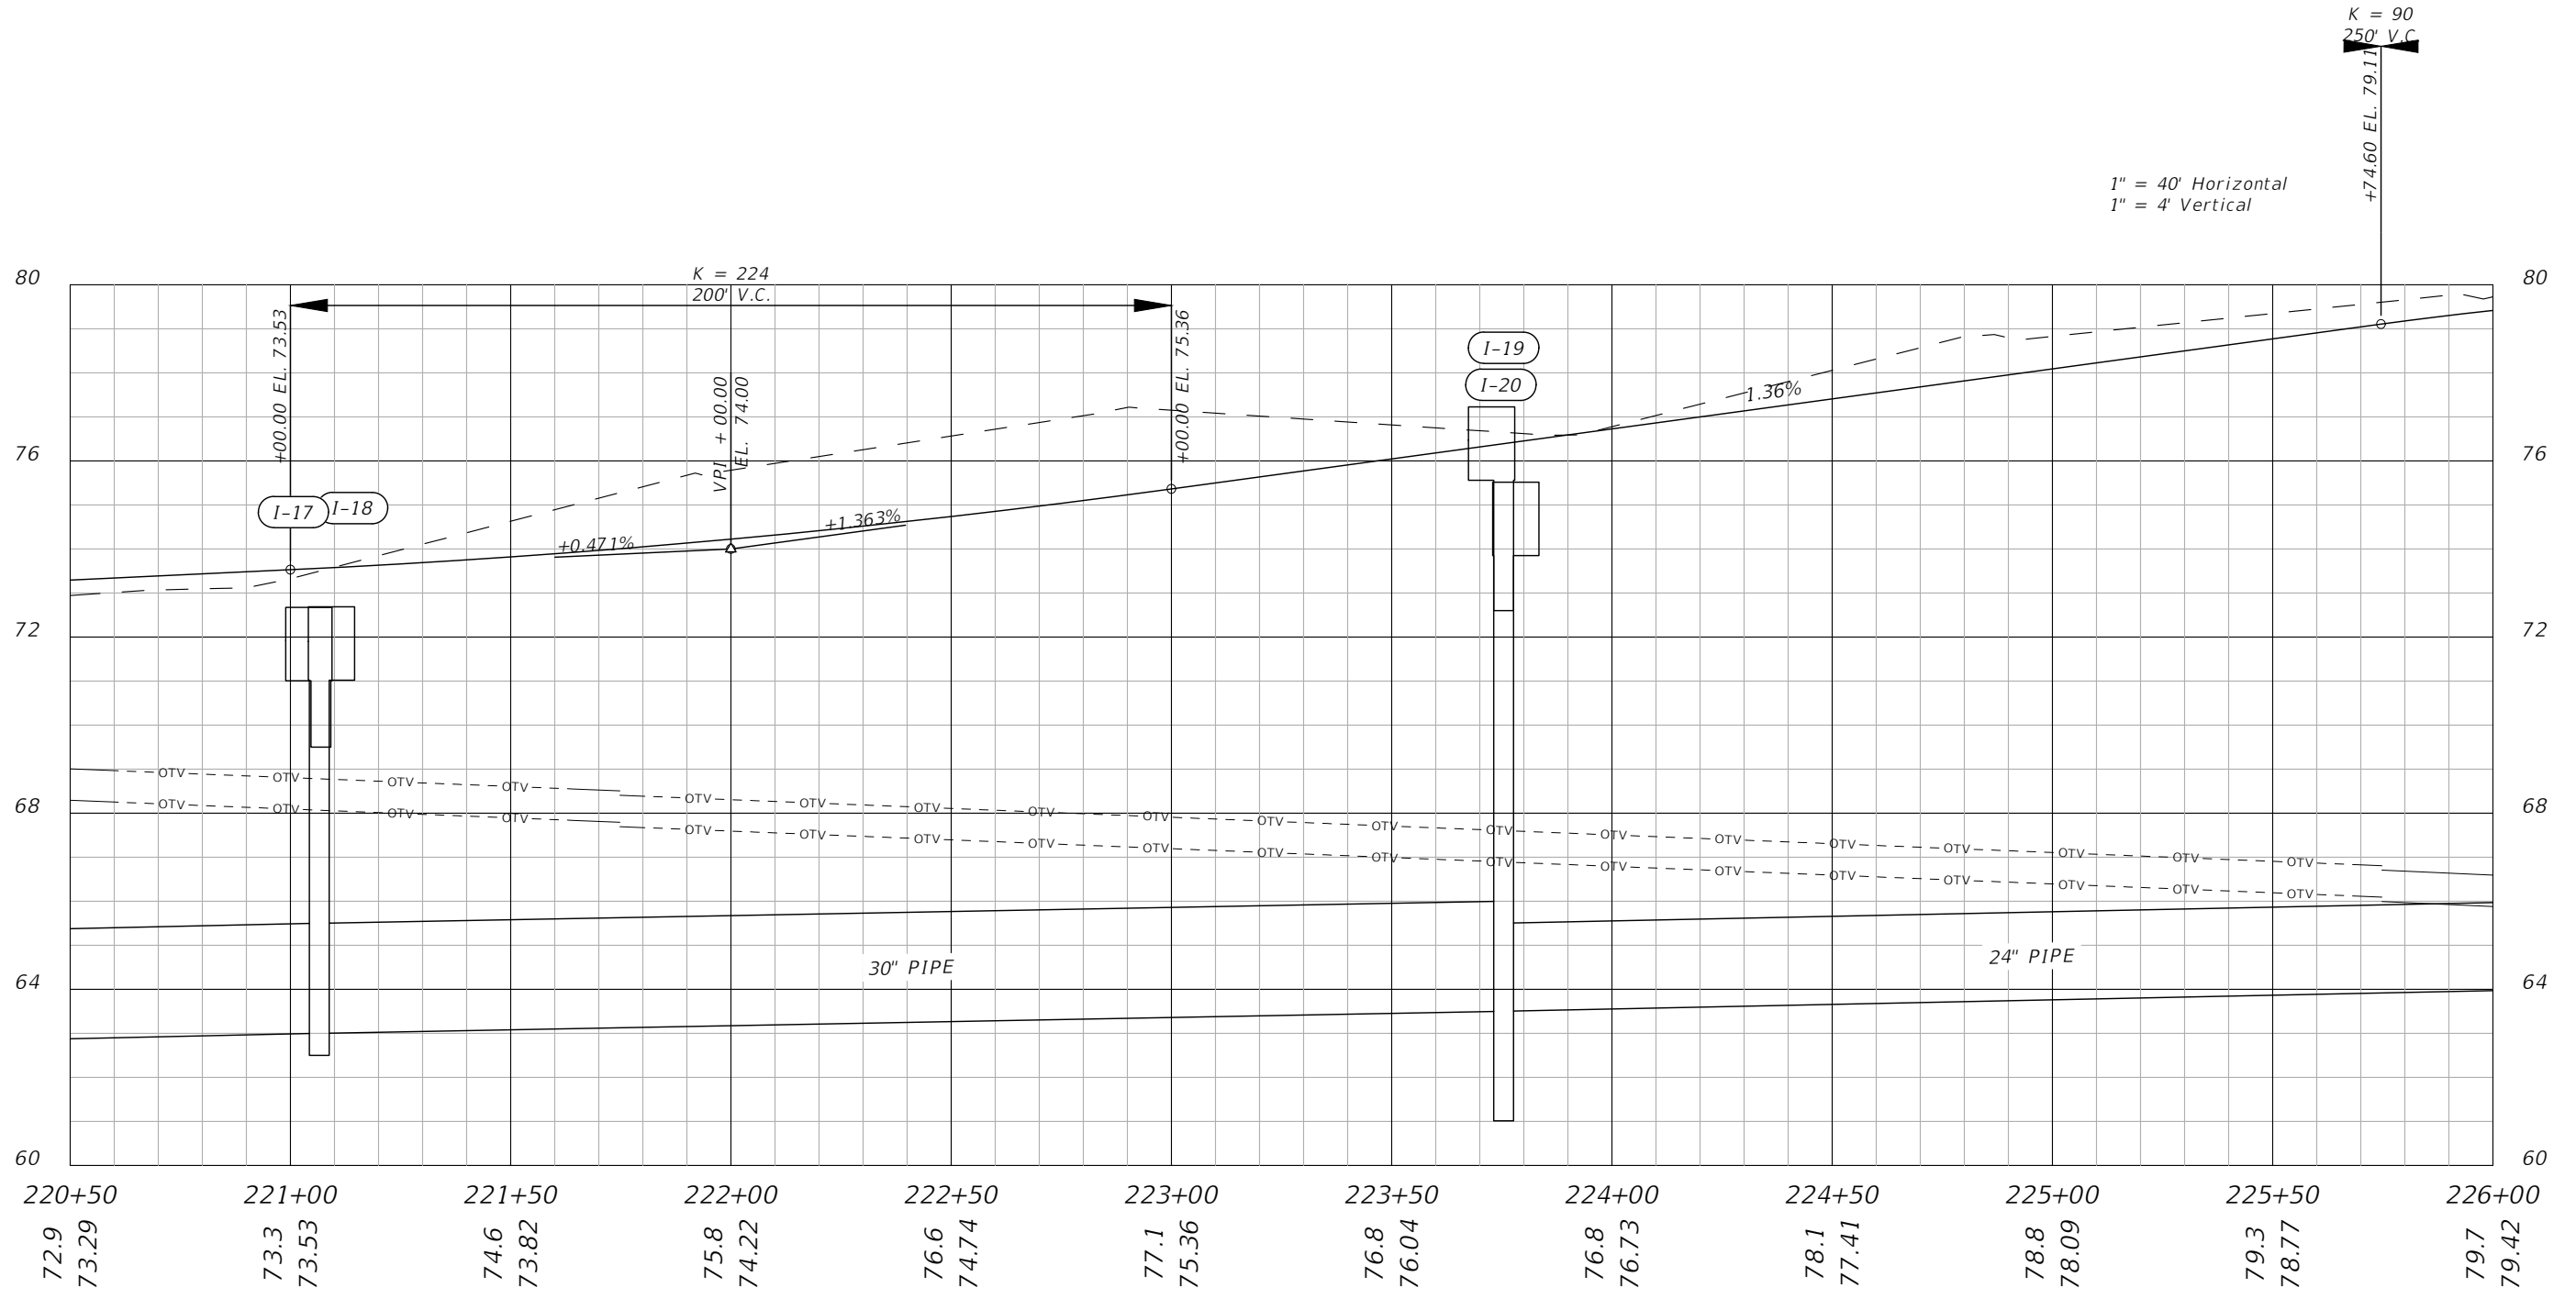

1" = 40' Horizontal
1" = 4' Vertical

REVISIONS			
DATE	DESCRIPTION	DATE	DESCRIPTION


NOEL JOHN COOPER, P.E.
P.E. LICENSE NUMBER 69534
STATE OF FLORIDA, DATE: _____
VALID ONLY WITH EMBOSSED SEAL.

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CITY ENGINEER'S OFFICE

NW 44th AVENUE EXTENSION PHASE 2
ROADWAY PROFILES
(5)

SHEET NO.
25

1" = 40' Horizontal
1" = 4' Vertical

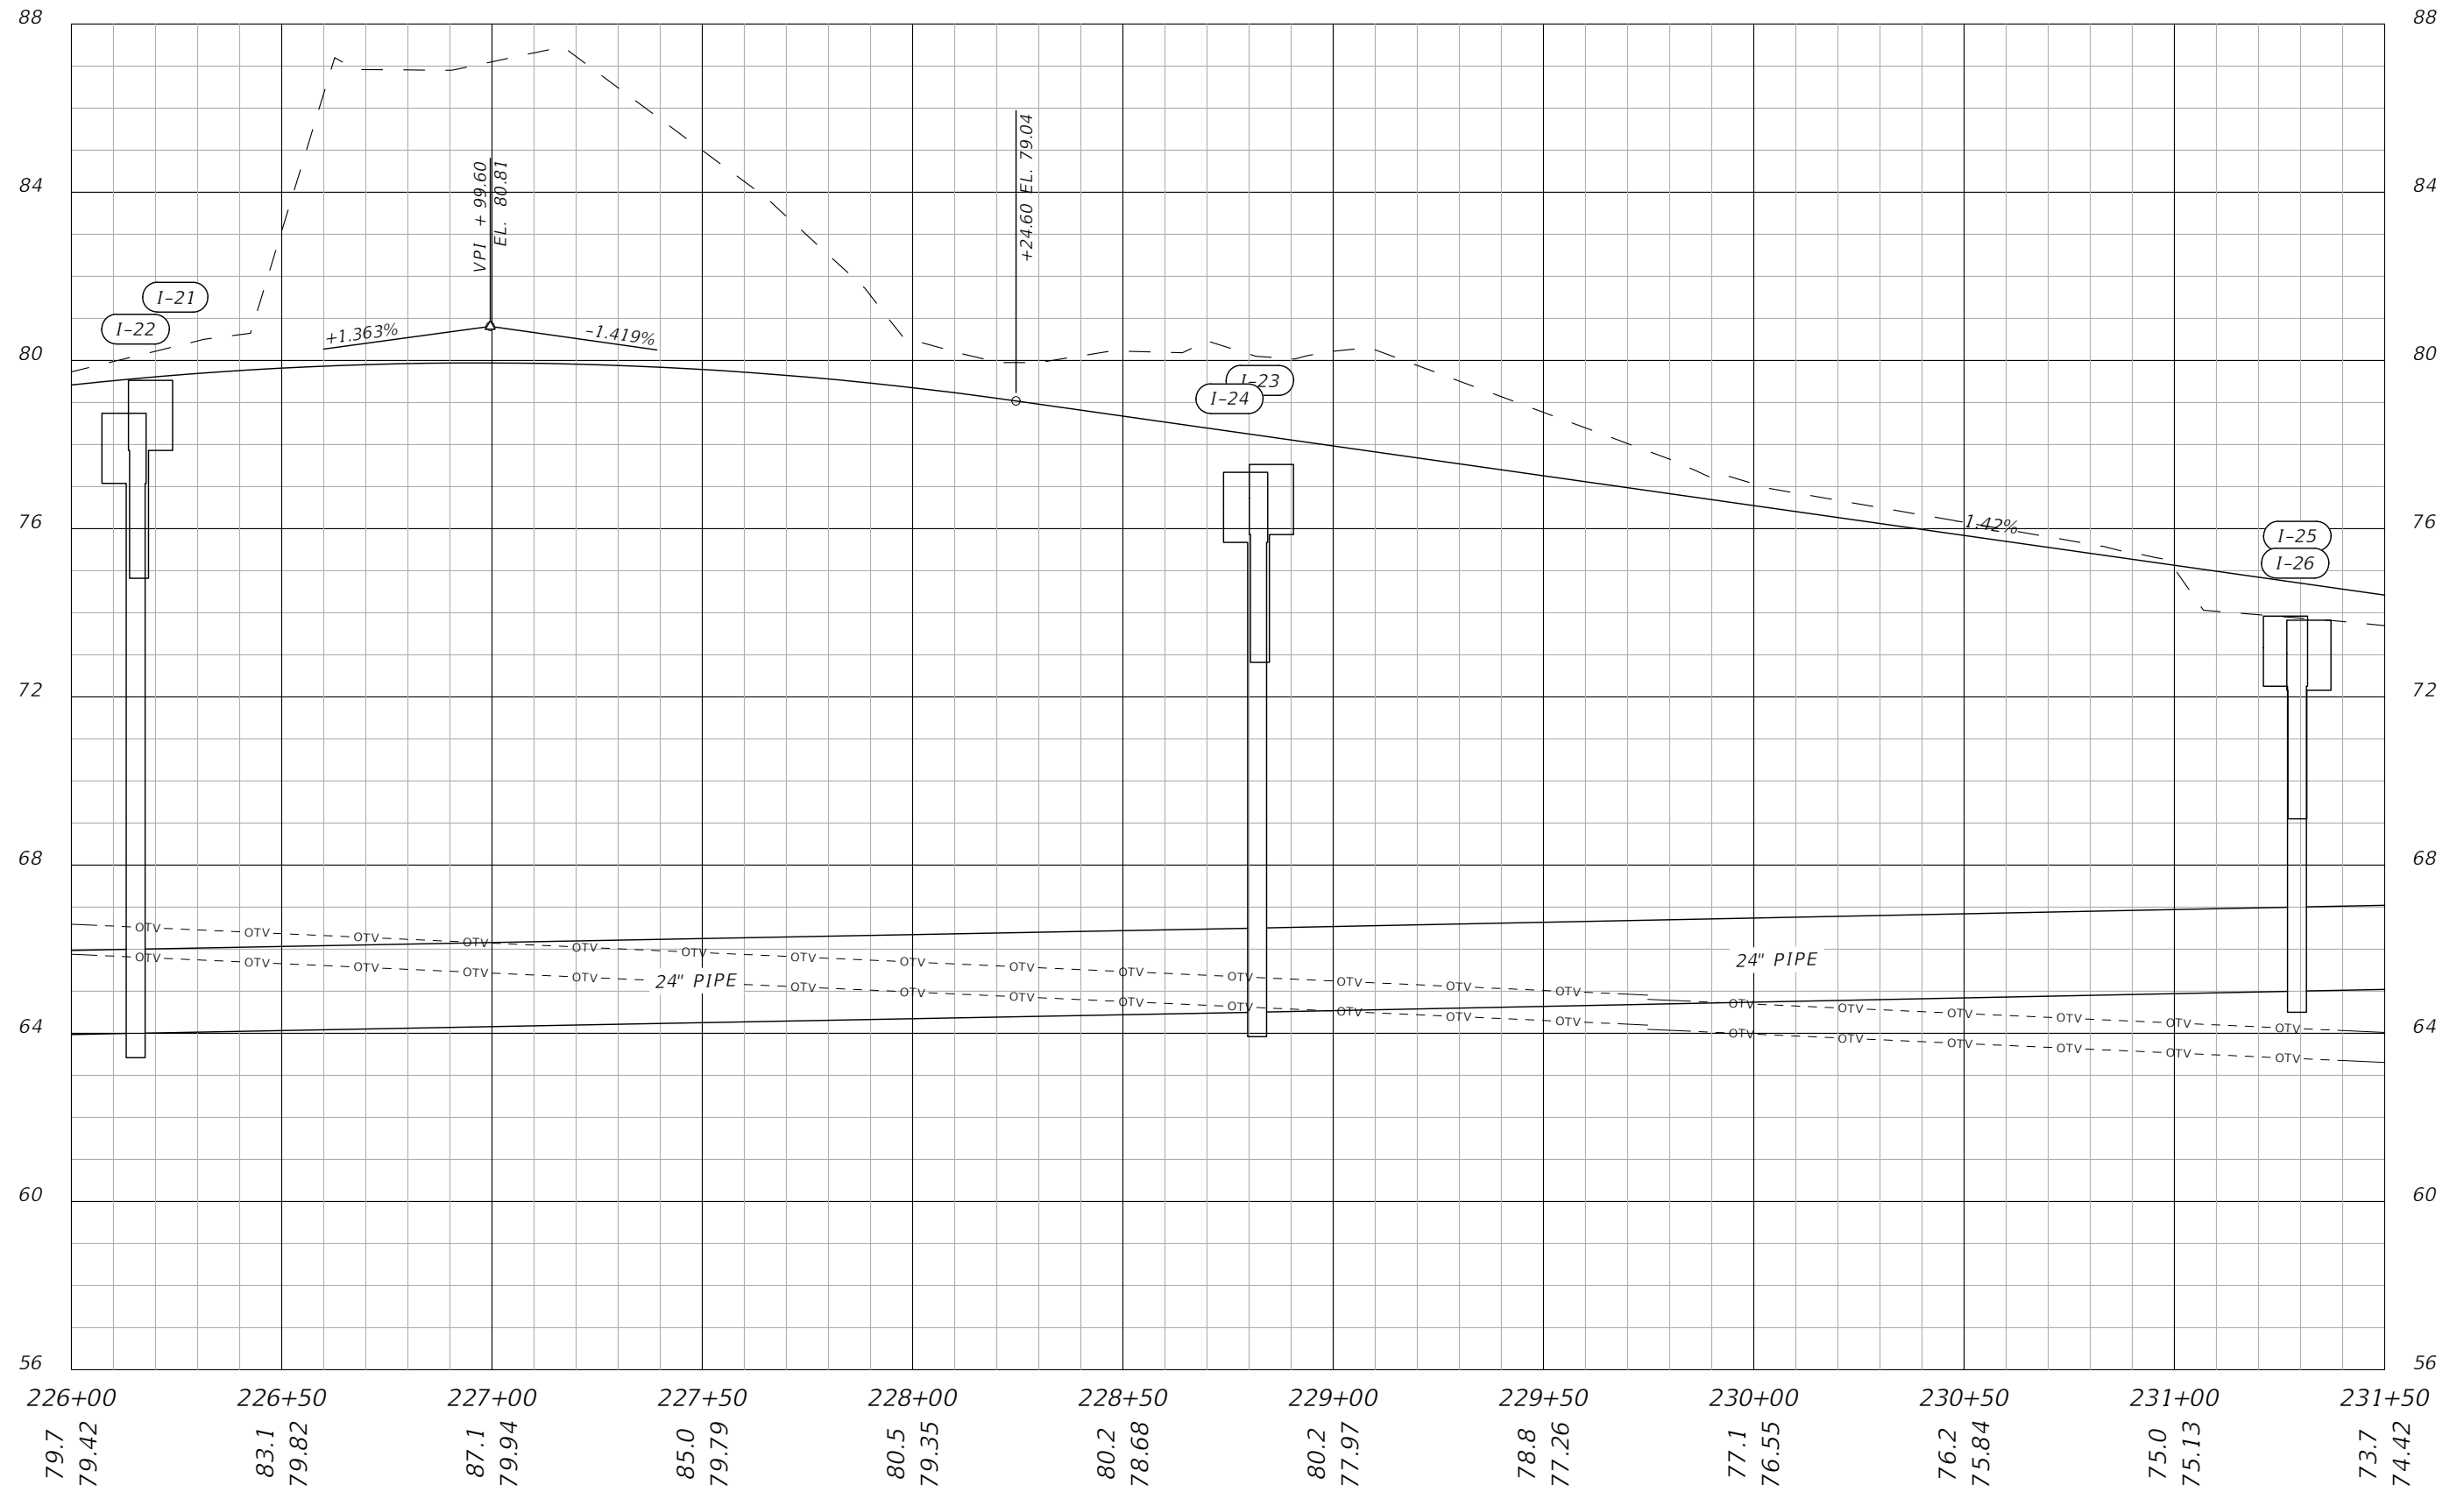

REVISIONS			
DATE	DESCRIPTION	DATE	DESCRIPTION

NOEL JOHN COOPER, P.E.
P.E. LICENSE NUMBER 69534
STATE OF FLORIDA, DATE: _____
VALID ONLY WITH EMBOSSED SEAL.

PREPARED BY


NW 44th AVENUE EXTENSION PHASE 2

ROADWAY PROFILES

(6)


SHEET NO.
26

1" = 40' Horizontal
1" = 4' Vertical

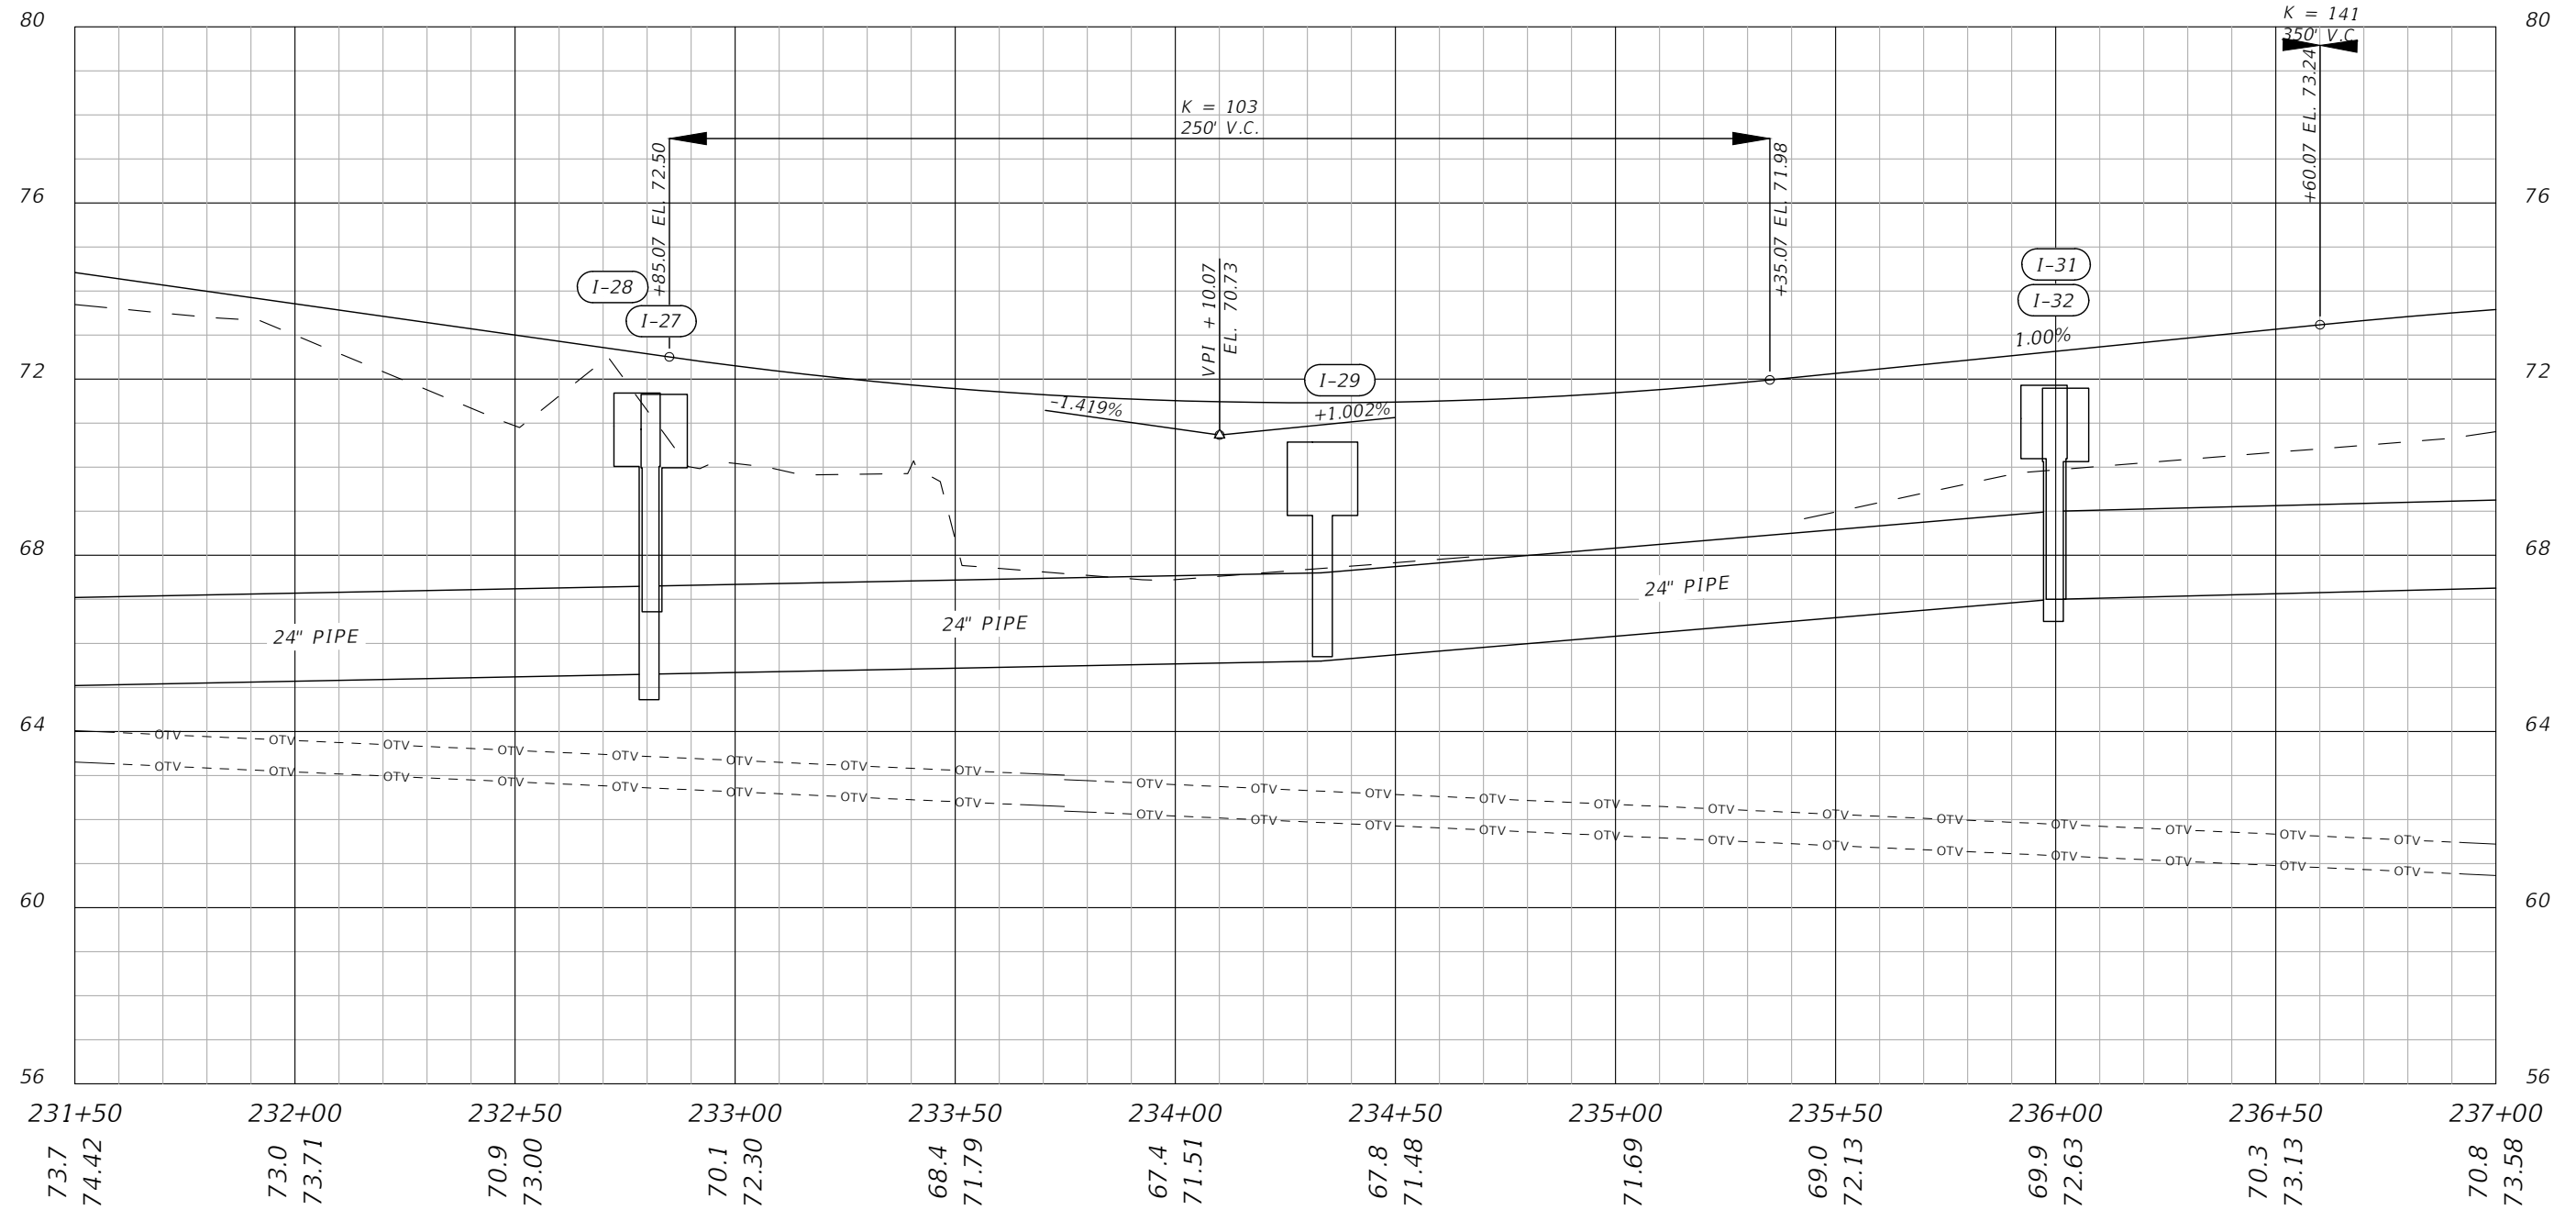

REVISIONS				NOEL JOHN COOPER, P.E. P.E. LICENSE NUMBER 69534 STATE OF FLORIDA, DATE: _____ VALID ONLY WITH EMBOSSED SEAL.		NW 44th AVENUE EXTENSION PHASE 2		SHEET NO. 27
DATE	DESCRIPTION	DATE	DESCRIPTION			ROADWAY PROFILES (7)		

1" = 40' Horizontal
1" = 4' Vertical

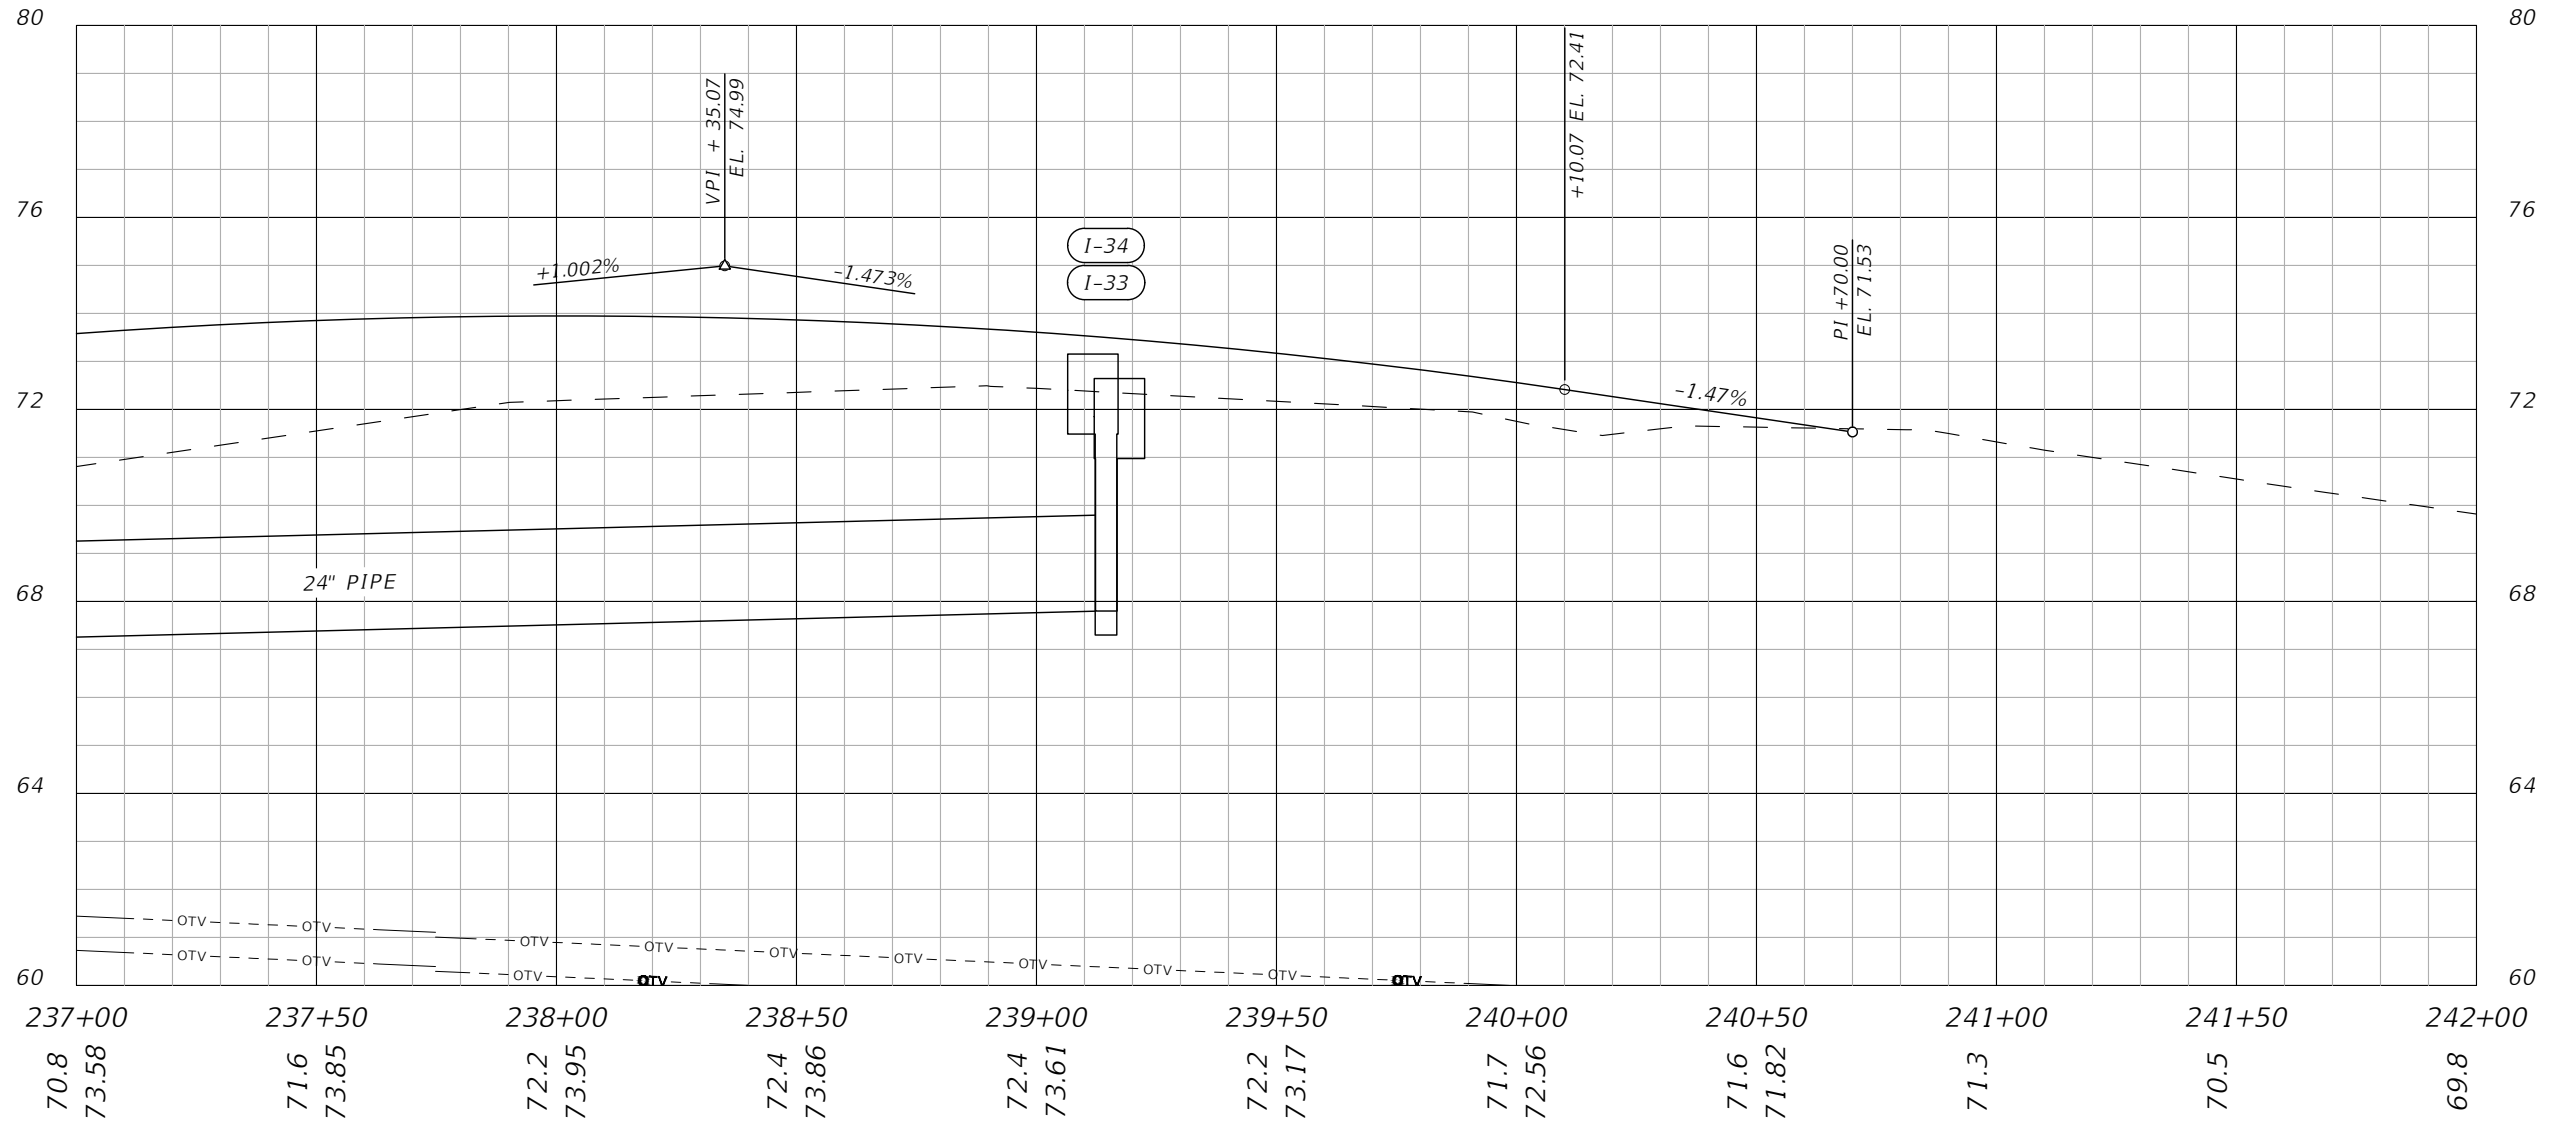

REVISIONS			
DATE	DESCRIPTION	DATE	DESCRIPTION

NOEL JOHN COOPER, P.E.
P.E. LICENSE NUMBER 69534
STATE OF FLORIDA, DATE: _____
VALID ONLY WITH EMBOSSED SEAL.


PREPARED BY

NW 44th AVENUE EXTENSION PHASE 2

ROADWAY PROFILES

(8)

SHEET NO.
28

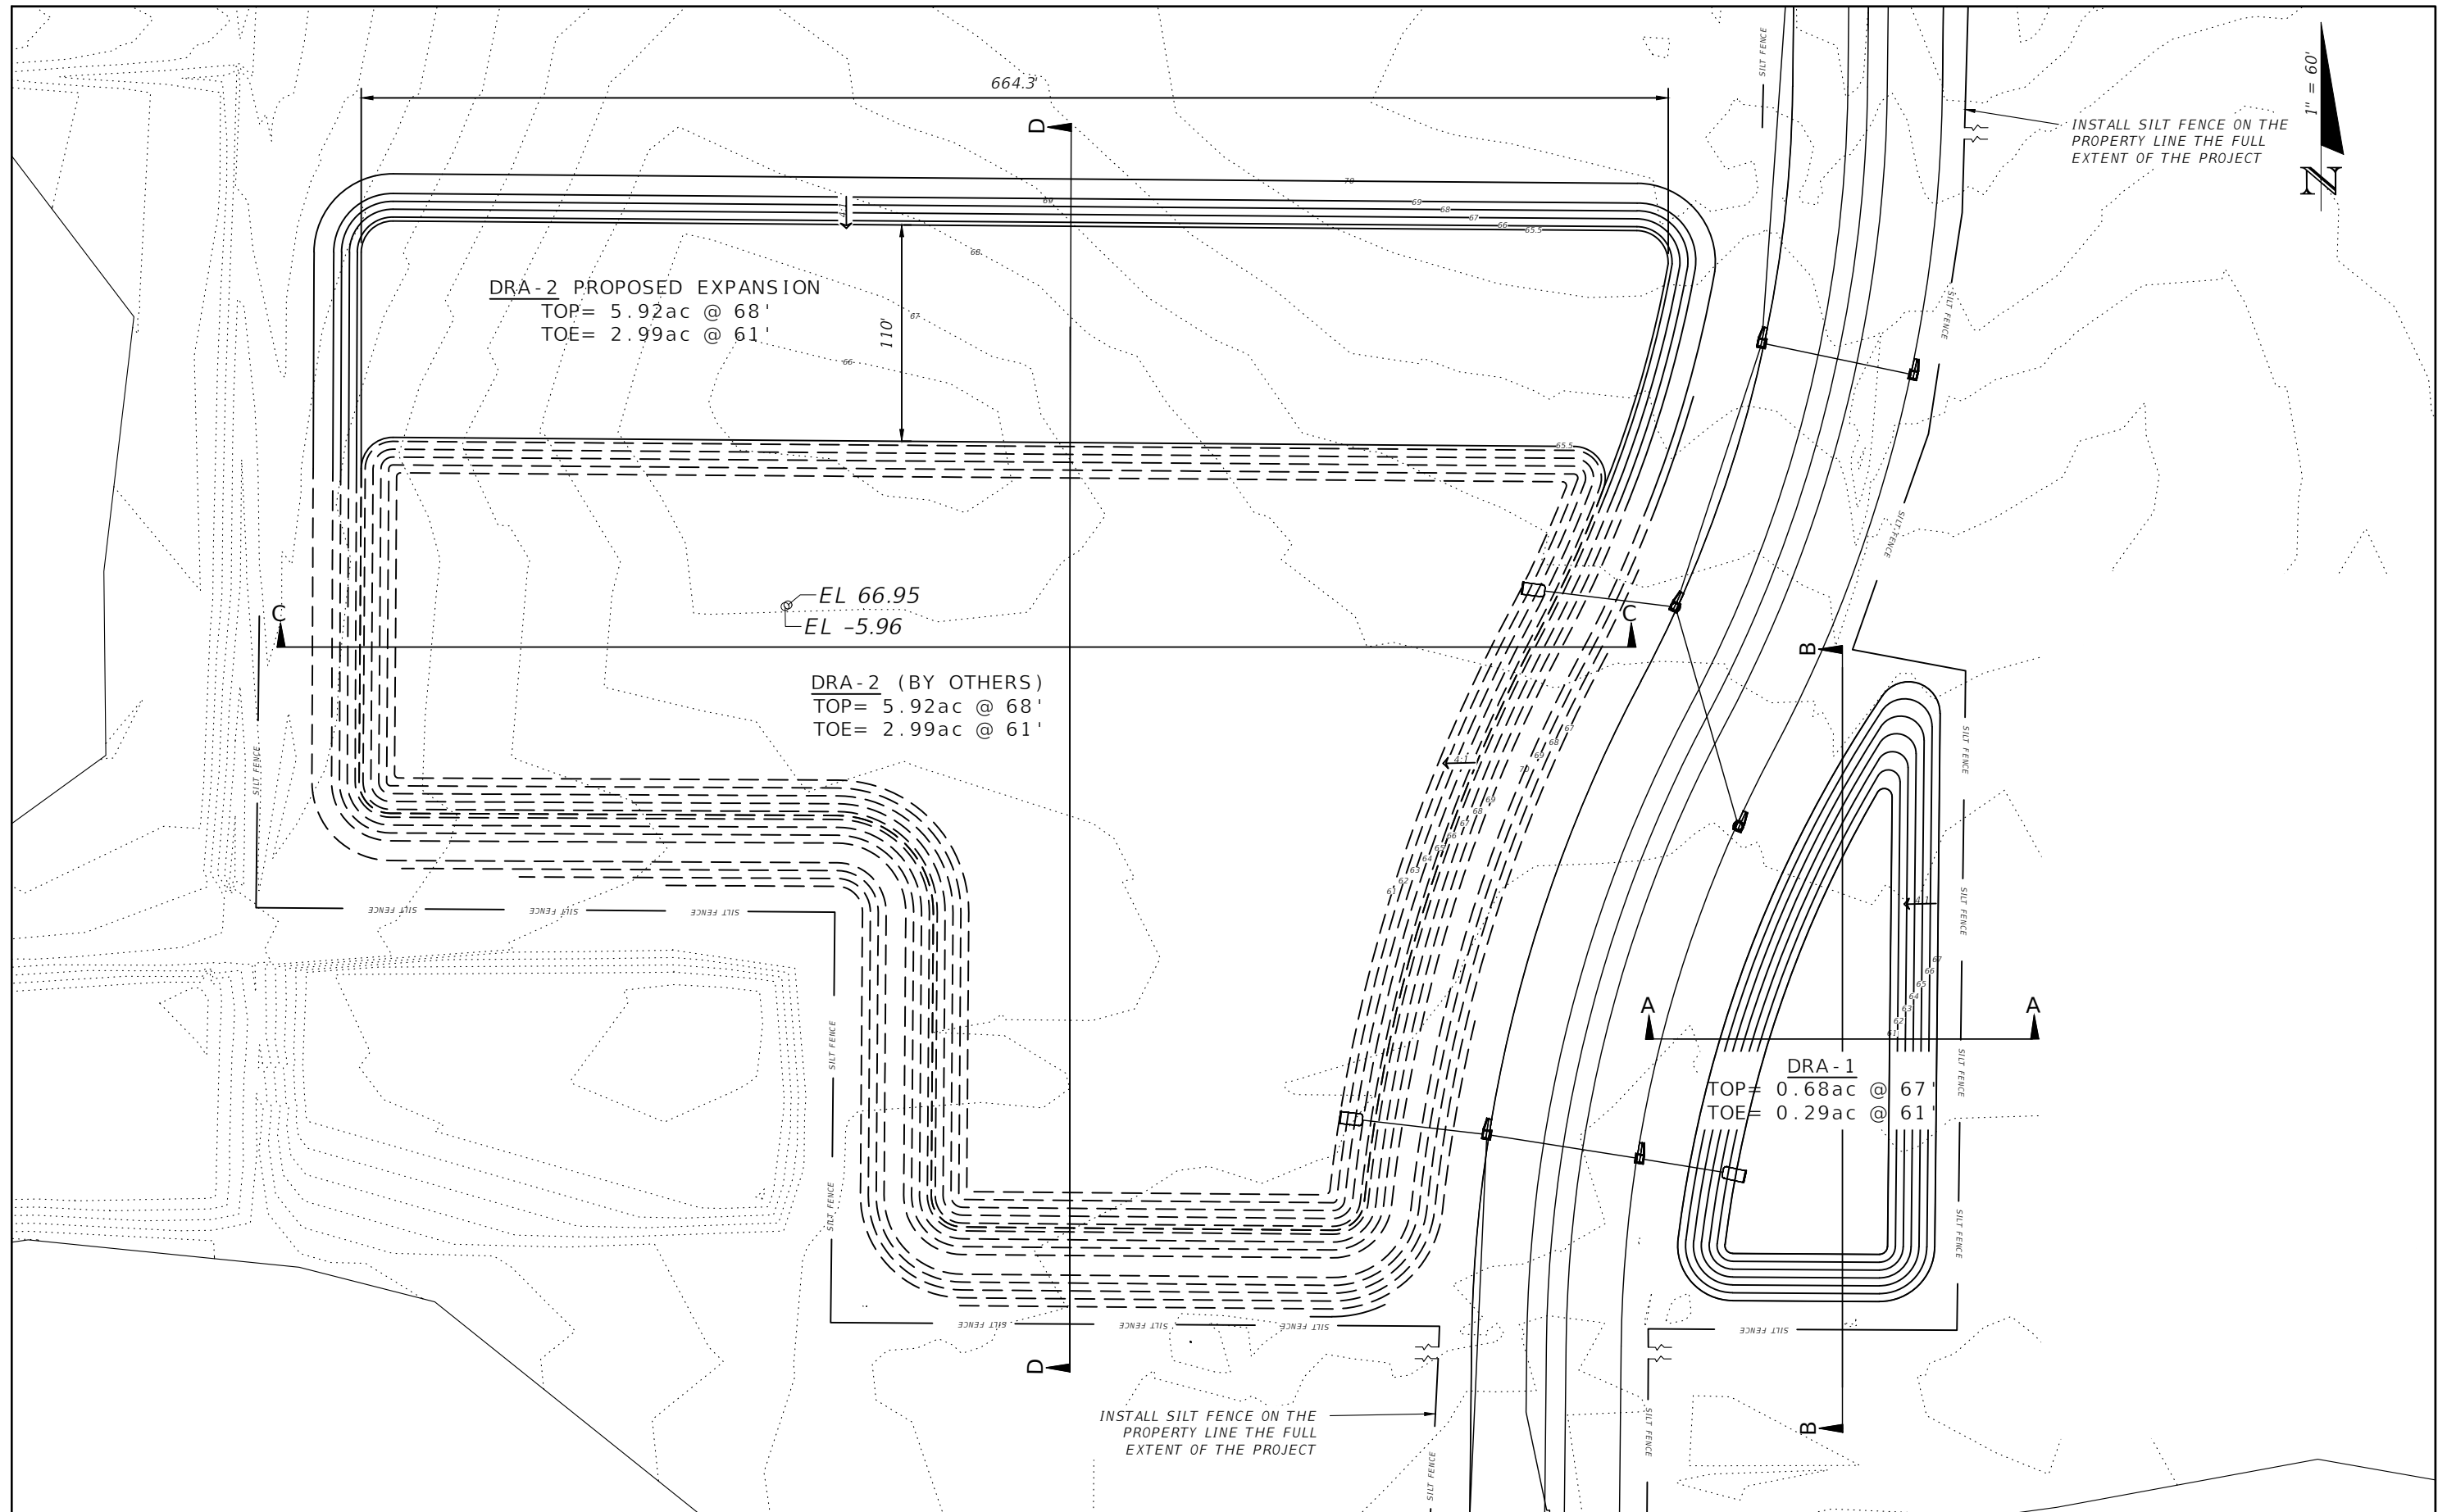

REVISIONS	
DATE	DESCRIPTION
4/6/23	Revised DRA-2 display & text

PAYAL PANDYA, P.E., CFM
 P.E. LICENSE NUMBER 73210

1805 NE 30TH AVE
 OCALA, FL 34470

PREPARED BY

OCALA
 CITY ENGINEER'S OFFICE

Gary Anson 4/6/2023 6:14:41 PM

NW 44th AVENUE EXTENSION PHASE 2

DRAINAGE RETENTION PLAN

SHEET NO.
 29



INSTALL SILT FENCE ON THE PROPERTY LINE THE FULL EXTENT OF THE PROJECT

DRA-2 PROPOSED EXPANSION
 TOP= 5.92ac @ 68'
 TOE= 2.99ac @ 61'


EL 66.95
 EL -5.96

DRA-2 (BY OTHERS)
 TOP= 5.92ac @ 68'
 TOE= 2.99ac @ 61'

DRA-1
 TOP= 0.68ac @ 67'
 TOE= 0.29ac @ 61'

- EROSION CONTROL NOTES:**
1. THE CONTRACTOR SHALL BE RESPONSIBLE FOR IMPLEMENTATION, INSPECTION AND REPORTING ALL REQUIREMENTS OF THE STORMWATER POLLUTION PREVENTION PLAN (SWPPP) AS PER THE REQUIREMENTS OF THE FDEP/NPDES GENERAL PERMIT.
 2. THE CONTRACTOR SHALL PREVENT THE DISCHARGE OF SEDIMENT DUE TO CONSTRUCTION OPERATIONS. ALL NEW AND EXISTING DRAIN PIPES AND STRUCTURES SHALL BE FLUSHED CLEAN PRIOR TO FINAL PAYMENT.
 3. ALL DUST SHALL BE CONTROLLED ON SITE. ONLY AREAS SCHEDULED FOR IMMEDIATE CONSTRUCTION SHALL BE CLEARED OR STRIPPED OF PAVEMENT OR VEGETATION. WATERING, APPLICATION OF CALCIUM CHLORIDE, OR OTHER PRIOR APPROVED MEANS OF DUST CONTROL SHALL BE EMPLOYED TO PREVENT THE EMANATION OF DUST FROM THE SITE. PERMANENT PAVEMENT, GRASSING, LANDSCAPING, AND OTHER SITE WORK SHALL BE INCORPORATED AS SOON AS POSSIBLE.
 4. LOADED HAUL TRUCKS SHALL BE COVERED WITH TARPULIN. EXCESS DIRT ON THE ROAD SHALL BE REMOVED DAILY. AREAS WITHIN THE LIMITS OF CONSTRUCTION SHALL BE DAMPENED WITH WATER AS REQUIRED FOR DUST CONTROL. TRUCKS SHALL ENTER AND EXIT PROJECT USING SE 16th ST. AS HAUL ROUTE.
 5. STAKED SILT FENCE SHALL BE PLACED AS SHOWN ON THE PLANS AND ACCORDING TO THE DETAIL SHEET.
 6. THE CONTRACTOR WILL PROVIDE THE CITY OF OCALA WITH AN EROSION CONTROL PLAN THAT WILL INCLUDE SPILL REPORTING AND RESPONSE. IF CONTAMINATED SOIL OR GROUNDWATER IS ENCOUNTERED, CONTACT THE PROJECT ENGINEER.
 7. THE FOLLOWING PRACTICES WILL BE USED TO MAINTAIN EROSION AND SEDIMENT CONTROLS:
 - A. ALL MEASURES WILL BE MAINTAINED IN GOOD WORKING ORDER.
 - B. IF A REPAIR IS NECESSARY, IT WILL BE INITIATED WITHIN 24 HOURS OF REPORT.
 - C. ALL POLLUTION CONTROLS SHALL BE MAINTAINED AT ALL TIMES.
 - D. BUILT UP SEDIMENT WILL BE REMOVED FROM STAKED SILT FENCE WHEN IT HAS REACHED ONE-HALF THE HEIGHT OF THE SILT FENCE.
 8. POLLUTION CONTROL MEASURES SHALL BE INSPECTED DAILY. WRITTEN DOCUMENTATION OF INSPECTIONS SHALL BE WRITTEN EVERY SEVEN CALENDAR DAYS AND WITHIN 24 HOURS OF A RAIN EVENT OF 0.5 INCHES OR GREATER.
 9. THE CONTRACTOR WILL BE RESPONSIBLE FOR THE MAINTENANCE AND REPAIRS OF EROSION AND SEDIMENT CONTROL DEVICES, AND REMOVAL OF EROSION AND SEDIMENT CONTROL DEVICES AFTER THE NOTICE OF TERMINATION. MAINTENANCE AND REPAIR REQUIRED FOR THE CONTROL AND ABATEMENT OF EROSION AND WATER POLLUTION SHALL BE INCLUDED IN THE PROJECT COST.


INSTALL SILT FENCE ON THE PROPERTY LINE THE FULL EXTENT OF THE PROJECT

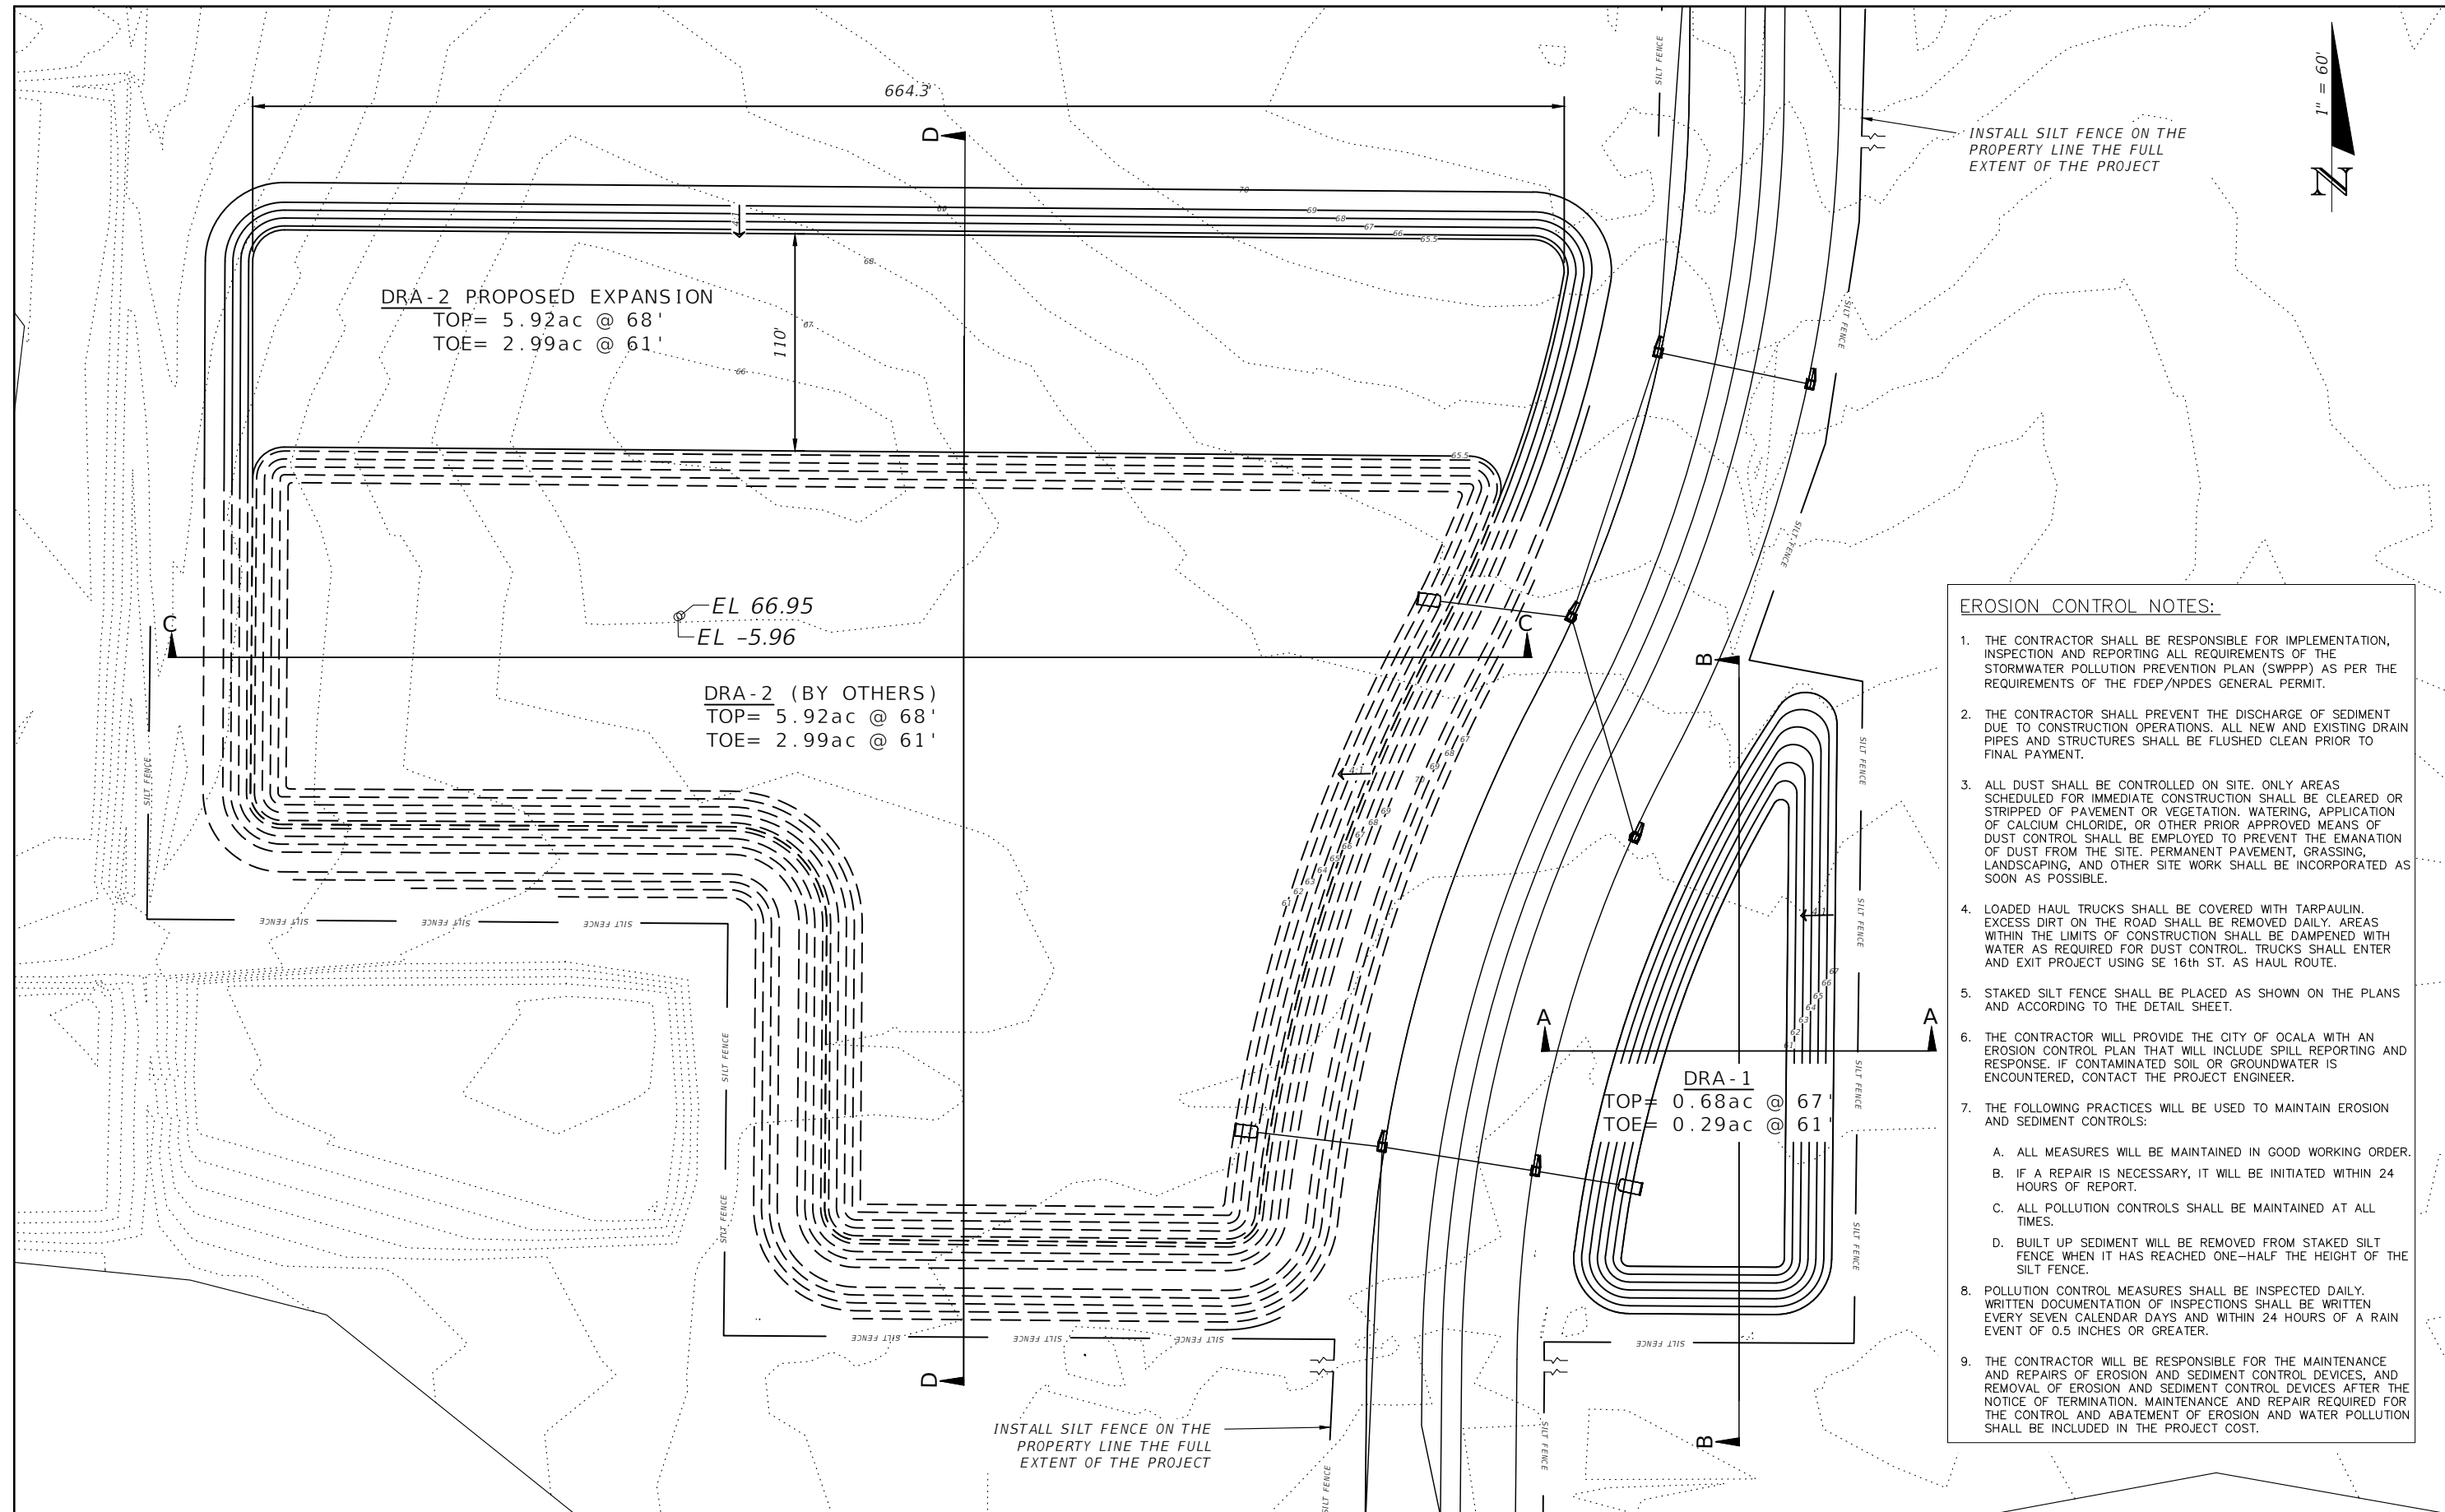


REVISIONS				PAYAL PANDYA, P.E., CFM P.E. LICENSE NUMBER 73210 1805 NE 30TH AVE OCALA, FL 34470	PREPARED BY Gary Anson	NW 44th AVENUE EXTENSION PHASE 2 STORM WATER POLLUTION PREVENTION PLAN	SHEET NO. 29A
DATE	DESCRIPTION	DATE	DESCRIPTION				
4/6/23	Revised DRA-2 & text						

DRA 1

SECTION B-B

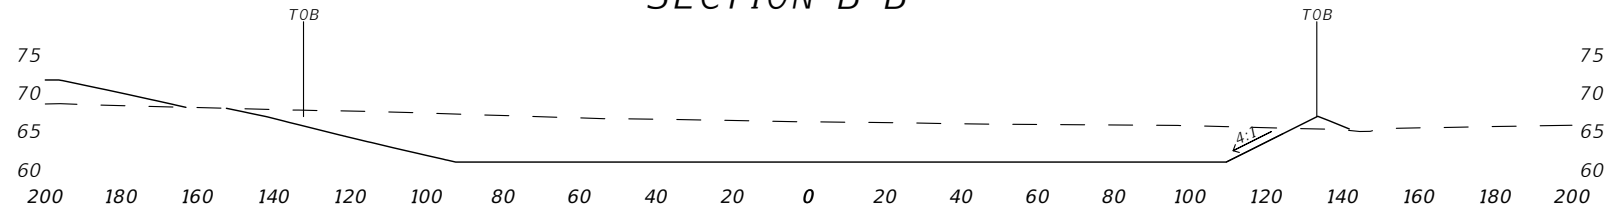


SECTION A-A

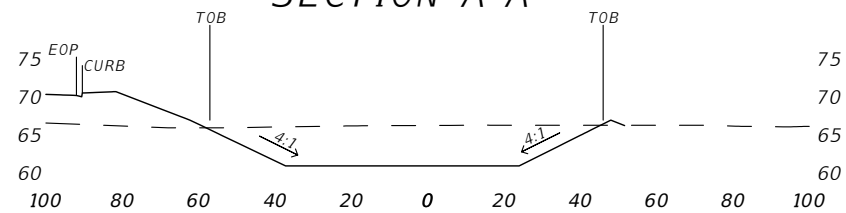



DRA 2

SECTION C-C

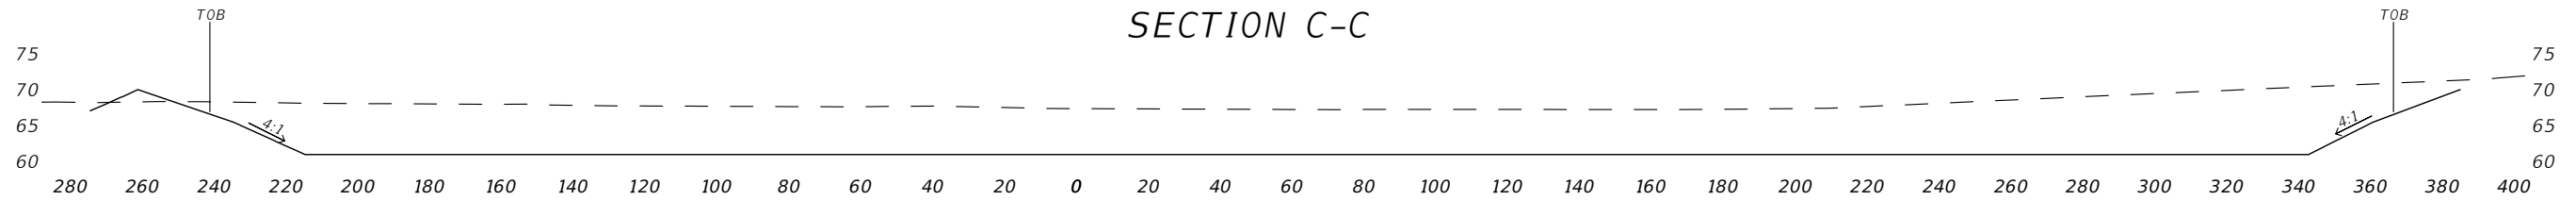

SECTION D-D

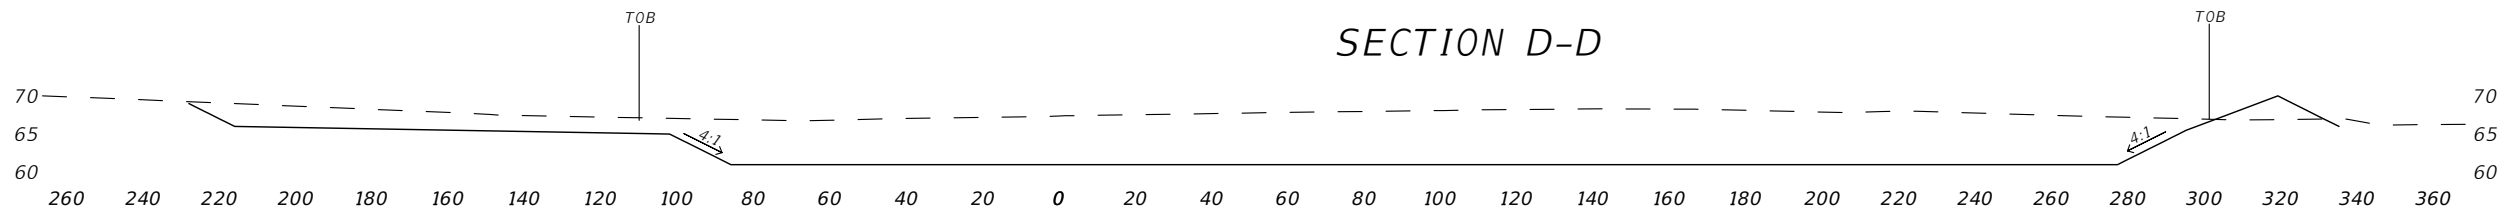


REVISIONS				PAYAL PANDYA, P.E., CFM P.E. LICENSE NUMBER 73210 1805 NE 30TH AVE OCALA, FL 34470	PREPARED BY	NW 44th AVENUE EXTENSION PHASE 2	SHEET NO.
DATE	DESCRIPTION	DATE	DESCRIPTION			<i>DRAINAGE CROSS-SECTIONS</i>	30

STRUCTURE TABLE

QTY	STR. #	STATION	SIDE	DESCRIPTION	CON PIPE	RIM ELEV.	SUMP ELEV.
P	I-1	203+61.13	Rt.	Index No. 425-021 - Curb Inlet Type 6 with Rectangular Structure Bottom	P-1	68.48	64.50
P	I-2	203+61.00	Lt.	Index No. 425-021 - Curb Inlet Type 6 with Round Bottom	P-2 P-1	67.66	63.62
P	I-3	204+39.67	Rt.	Index No. 425-021 - Curb Inlet Type 5 (Left) with Rectangular Structure Bottom	P-3	68.83	64.90
P	I-4	204+50.62	Lt.	Index No. 425-021 - Curb Inlet Type 5 (Left) with Round Structure Bottom	P-4 P-2 P-3	68.96	63.50
P	I-5	206+98.38	Rt.	Index No. 425-021 - Curb Inlet Type 5 (Right) with Rectangular Structure Bottom	P-5	68.95	65.00
P	I-6	206+98.07	Lt.	Index No. 425-021 - Curb Inlet Type 5 (Right) with Round Structure Bottom	P-6 P-4 P-5	69.77	63.30
P	I-7	208+36.39	Rt.	Index No. 425-021 - Curb Inlet Type 5 (Right) with Rectangular Structure Bottom	P-7	68.81	64.72
P	I-7a	210+27.54	Rt.	Index No. 425-021 - Curb Inlet Type 5 (Right) with Rectangular Structure Bottom	P-9	67.93	63.82
P	I-8	208+37.92	Lt.	Index No. 425-021 - Curb Inlet Type 5 (Left) with Rectangular Structure Bottom	P-8 P-6 P-7	68.74	63.00
P	I-8a	210+26.74	Lt.	Index No. 425-021 - Curb Inlet Type 5 (Left) with Rectangular Structure Bottom	P-10 P-8 P-9	67.92	62.52
P	I-9	212+13.48	Rt.	Index No. 425-021 - Curb Inlet Type 6 with Rectangular Structure Bottom	P-11	68.67	64.70
P	I-10	212+13.47	Lt.	Index No. 425-021 - Curb Inlet Type 6 with Rectangular Structure Bottom	P-12 P-10 P-11	68.82	62.20
P	I-11	214+50.77	Rt.	Index No. 425-021 - Curb Inlet Type 5 (Left) with Rectangular Structure Bottom	P-15 P-14	69.92	61.42
P	I-12	214+50.77	Lt.	Index No. 425-021 - Curb Inlet Type 5 (Right) with Rectangular Structure Bottom	P-14 P-13 P-12	69.78	61.42
P	I-13	216+38.18	Rt.	Index No. 425-021 - Curb Inlet Type 5 (Left) with Round Structure Bottom	P-16	70.67	62.87
P	I-14	217+26.47	Lt.	Index No. 425-021 - Curb Inlet Type 5 (Right) with Round Structure Bottom	P-16 P-17 P-18	71.11	62.20
P	I-15	218+76.69	Rt.	Index No. 425-021 - Curb Inlet Type 5 (Left) with Rectangular Structure Bottom	P-19	71.76	66.32
P	I-16	218+76.42	Lt.	Index No. 425-021 - Curb Inlet Type 5 (Right) with Rectangular Structure Bottom	P-19 P-20 P-18	71.77	62.42
P	I-17	221+06.93	Rt.	Index No. 425-021 - Curb Inlet Type 5 (Left) with Rectangular Structure Bottom	P-21	72.67	70.00
P	I-18	221+06.56	Lt.	Index No. 425-021 - Curb Inlet Type 5 (Right) with Rectangular Structure Bottom	P-21 P-20 P-22	72.69	63.00


QTY	STR. #	STATION	SIDE	DESCRIPTION	CON PIPE	RIM ELEV.	SUMP ELEV.
P	I-19	223+75.43	Rt.	Index No. 425-021 - Curb Inlet Type 5 (Left) with Rectangular Structure Bottom	P-23	77.22	73.10
P	I-20	223+75.43	Lt.	Index No. 425-021 - Curb Inlet Type 5 (Right) with Rectangular Structure Bottom	P-23 P-22 P-24	75.52	61.51
P	I-21	226+16.07	Rt.	Index No. 425-021 - Curb Inlet Type 5 (Right) with Rectangular Structure Bottom	P-25	79.52	75.32
P	I-22	226+15.27	Lt.	Index No. 425-021 - Curb Inlet Type 5 (Left) with Rectangular Structure Bottom	P-25 P-24 P-26	78.74	63.92
P	I-23	228+82.58	Rt.	Index No. 425-021 - Curb Inlet Type 5 (Right) with Rectangular Structure Bottom	P-27	77.52	73.32
P	I-24	228+81.92	Lt.	Index No. 425-021 - Curb Inlet Type 5 (Left) with Rectangular Structure Bottom	P-27 P-26 P-28	77.34	64.42
P	I-25	231+29.24	Rt.	Index No. 425-021 - Curb Inlet Type 5 (Right) with Rectangular Structure Bottom	P-29	73.82	69.60
P	I-26	231+29.16	Lt.	Index No. 425-021 - Curb Inlet Type 5 (Left) with Rectangular Structure Bottom	P-29 P-28 P-30	73.92	65.00
P	I-27	232+81.14	Rt.	Index No. 425-021 - Curb Inlet Type 5 (Right) with Rectangular Structure Bottom	P-31	71.65	67.22
P	I-28	232+80.46	Lt.	Index No. 425-021 - Curb Inlet Type 5 (Left) with Rectangular Structure Bottom	P-30 P-32 P-31	71.68	65.22
P	I-29	234+33.43	Rt.	Index No. 425-021 - Curb Inlet Type 6 with Rectangular Structure Bottom	P-33	70.57	66.20
P	I-30	234+33.12	Lt.	Index No. 425-021 - Curb Inlet Type 6 with Rectangular Structure Bottom	P-33 P-32 P-34	70.27	65.52
P	I-31	236+00.11	Rt.	Index No. 425-021 - Curb Inlet Type 5 (Left) with Rectangular Structure Bottom	P-35	71.86	67.50
P	I-32	235+99.51	Lt.	Index No. 425-021 - Curb Inlet Type 5 (Right) with Rectangular Structure Bottom	P-35 P-34 P-36	71.79	67.00
P	I-33	239+14.53	Rt.	Index No. 425-021 - Curb Inlet Type 5 (Right) with Rectangular Structure Bottom	P-37	72.64	68.30
P	I-34	239+14.49	Lt.	Index No. 425-021 - Curb Inlet Type 5 (Left) with Rectangular Structure Bottom	P-37 P-36	73.15	67.80
P	S-1	214+50.44	Rt.	Index No. 430-021 - Cross Drain MES with 1:4 Slope - Single Round Conc. Pipe	P-15	64.09	???
P	S-2	214+48.43	Lt.	Index No. 430-021 - Cross Drain MES with 1:4 Slope - Single Round Conc. Pipe	P-13	64.09	???
P	S-3	217+01.86	Lt.	Index No. 430-021 - Cross Drain MES with 1:4 Slope - Single Round Conc. Pipe	P-17	64.79	???

REVISIONS				PREPARED BY	NW 44th AVENUE EXTENSION	SHEET NO.
DATE	DESCRIPTION	DATE	DESCRIPTION			
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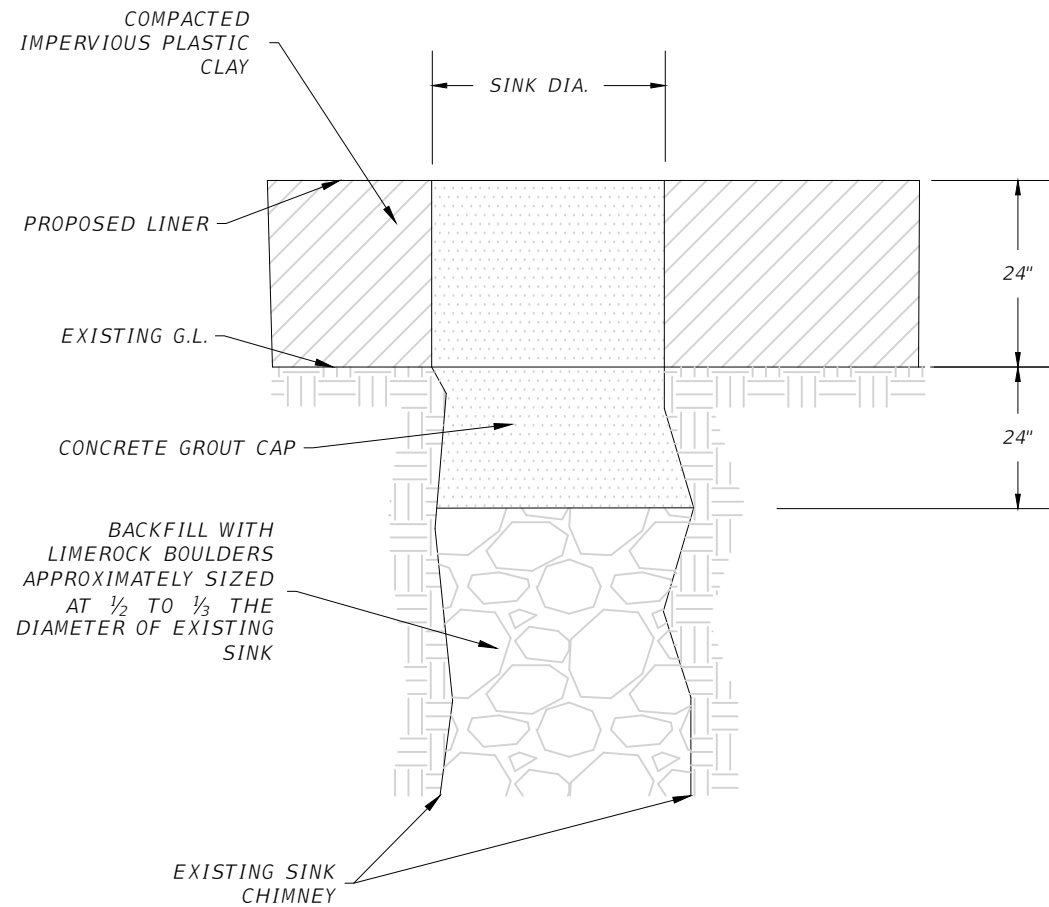
PAYAL PANDYA, P.E., CFM
P.E. LICENSE NUMBER 73210
STATE OF FLORIDA, DATE: _____
VALID ONLY WITH EMBOSSED SEAL.

PIPE TABLE								
PIPE	STRT #	END #	SIDE	DESCRIPTION	SIZE INCHES	LENGTH	START ELEV.	END ELEV.
P-1	I-1	I-2	7.22 Rt.	18" SD PIPE CULVERT, OPT MATERIAL, ROUND	18.0"	48.01'	64.50	63.70
P-2	I-2	I-4	-39.26 Lt.	18" SD PIPE CULVERT, OPT MATERIAL, ROUND	18.0"	92.00'	63.70	63.50
P-3	I-3	I-4	39.64 Rt.	18" SD PIPE CULVERT, OPT MATERIAL, ROUND	18.0"	51.09'	64.90	64.70
P-4	I-4	I-6	-10.26 Lt.	24" SD PIPE CULVERT, OPT MATERIAL, ROUND	24.0"	249.43'	63.50	63.30
P-5	I-5	I-6	39.10 Rt.	18" SD PIPE CULVERT, OPT MATERIAL, ROUND	18.0"	49.08'	65.00	64.80
P-6	I-6	I-8	-9.98 Lt.	24" SD PIPE CULVERT, OPT MATERIAL, ROUND	24.0"	144.10'	63.30	63.00
P-8	I-8	I-8a	-40.70 Lt.	24" SD PIPE CULVERT, OPT MATERIAL, ROUND	24.0"	188.82'	63.00	62.60
P-11	I-9	I-10	39.62 Rt.	18" SD PIPE CULVERT, OPT MATERIAL, ROUND	18.0"	79.31'	64.70	64.50
P-12	I-10	I-12	-39.69 Lt.	24" SD PIPE CULVERT, OPT MATERIAL, ROUND	24.0"	242.80'	62.20	61.50
P-16	I-14	I-13	-39.25 Lt.	18" SD PIPE CULVERT, OPT MATERIAL, ROUND	18.0"	116.33'	62.50	62.87
P-18	I-14	I-16	-39.04 Lt.	30" SD PIPE CULVERT, OPT MATERIAL, ROUND	30.0"	141.22'	62.20	62.50
P-21	I-18	I-17	-39.25 Lt.	18" SD PIPE CULVERT, OPT MATERIAL, ROUND	18.0"	78.50'	69.80	70.00
P-20	I-18	I-16	-39.25 Lt.	30" SD PIPE CULVERT, OPT MATERIAL, ROUND	30.0"	221.76'	63.00	62.50
P-22	I-20	I-18	-39.25 Lt.	30" SD PIPE CULVERT, OPT MATERIAL, ROUND	30.0"	268.87'	63.50	63.00
P-23	I-20	I-19	-39.25 Lt.	18" SD PIPE CULVERT, OPT MATERIAL, ROUND	18.0"	78.50'	72.90	73.10
P-7	I-7	I-8	38.00 Rt.	18" SD PIPE CULVERT, OPT MATERIAL, ROUND	18.0"	77.26'	64.80	64.60
P-34	I-32	I-30	-39.68 Lt.	24" SD PIPE CULVERT, OPT MATERIAL, ROUND	24.0"	166.40'	67.00	65.60
P-32	I-30	I-28	-39.60 Lt.	24" SD PIPE CULVERT, OPT MATERIAL, ROUND	24.0"	152.65'	65.60	65.30
P-29	I-26	I-25	-39.45 Lt.	18" SD PIPE CULVERT, OPT MATERIAL, ROUND	18.0"	78.49'	69.40	69.60
P-37	I-34	I-33	-39.83 Lt.	18" SD PIPE CULVERT, OPT MATERIAL, ROUND	18.0"	78.50'	68.00	68.30

PIPE TABLE									
PIPE	STRT #	END #	SIDE	DESCRIPTION	SIZE INCHES	LENGTH	START ELEV.	END ELEV.	
P-35	I-32	I-31	-39.68 Lt.	18" SD PIPE CULVERT, OPT MATERIAL, ROUND	18.0"	78.63'	67.30	67.50	
P-33	I-30	I-29	-39.60 Lt.	18" SD PIPE CULVERT, OPT MATERIAL, ROUND	18.0"	78.50'	66.00	66.20	
P-28	I-26	I-24	-39.56 Lt.	24" SD PIPE CULVERT, OPT MATERIAL, ROUND	24.0"	247.24'	65.00	64.50	
P-26	I-24	I-22	-39.42 Lt.	24" SD PIPE CULVERT, OPT MATERIAL, ROUND	24.0"	266.59'	64.50	64.00	
P-24	I-22	I-20	-39.24 Lt.	24" SD PIPE CULVERT, OPT MATERIAL, ROUND	24.0"	239.85'	64.00	63.50	
P-25	I-22	I-21	-39.24 Lt.	18" SD PIPE CULVERT, OPT MATERIAL, ROUND	18.0"	78.49'	75.20	75.40	
P-27	I-24	I-23	-39.42 Lt.	18" SD PIPE CULVERT, OPT MATERIAL, ROUND	18.0"	78.58'	73.20	73.40	
P-19	I-15	I-16	39.33 Rt.	18" SD PIPE CULVERT, OPT MATERIAL, ROUND	18.0"	78.67'	66.40	66.00	
P-14	I-12	I-11	-39.24 Lt.	30" SD PIPE CULVERT, OPT MATERIAL, ROUND	30.0"	78.63'	61.50	61.50	
P-15	I-11	S-1	39.39 Rt.	30" SD PIPE CULVERT, OPT MATERIAL, ROUND	30.0"	45.48'	61.50	61.30	
P-13	I-12	S-2	-39.24 Lt.	30" SD PIPE CULVERT, OPT MATERIAL, ROUND	30.0"	66.23'	61.50	61.30	
P-17	I-14	S-3	-39.04 Lt.	30" SD PIPE CULVERT, OPT MATERIAL, ROUND	30.0"	69.53'	62.20	62.00	
P-36	I-34	I-32	-39.83 Lt.	24" SD PIPE CULVERT, OPT MATERIAL, ROUND	24.0"	314.98'	67.80	67.00	
P-30	I-28	I-26	-39.61 Lt.	24" SD PIPE CULVERT, OPT MATERIAL, ROUND	24.0"	151.30'	65.30	65.00	
P-31	I-27	I-28	39.06 Rt.	18" SD PIPE CULVERT, OPT MATERIAL, ROUND	18.0"	78.67'	67.30	67.00	
P-10	I-8a	I-10	-39.34 Lt.	24" SD PIPE CULVERT, OPT MATERIAL, ROUND	24.0"	186.73'	62.60	62.20	
P-9	I-7a	I-8a	39.33 Rt.	18" SD PIPE CULVERT, OPT MATERIAL, ROUND	18.0"	78.67'	63.90	63.70	


REVISIONS				PREPARED BY	NW 44th AVENUE EXTENSION	SHEET NO.
DATE	DESCRIPTION	DATE	DESCRIPTION			
---	---				PIPE SCHEDULE	32

PAYAL PANDYA, P.E., CFM
P.E. LICENSE NUMBER 73210
STATE OF FLORIDA, DATE: _____
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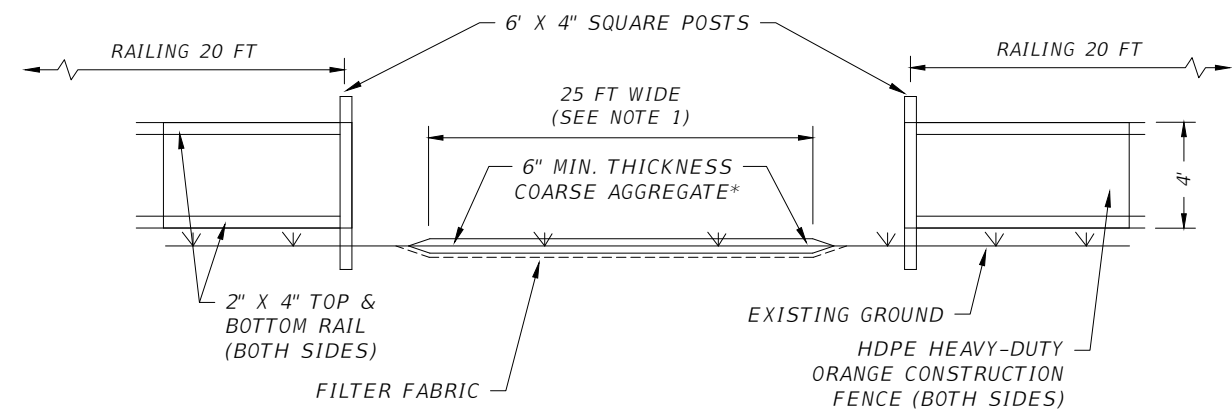


SOLUTION CHANNEL PLAN AT DRA

IF A SOLUTION CHANNEL IS EVIDENT AFTER EXCAVATING TO SLIGHTLY MORE THAN THREE FEET BELOW PROPOSED POND BOTTOM, ALLOW FOR PLASTIC CLAY PLACEMENT PLUS THREE FEET OF A-3 SAND AND FILL SOLUTION CHANNEL IN ACCORDANCE WITH TYPICAL SINK CHIMNEY REPAIR DETAIL.

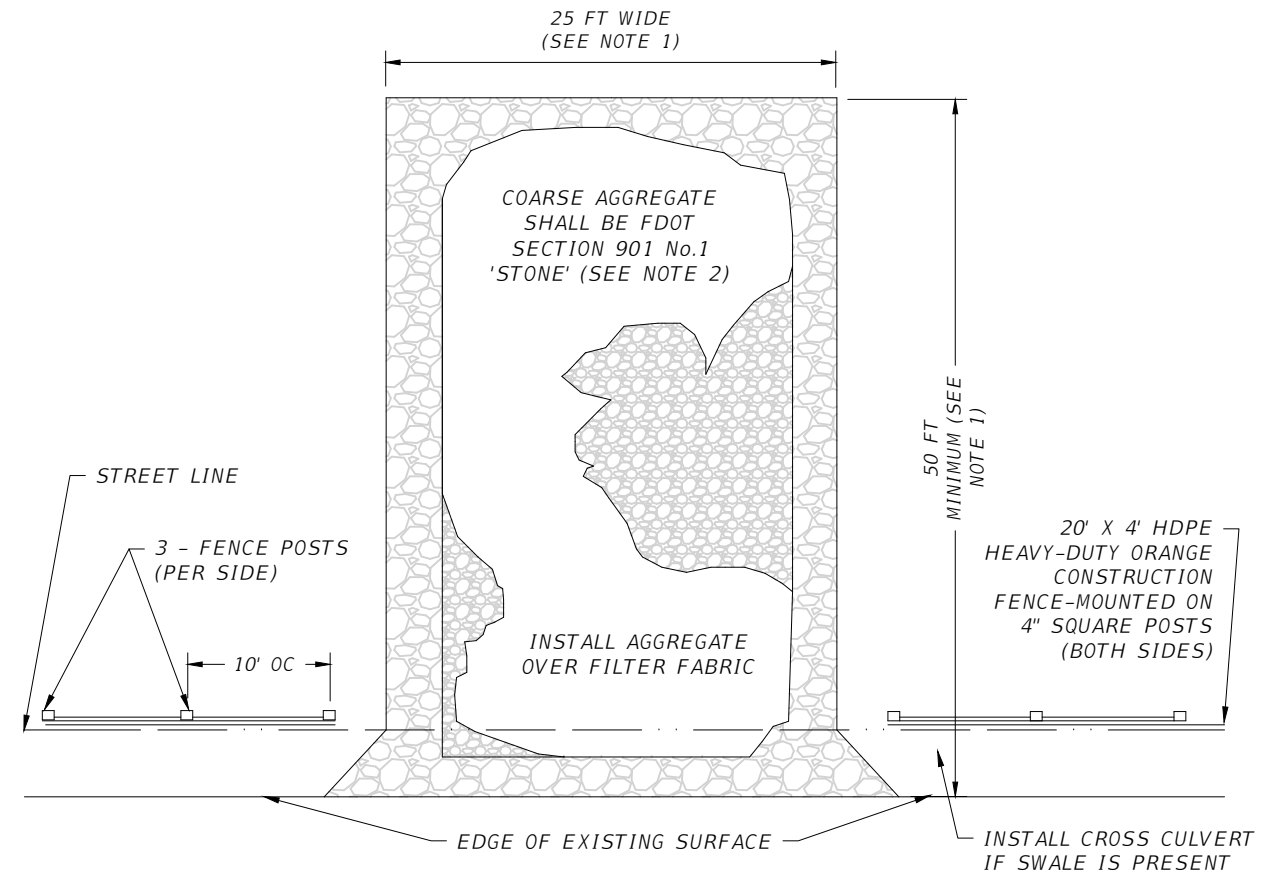

PLAN



ELEVATION

NOTES:

1. CITY MAY REDUCE THIS DIMENSION IF CONDITIONS PERMIT AND IF REQUESTED BY THE CONTRACTOR.
2. CITY MAY ALLOW NO. 57 STONE, OR CLEAN, WASHED RECYCLED CONCRETE MEETING THE MINIMUM SIZE OF NO. 1 STONE AS AN ALTERNATE IF REQUESTED BY THE CONTRACTOR.



CITY ENGINEER'S OFFICE
1805 NE 30TH AVE, BLDG #600
OCALA, FLORIDA 34470

CITY OF OCALA
STANDARD DETAILS
FOR CONSTRUCTION

KARST

SINK CHIMNEY REPAIR

SECTION:
STORM

SW-6

REVISION DATE:
DEC 2020

PAYAL PANDYA, P.E., CFM
P.E. LICENSE NUMBER 73210

1805 NE 30TH AVE
OCALA, FL 34470



CITY ENGINEER'S OFFICE
1805 NE 30TH AVE, BLDG #600
OCALA, FLORIDA 34470

CITY OF OCALA
STANDARD DETAILS
FOR CONSTRUCTION

TYPICAL CONSTRUCTION
ENTRANCE TRACKING
PAD

SECTION:
GENERAL

G-22

REVISION DATE:
DEC 2020



REVISIONS			
DATE	DESCRIPTION	DATE	DESCRIPTION

PREPARED BY: **OCALA** CITY ENGINEER'S OFFICE Gary Anson 4/6/2023 6:15:38 PM


NW 44th AVENUE EXTENSION PHASE 2

DRAINAGE DETAILS

SHEET NO. 33

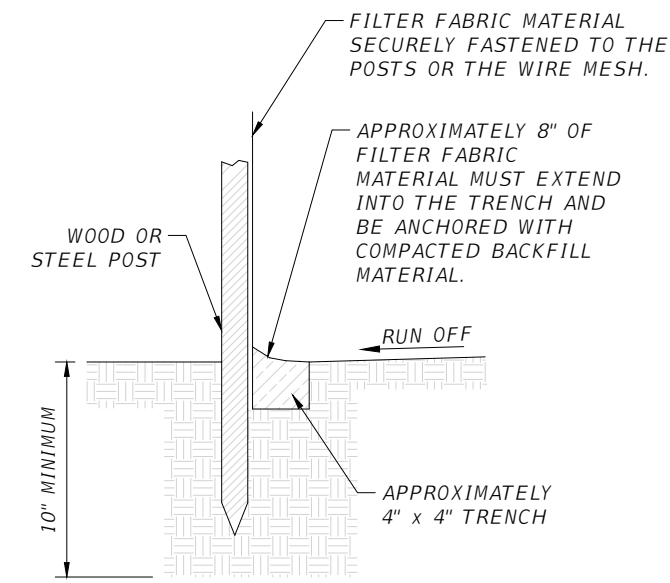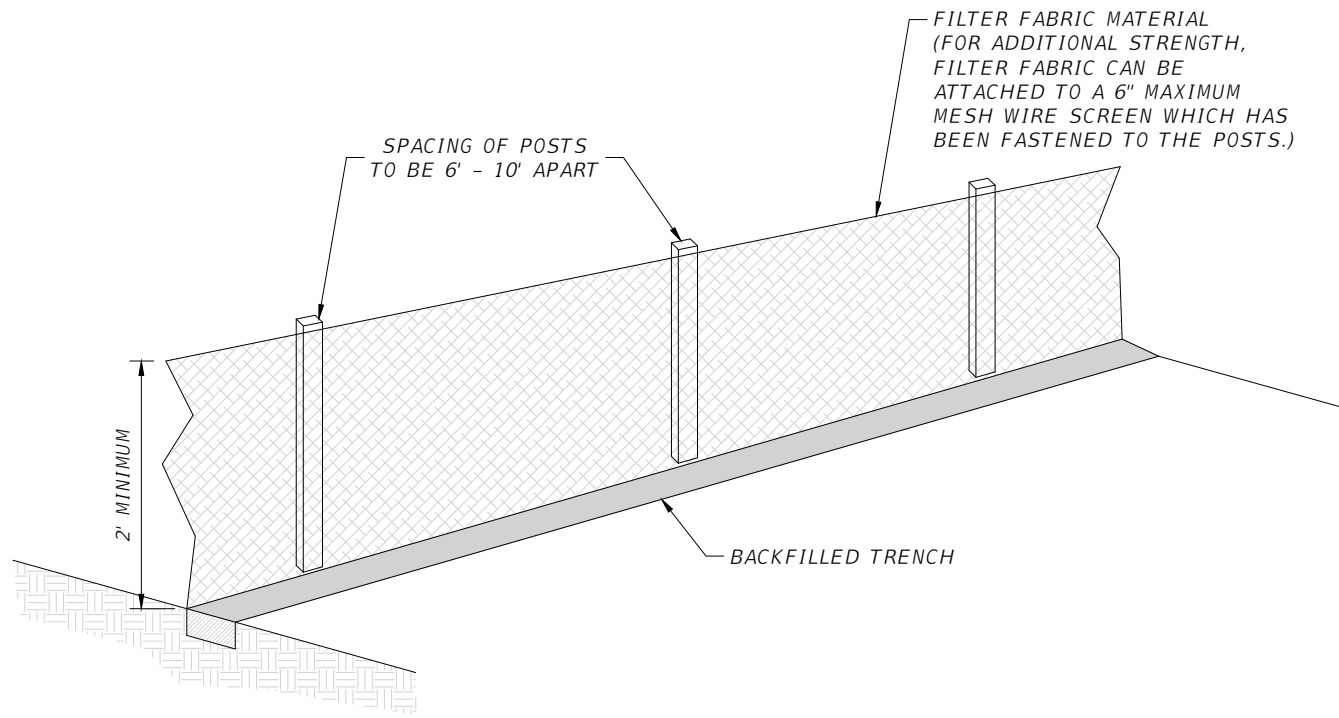

ATTACHING TWO SILT FENCES

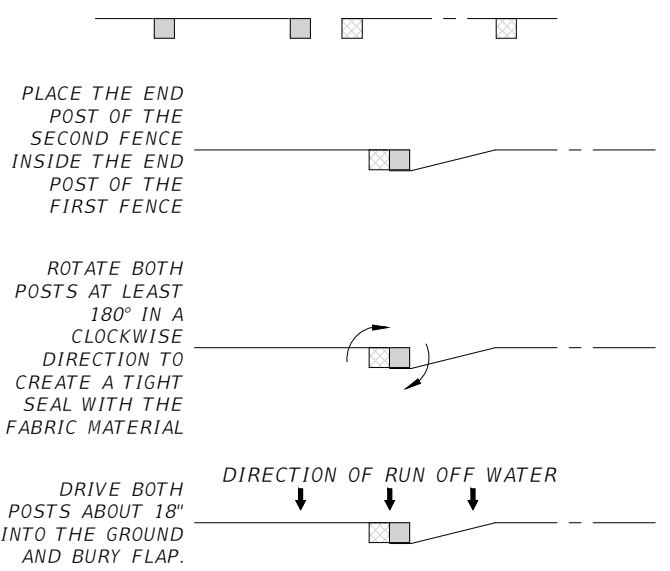


DANDY BAG DETAIL

- SWPPP NOTES:**
1. SOIL TRACKING PREVENTION DEVICE (STPD) AT SITE ENTRANCE FOR CONSTRUCTION TRAFFIC SHALL BE INSTALLED IN ACCORDANCE WITH THE FLORIDA DEPARTMENT OF TRANSPORTATION DESIGN STANDARDS INDEX 106, SHOWN ON THIS SHEET FOR REFERENCE. INSTALL STPD PRIOR TO HEAVY CONSTRUCTION TRAFFIC. STPD TO BE REMOVED JUST PRIOR TO LIMEROCK INSTALLATION.
 2. A PRESITE MEETING IS REQUIRED PRIOR TO CONSTRUCTION.


DANDY BAG II
 Installation and Maintenance Guidelines

INSTALLATION: REMOVE THE GRATE FROM CATCH BASIN. IF USING OPTIONAL OIL ABSORBENTS: PLACE ABSORBENT PILLOW IN UNIT. STAND THE GRATE ON END. MOVE THE TOP LIFTING STRAPS OUT OF THE WAY AND PLACE THE GRATE INTO THE DANDY BAG II SO THAT THE GRATE IS BELOW THE TOP STRAPS AND ABOVE THE LOWER STRAPS. HOLDING THE LIFTING DEVICES, INSERT THE GRATE INTO THE INLET.

MAINTENANCE: REMOVE ALL ACCUMULATED SEDIMENT AND DEBRIS FROM VICINITY OF UNIT AFTER EACH STORM EVENT. AFTER EACH STORM EVENT AND AT REGULAR INTERVALS, LOOK INTO THE DANDY BAG II. IF THE CONTAINMENT AREA IS MORE THAN 1/3 FULL OF SEDIMENT, THE UNIT MUST BE EMPTIED. TO EMPTY UNIT, LIFT THE UNIT OUT OF THE INLET USING THE LIFTING STRAPS AND REMOVE THE GRATE. IF USING OPTIONAL OIL ABSORBENTS, REPLACE ABSORBENT WHEN NEAR SATURATION.

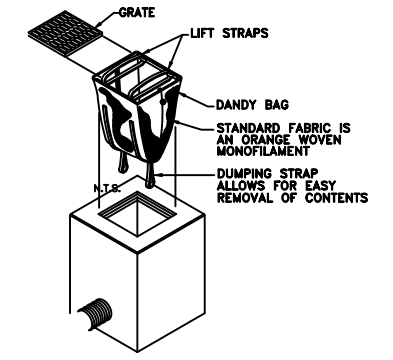

INLET PROTECTION SOCK DETAIL

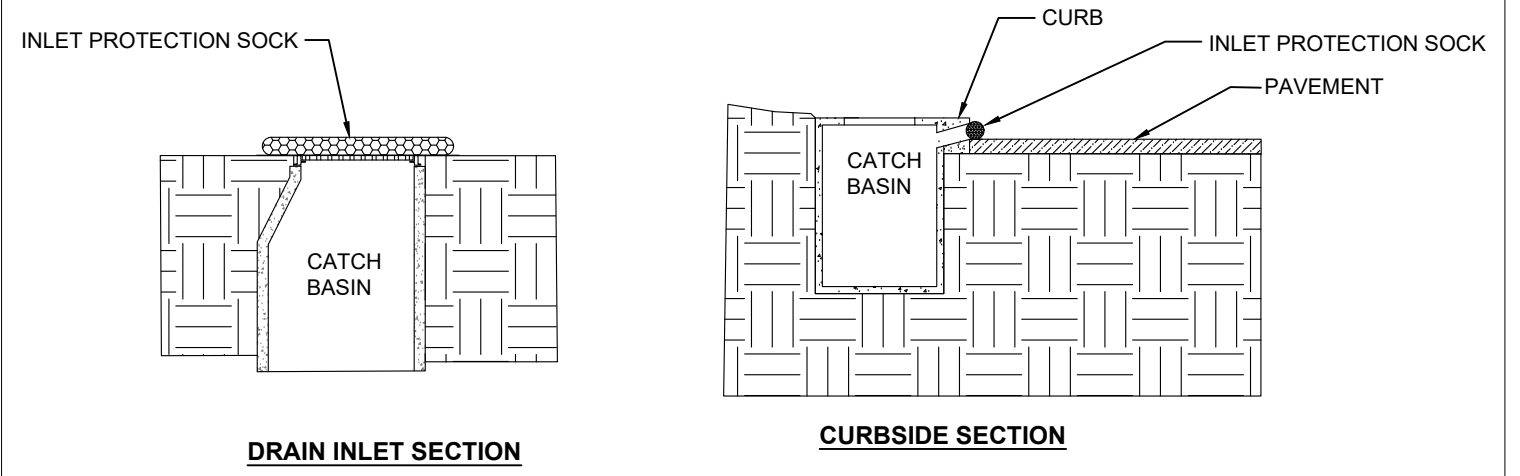

CITY OF OCALA
 STANDARD DETAILS
 FOR CONSTRUCTION

TYPICAL SILT FENCE

SECTION:
 GENERAL
G-25
 REVISION DATE:
 DEC 2020


PAYAL PANDYA, P.E., CFM
 P.E. LICENSE NUMBER 73210
 1805 NE 30TH AVE
 OCALA, FL 34470




PREPARED BY
 NW 44th AVENUE EXTENSION PHASE 2
DRAINAGE DETAILS

SHEET NO.
 33A


REVISIONS			
DATE	DESCRIPTION	DATE	DESCRIPTION

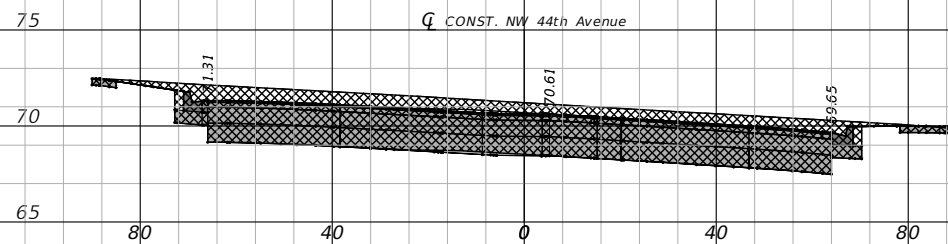


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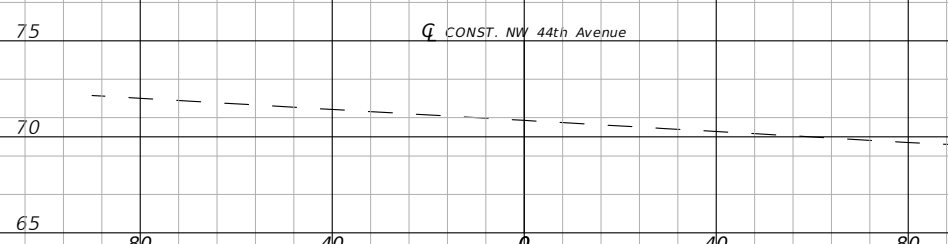
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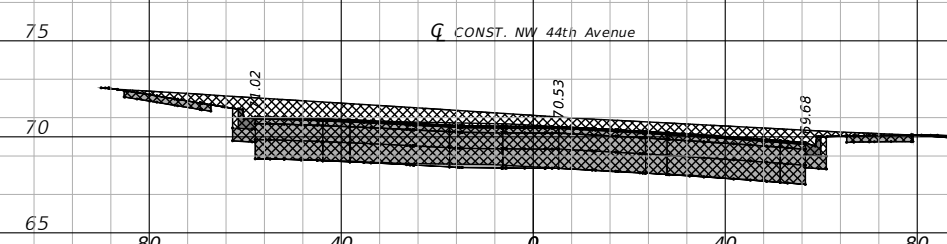
200+32.97
(BEGIN NEW PAVEMENT EARTHWORK)

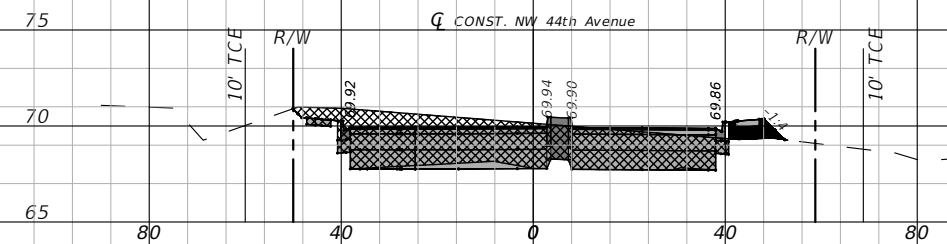

200+50.00

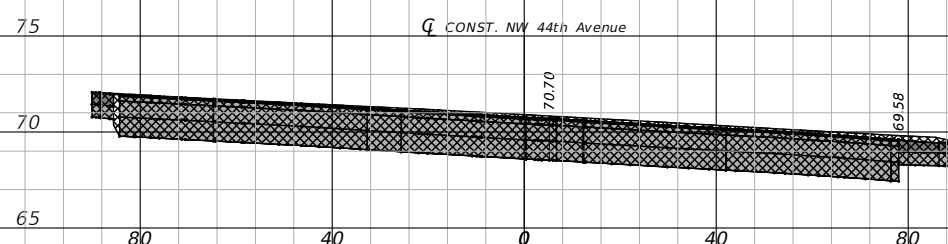

200+30.00

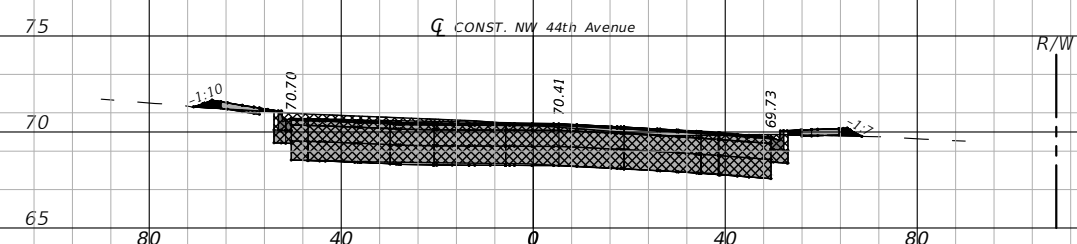

200+43.02

1" = 40' Horizontal
1" = 10' Vertical

REVISIONS			
DATE	DESCRIPTION	DATE	DESCRIPTION
11/30/22	ADDED TCE REFERENCES		

NOEL JOHN COOPER, P.E.
P.E. LICENSE NUMBER 69534
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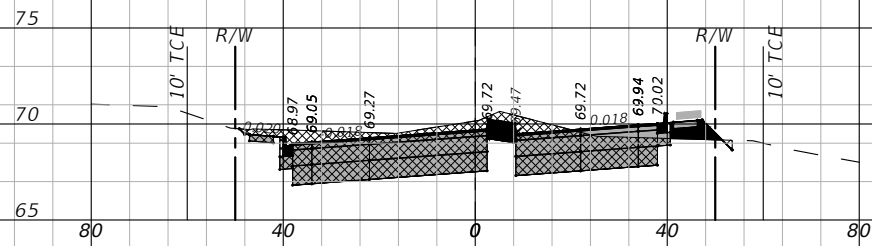
Gary Anson

NW 44th AVENUE EXTENSION PHASE 2


ROADWAY CROSS-SECTIONS - (1)

SHEET NO.
34


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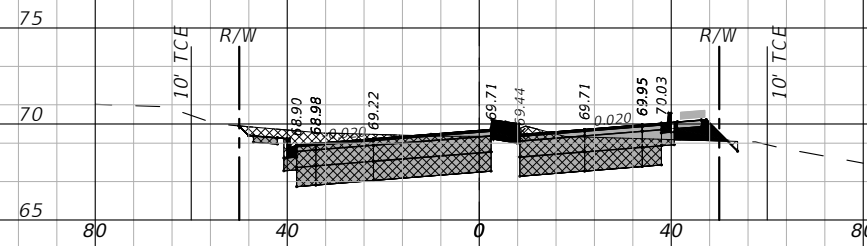
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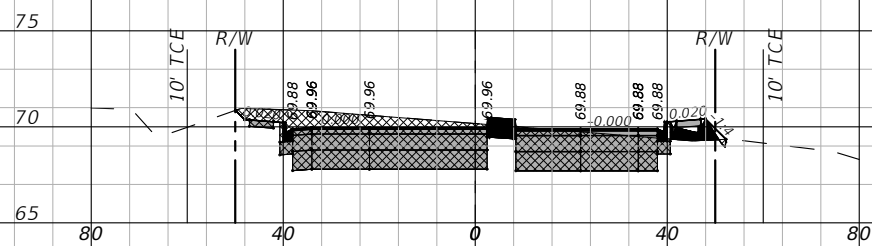
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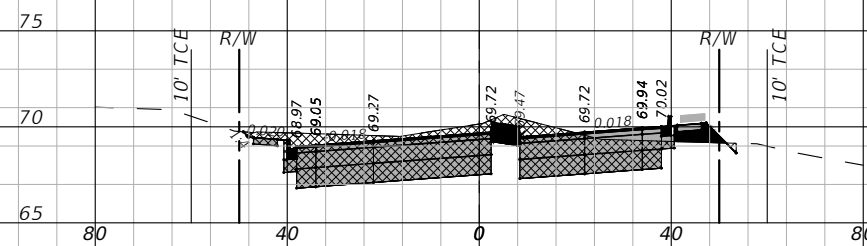
201+00.00



201+55.80

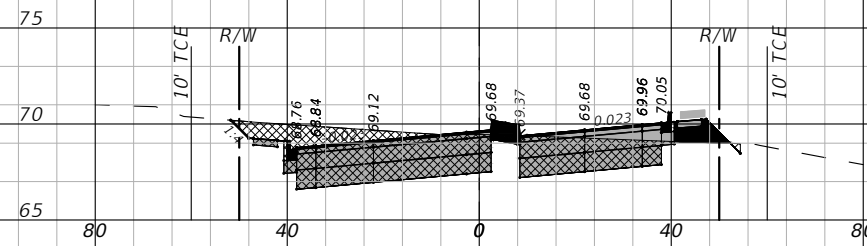

200+83.76

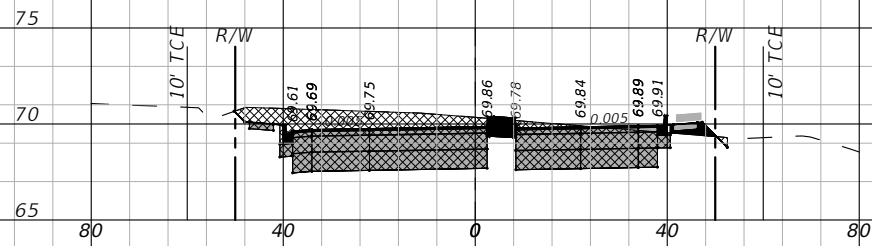

201+50.00

1" = 40' Horizontal
1" = 10' Vertical

REVISIONS			
DATE	DESCRIPTION	DATE	DESCRIPTION
11/30/22	ADDED TCE REFERENCES		

NOEL JOHN COOPER, P.E.
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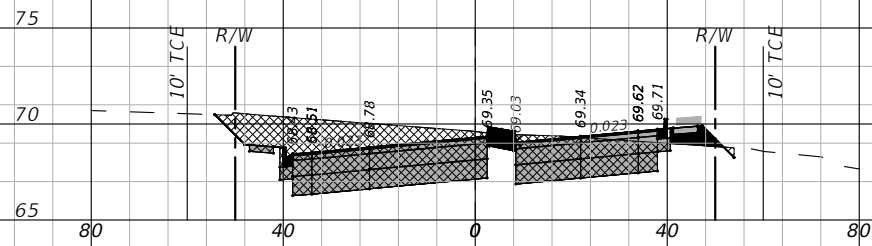
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NW 44th AVENUE EXTENSION PHASE 2


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SHEET NO.
35


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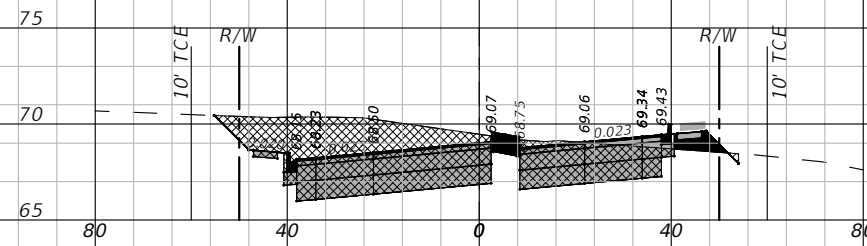
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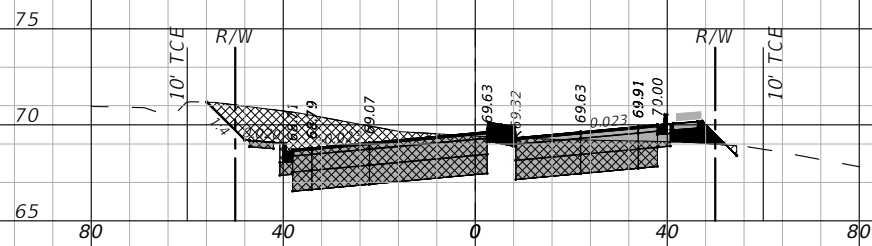
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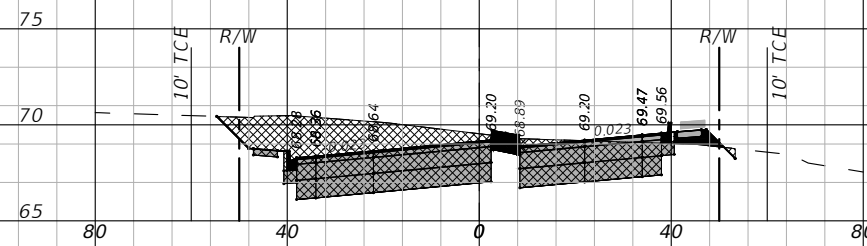
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202+73.59



201+75.00

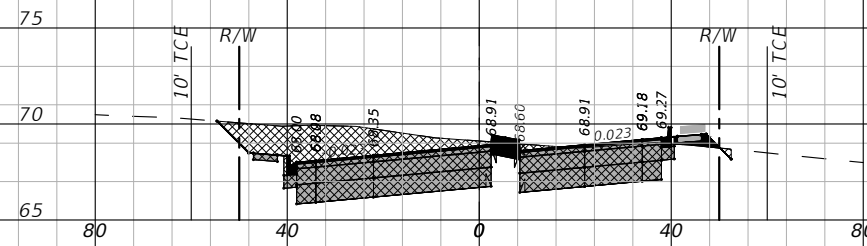

202+50.00

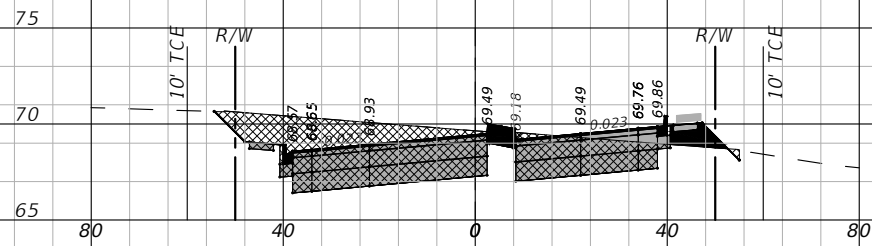1" = 40' Horizontal
1" = 10' Vertical

REVISIONS			
DATE	DESCRIPTION	DATE	DESCRIPTION
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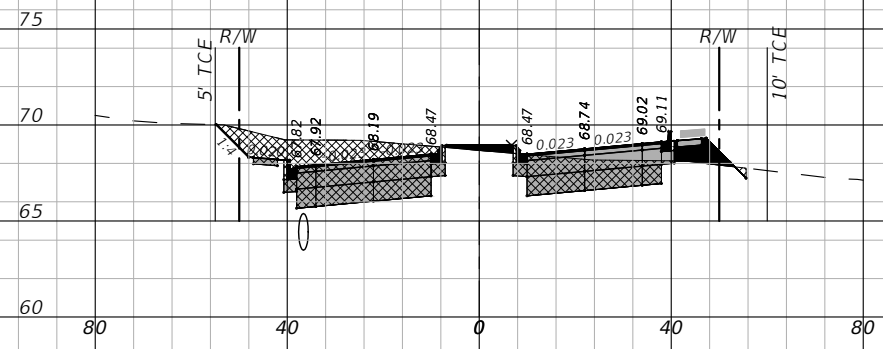
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NW 44th AVENUE EXTENSION PHASE 2


ROADWAY CROSS-SECTIONS - (3)

SHEET NO.
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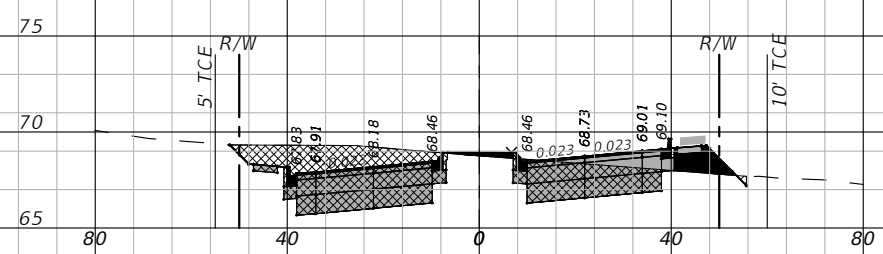
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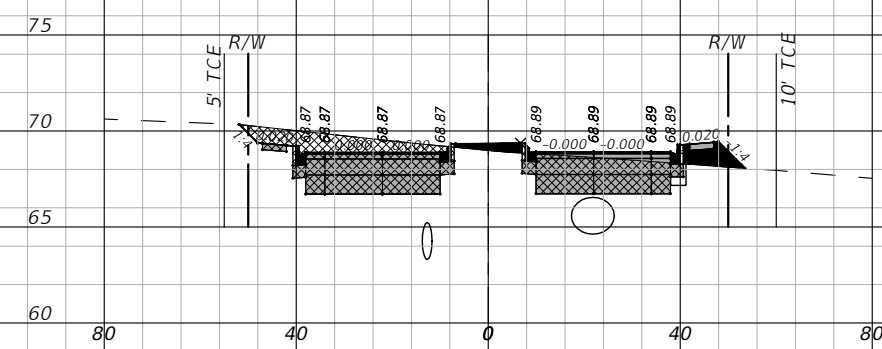
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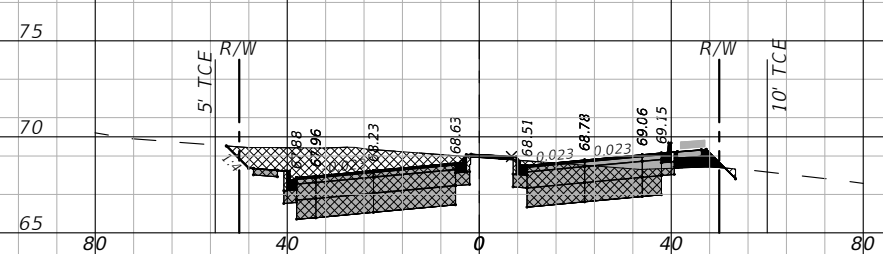
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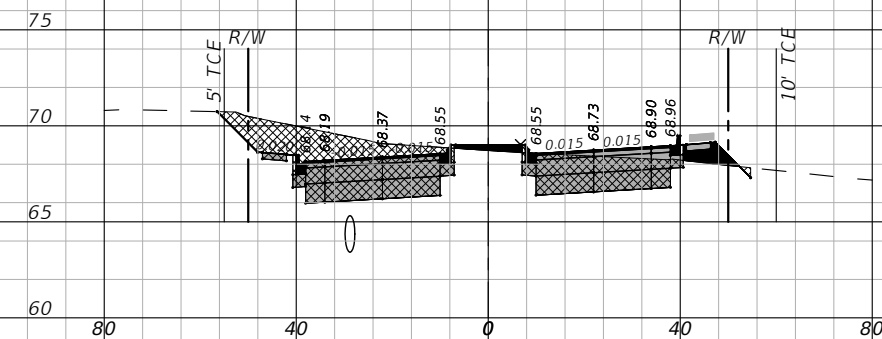
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204+43.58



203+25.00

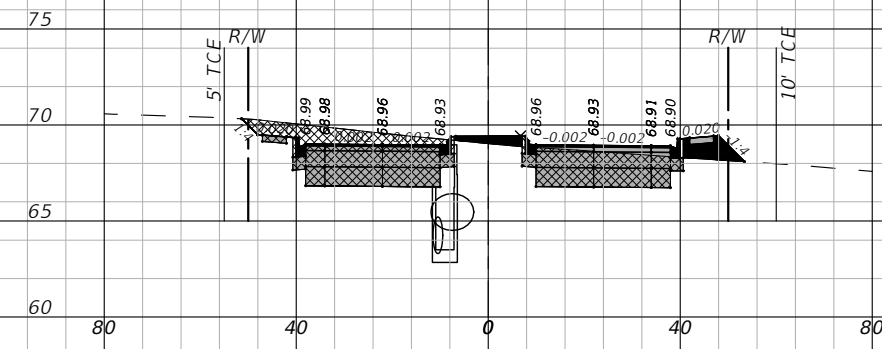

203+97.19

1" = 40' Horizontal
1" = 10' Vertical

REVISIONS			
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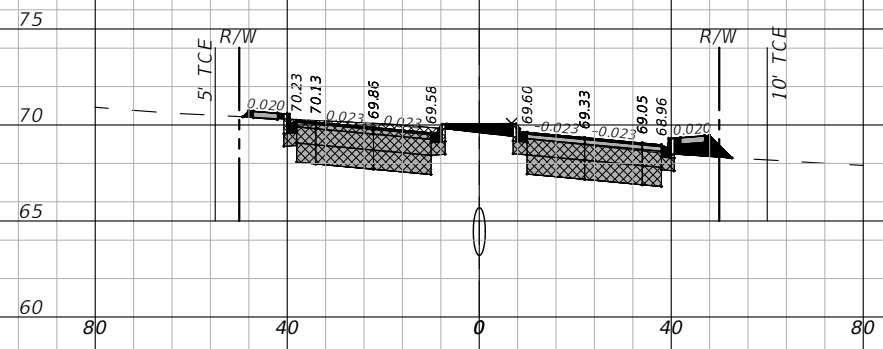
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NW 44th AVENUE EXTENSION PHASE 2


ROADWAY CROSS-SECTIONS - (4)

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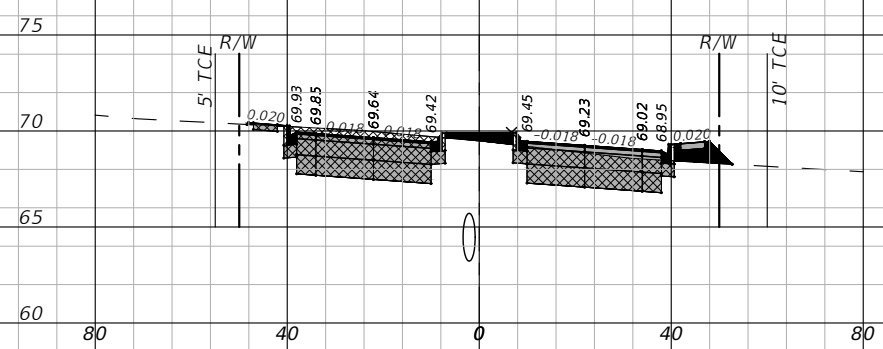
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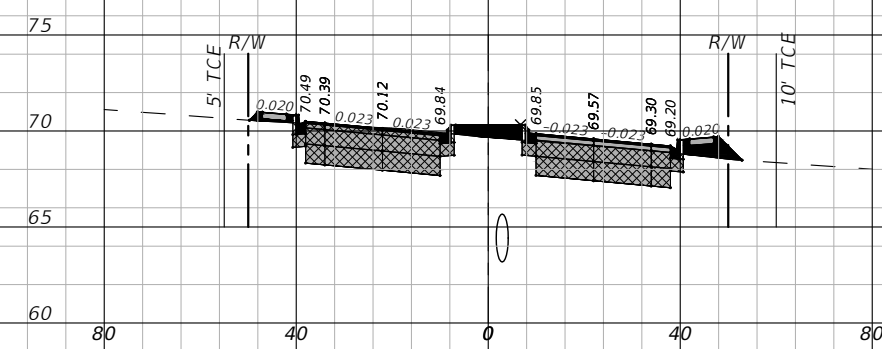
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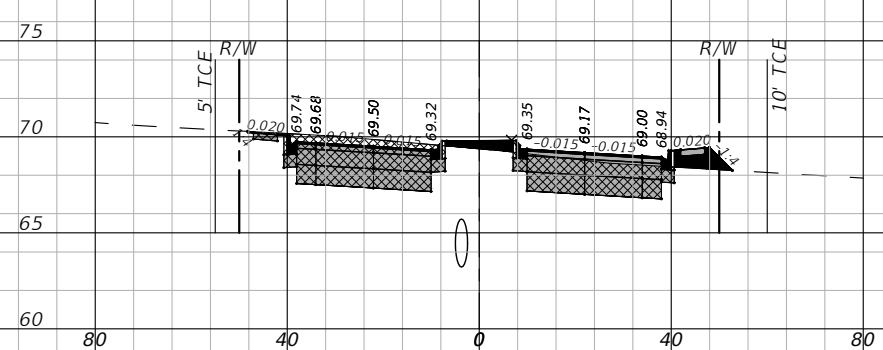
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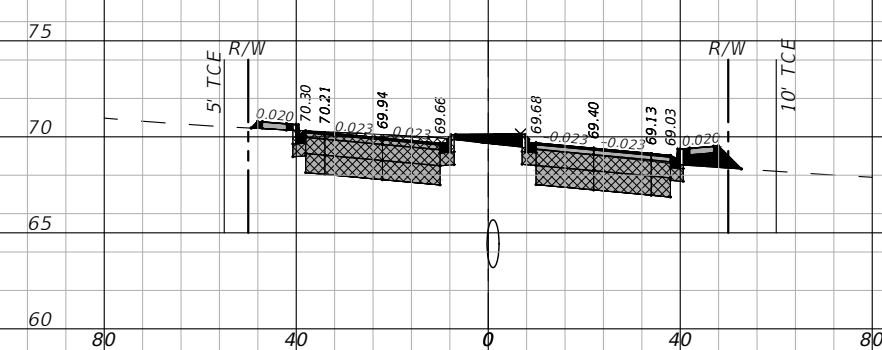
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205+25.00

1" = 40' Horizontal
1" = 10' Vertical

REVISIONS			
DATE	DESCRIPTION	DATE	DESCRIPTION
11/30/22	ADDED TCE REFERENCES		

NOEL JOHN COOPER, P.E.
P.E. LICENSE NUMBER 69534
STATE OF FLORIDA, DATE: _____
VALID ONLY WITH EMBOSSED SEAL.

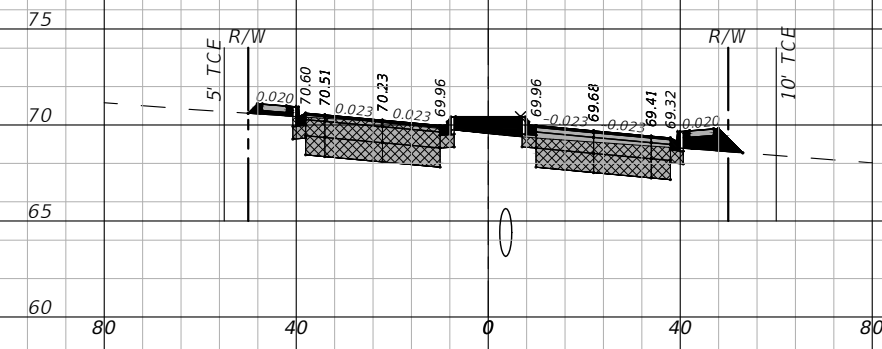PREPARED BY


Gary Anson

NW 44th AVENUE EXTENSION PHASE 2


ROADWAY CROSS-SECTIONS - (5)

SHEET NO.
38


THE OFFICIAL RECORD OF THIS SHEET IS THE ELECTRONIC FILE DIGITALLY SIGNED AND SEALED UNDER RULE 61G15-23.004, F.A.C.

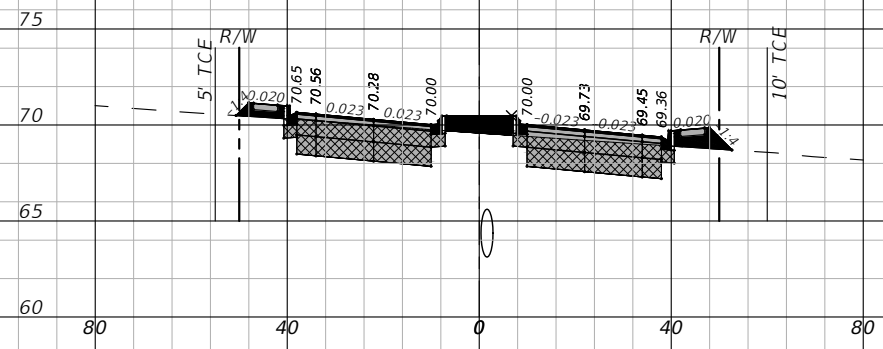


206+25.00

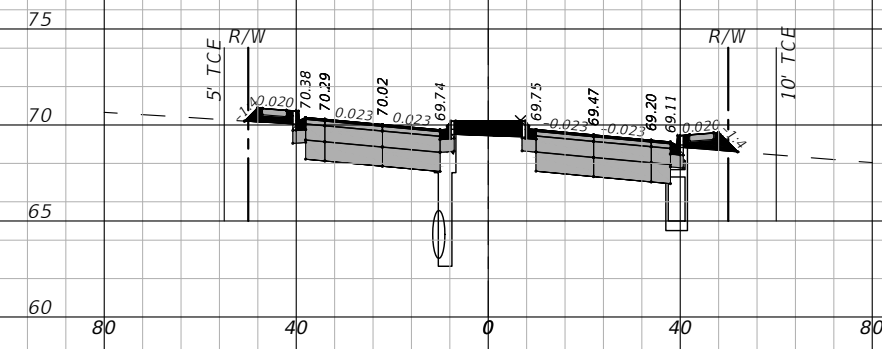


207+00.00

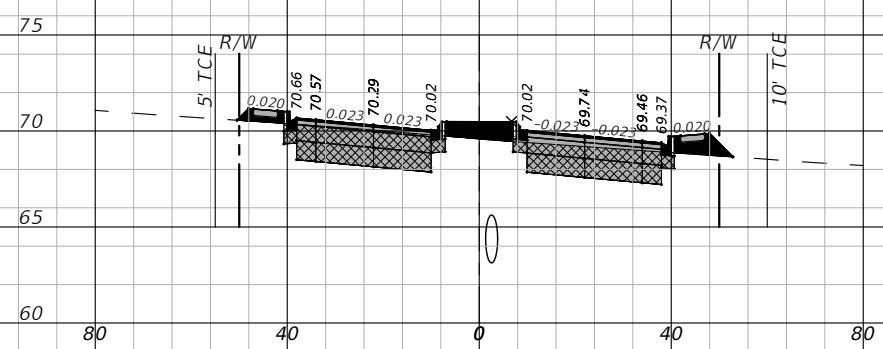


206+12.36

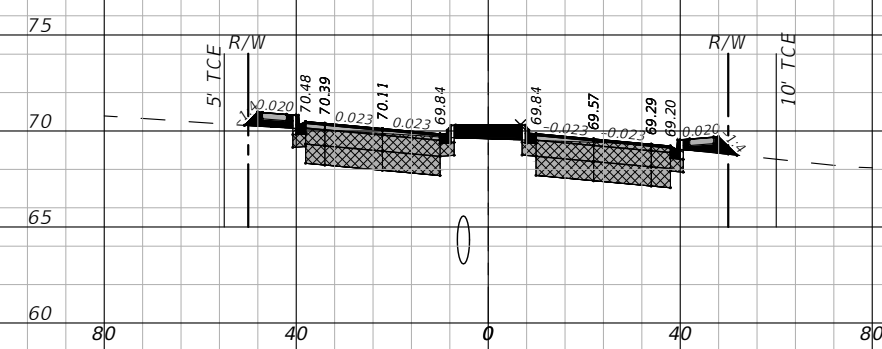

206+75.00

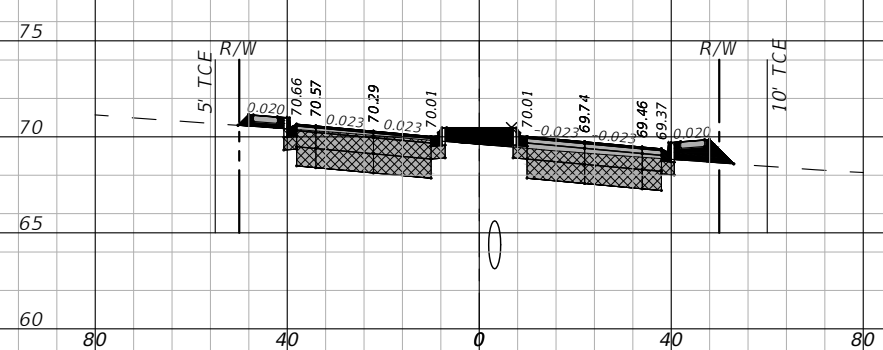

206+00.00

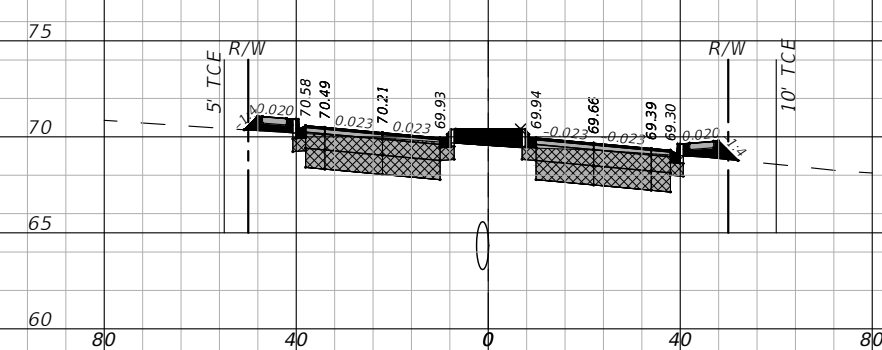

206+50.00

1" = 40' Horizontal
1" = 10' Vertical

REVISIONS			
DATE	DESCRIPTION	DATE	DESCRIPTION
11/30/22	ADDED TCE REFERENCES		

NOEL JOHN COOPER, P.E.
P.E. LICENSE NUMBER 69534
STATE OF FLORIDA, DATE: _____
VALID ONLY WITH EMBOSSED SEAL.

PREPARED BY







Gary Anson

NW 44th AVENUE EXTENSION PHASE 2

ROADWAY CROSS-SECTIONS - (6)

SHEET NO.
39

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1" = 40' Horizontal
1" = 10' Vertical

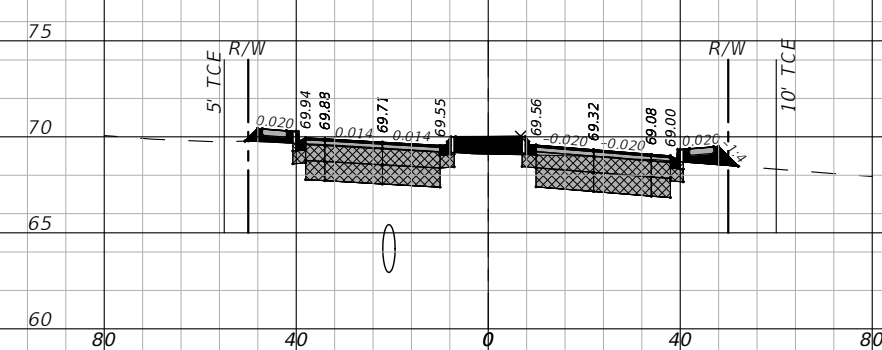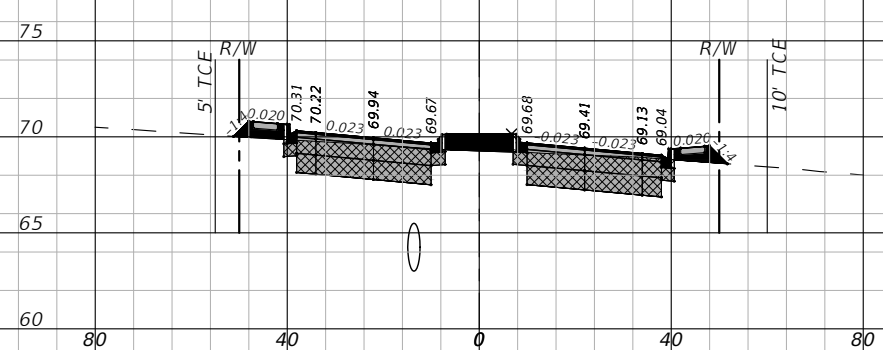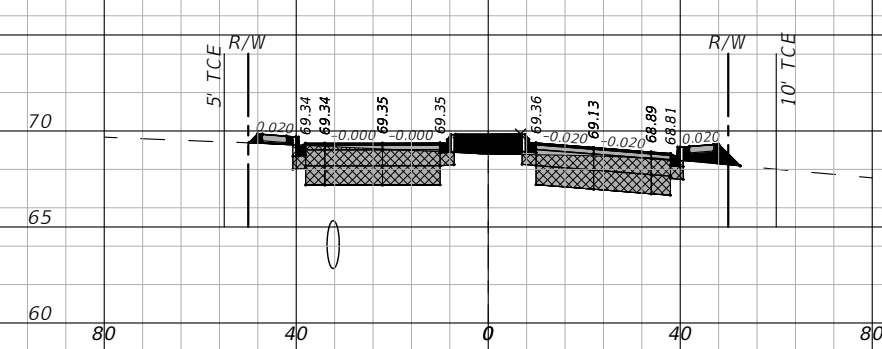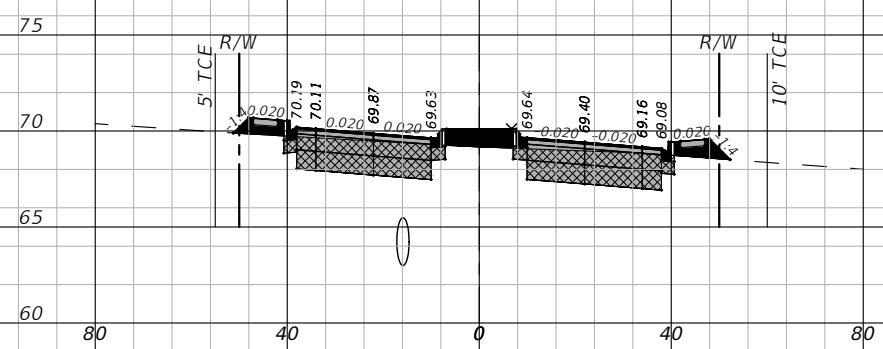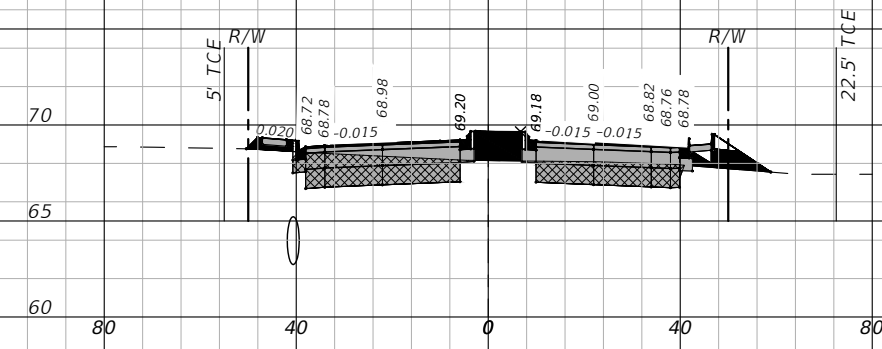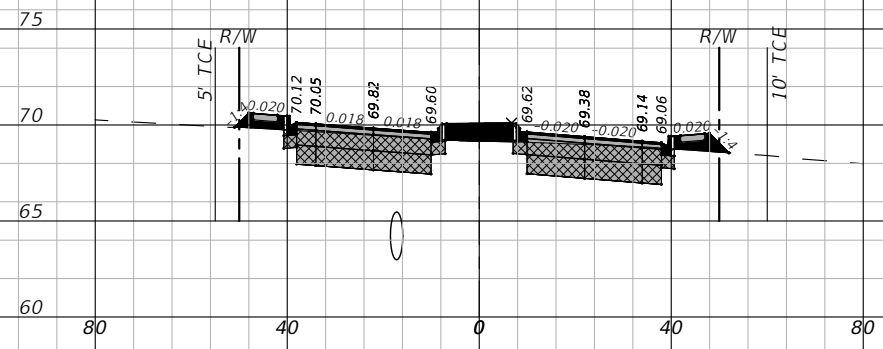REVISIONS			
DATE	DESCRIPTION	DATE	DESCRIPTION
11/30/22	ADDED TCE REFERENCES & REVISED SLOPES		

NOEL JOHN COOPER, P.E.
P.E. LICENSE NUMBER 69534
STATE OF FLORIDA, DATE: _____
VALID ONLY WITH EMBOSSED SEAL.

PREPARED BY


Gary Anson

NW 44th AVENUE EXTENSION PHASE 2


ROADWAY CROSS-SECTIONS - (7)

SHEET NO.
40


THE OFFICIAL RECORD OF THIS SHEET IS THE ELECTRONIC FILE DIGITALLY SIGNED AND SEALED UNDER RULE 61G15-23.004, F.A.C.

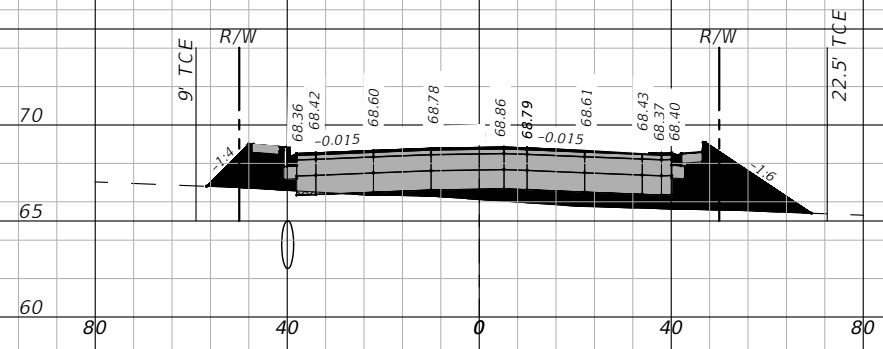


209+50.00

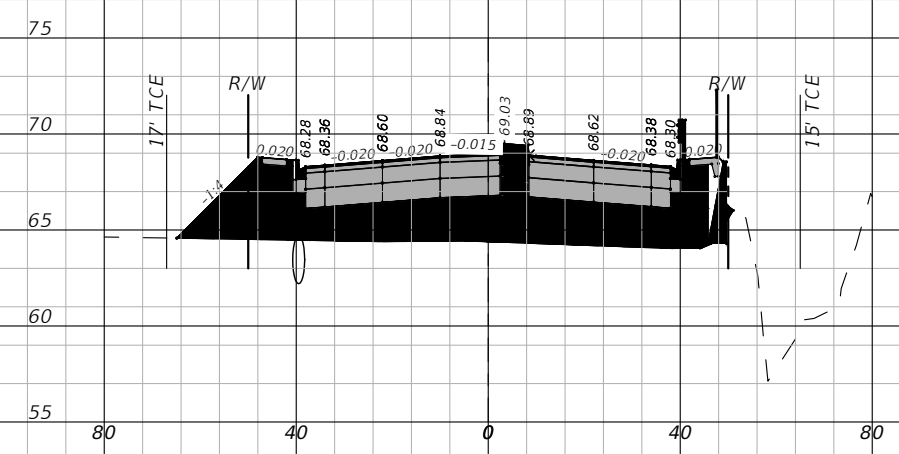


211+00.00

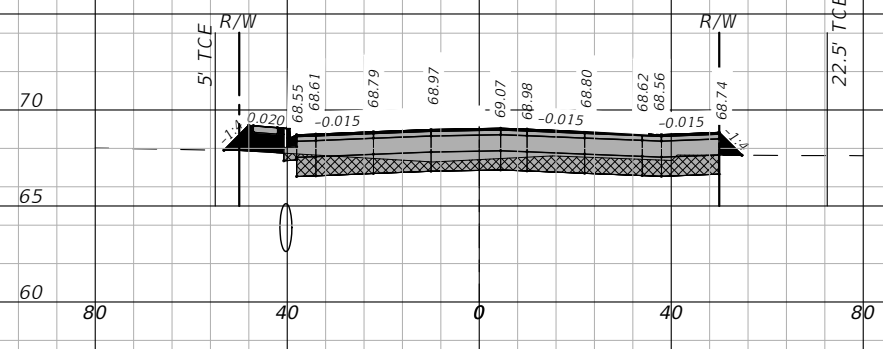


209+00.00

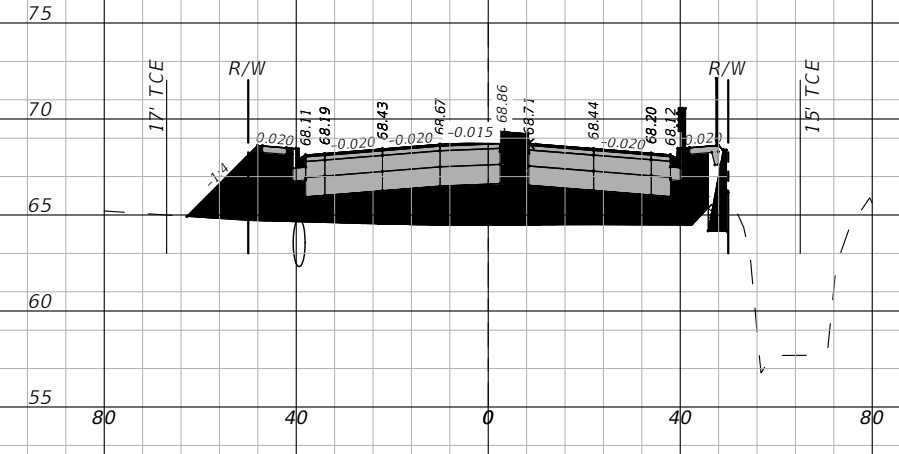

210+50.00

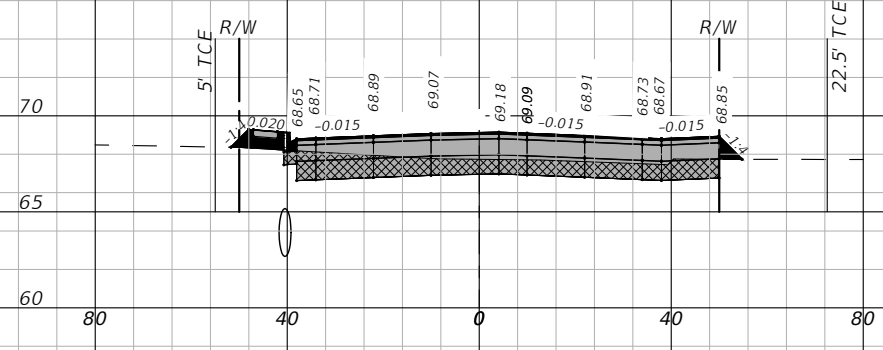

208+73.04

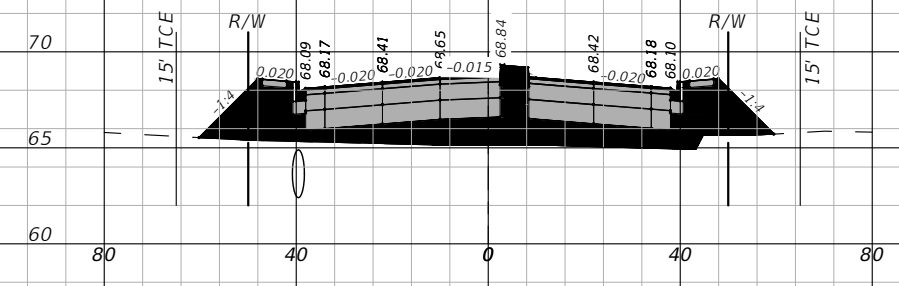

210+00.00

1" = 40' Horizontal
1" = 10' Vertical

REVISIONS			
DATE	DESCRIPTION	DATE	DESCRIPTION
11/30/22	ADDED TCE REFERENCES MODIFIED CROSS SLOPE		

NOEL JOHN COOPER, P.E.
P.E. LICENSE NUMBER 69534
STATE OF FLORIDA, DATE: _____
VALID ONLY WITH EMBOSSED SEAL.

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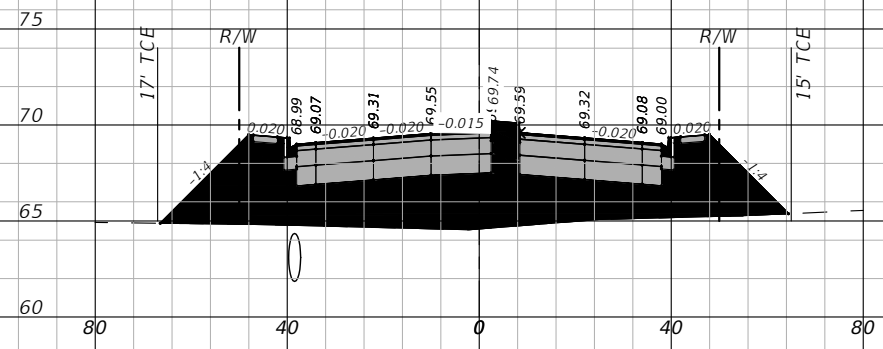
Gary Anson

NW 44th AVENUE EXTENSION PHASE 2


ROADWAY CROSS-SECTIONS - (8)

SHEET NO.
41


THE OFFICIAL RECORD OF THIS SHEET IS THE ELECTRONIC FILE - DIGITALLY SIGNED AND SEALED - UNDER RULE 61G15-23.004, F.A.C.




212+50.00

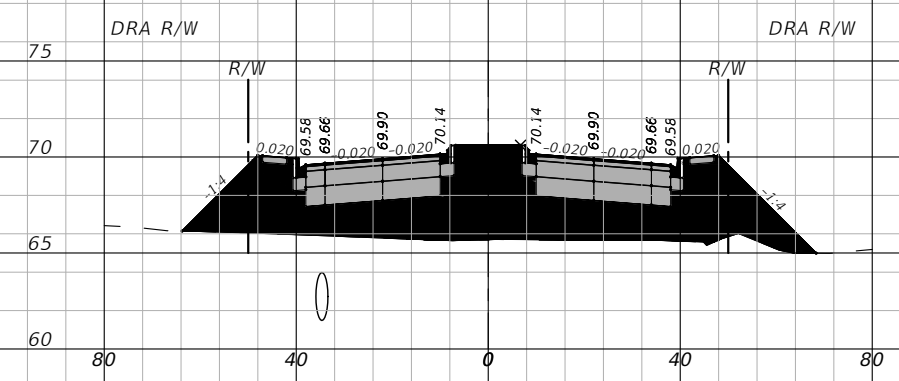


213+75.00

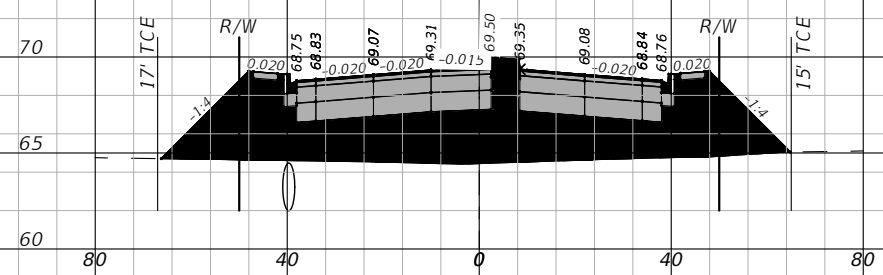


212+00.00

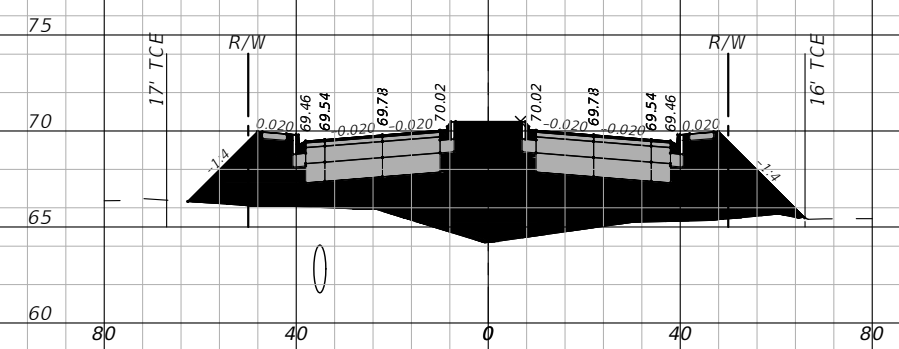

213+49.21

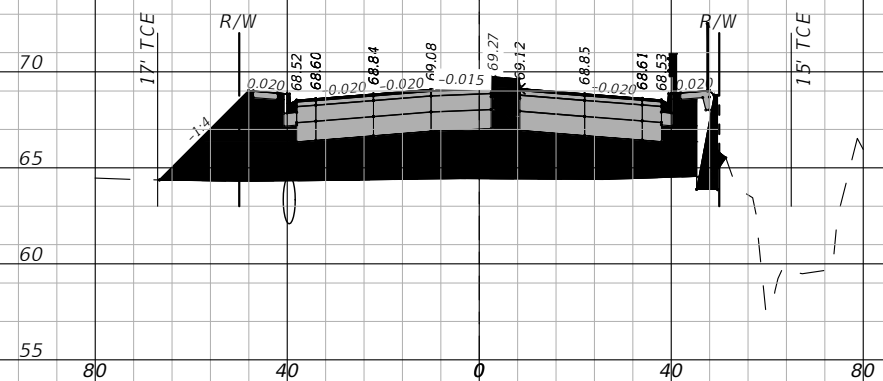

211+50.00

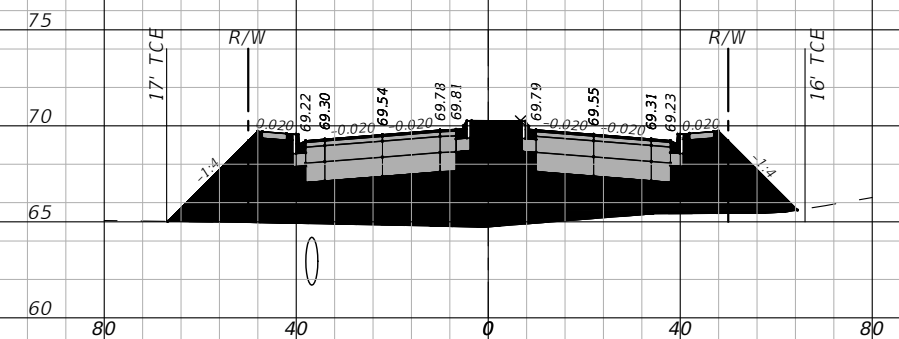

213+00.00

1" = 40' Horizontal
1" = 10' Vertical

REVISIONS			
DATE	DESCRIPTION	DATE	DESCRIPTION
11/30/22	ADDED TCE REFERENCES MODIFIED CROSS SLOPE		
1/23/23	REVISED TCE REFERENCES NEAR DRA		

NOEL JOHN COOPER, P.E.
P.E. LICENSE NUMBER 69534
STATE OF FLORIDA, DATE: _____
VALID ONLY WITH EMBOSSED SEAL.

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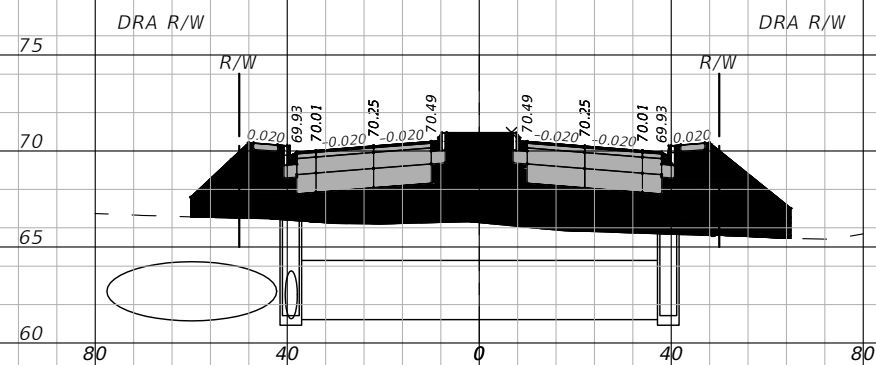
Gary Anson

NW 44th AVENUE EXTENSION PHASE 2


ROADWAY CROSS-SECTIONS - (9)

SHEET NO.
42


THE OFFICIAL RECORD OF THIS SHEET IS THE ELECTRONIC FILE DIGITALLY SIGNED AND SEALED UNDER RULE 61G15-23.004, F.A.C.




214+50.00

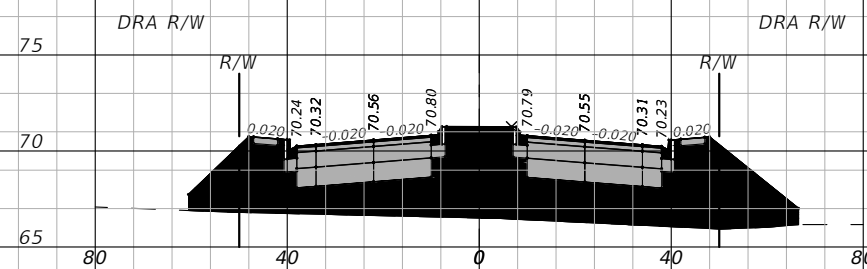


215+15.84

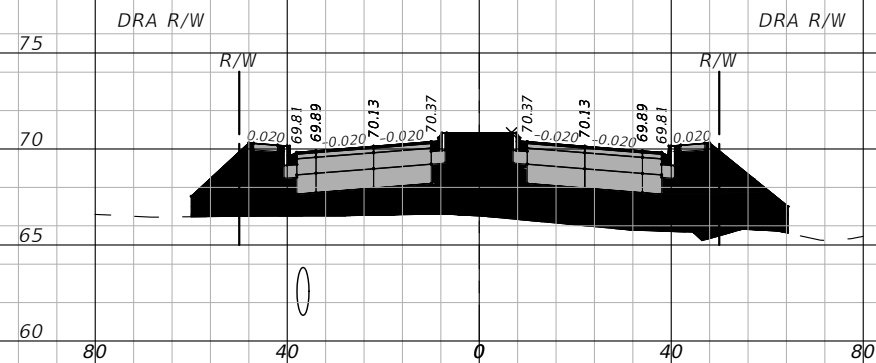


214+25.00

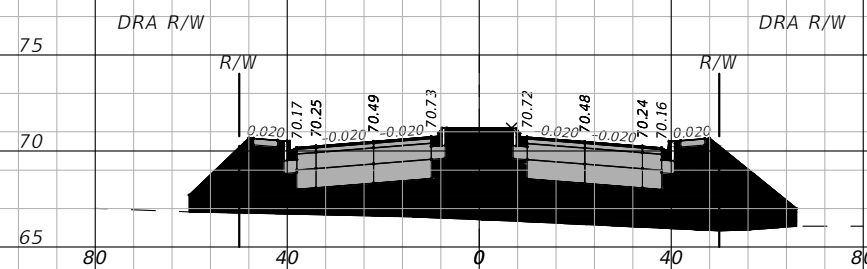

215+00.00

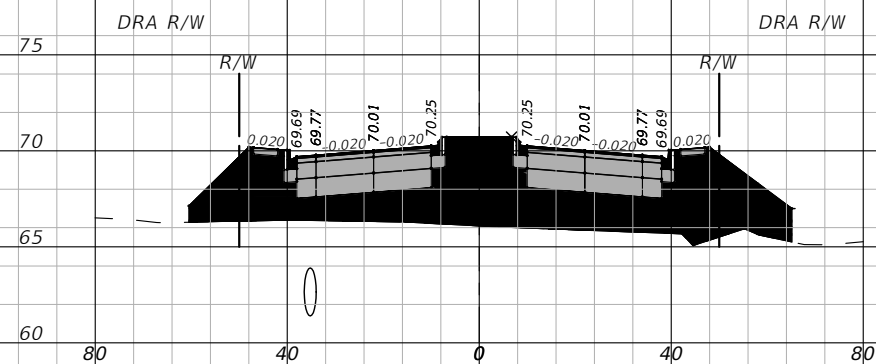

214+00.00

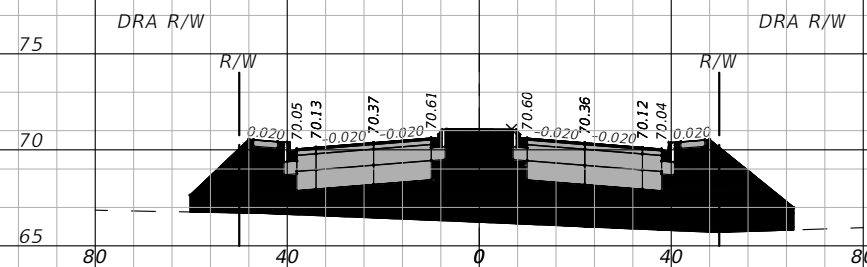

214+75.00

1" = 40' Horizontal
1" = 10' Vertical

REVISIONS	
DATE	DESCRIPTION
11/30/22	ADDED TCE REFERENCES
1/23/23	REVISED TCE REFERENCES NEAR DRA

NOEL JOHN COOPER, P.E.
P.E. LICENSE NUMBER 69534
STATE OF FLORIDA, DATE: _____
VALID ONLY WITH EMBOSSED SEAL.

PREPARED BY


Gary Anson

NW 44th AVENUE EXTENSION PHASE 2


ROADWAY CROSS-SECTIONS - (10)

SHEET NO.
43


THE OFFICIAL RECORD OF THIS SHEET IS THE ELECTRONIC FILE DIGITALLY SIGNED AND SEALED UNDER RULE 61G15-23.004, F.A.C.

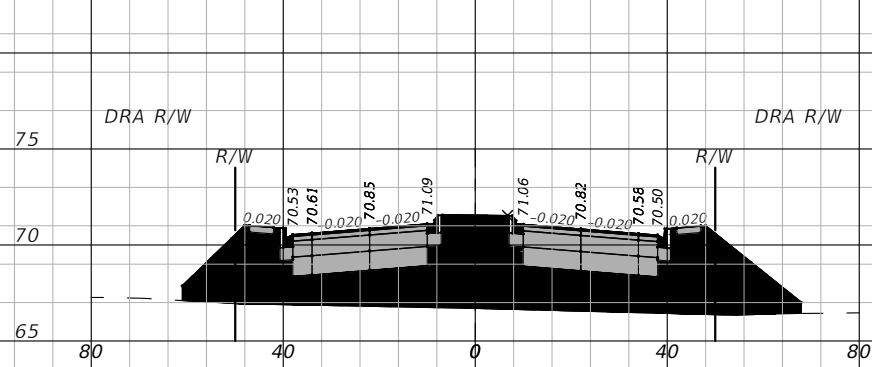


215+75.00

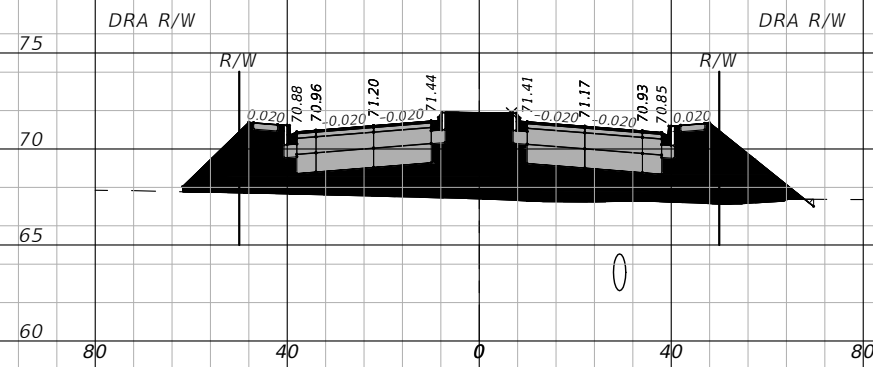


216+50.00

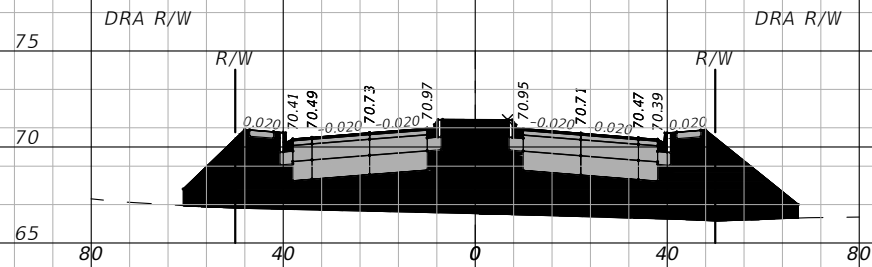


215+50.00

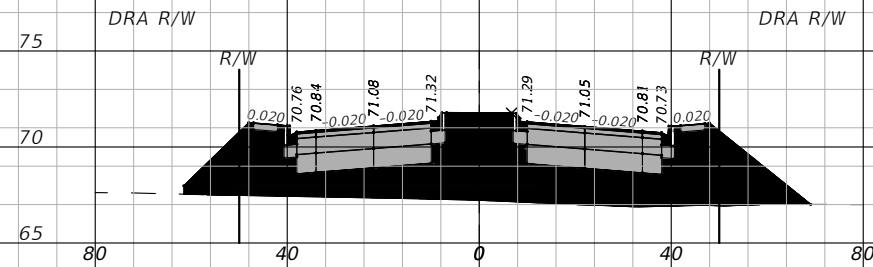

216+25.00

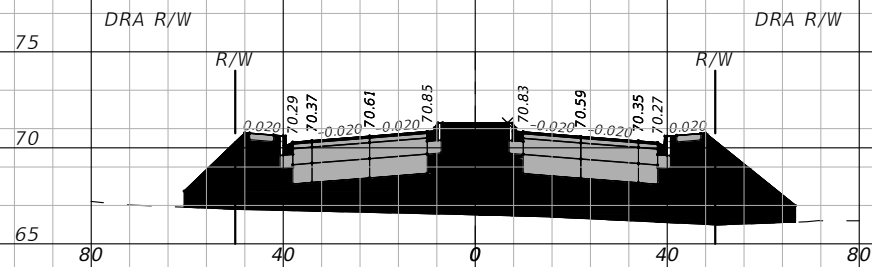

215+25.00

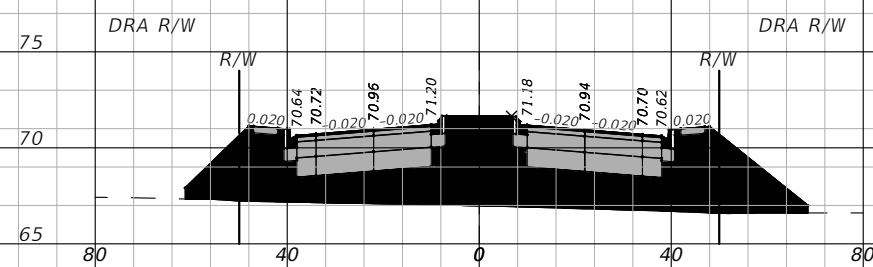

216+00.00

1" = 40' Horizontal
1" = 10' Vertical

REVISIONS			
DATE	DESCRIPTION	DATE	DESCRIPTION
11/30/22	ADDED TCE REFERENCES		
1/23/23	REMOVED TCE REFERENCES NEAR DRA		


NOEL JOHN COOPER, P.E.
P.E. LICENSE NUMBER 69534
STATE OF FLORIDA, DATE: _____
VALID ONLY WITH EMBOSSED SEAL.

PREPARED BY
OCALA
CITY ENGINEER'S OFFICE


NW 44th AVENUE EXTENSION PHASE 2
ROADWAY
CROSS-SECTIONS - (11)

SHEET NO.
44

THE OFFICIAL RECORD OF THIS SHEET IS THE ELECTRONIC FILE - DIGITALLY SIGNED AND SEALED UNDER RULE 61G15-23.004, F.A.C.

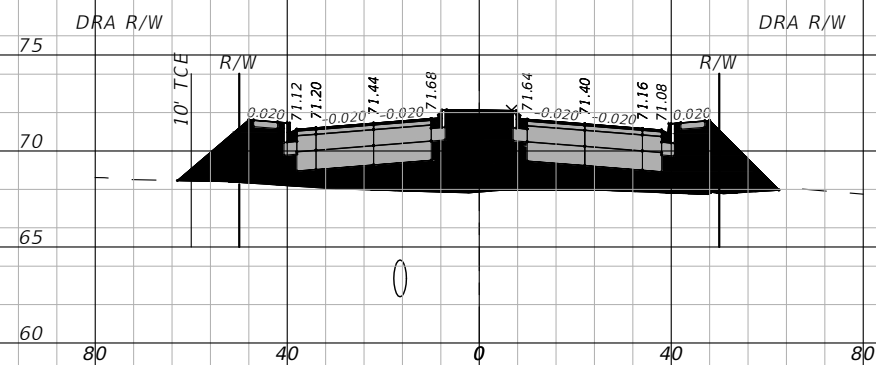


217+00.00

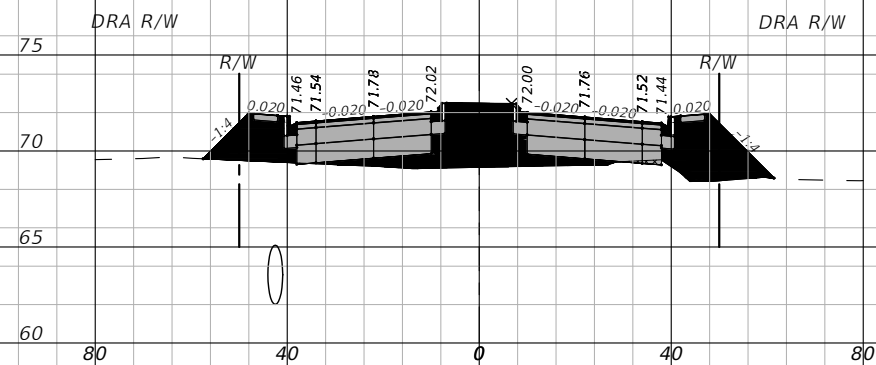


217+75.00




216+82.48

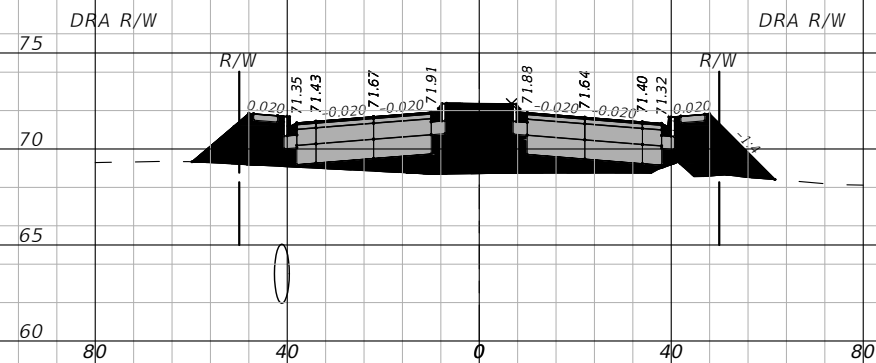

217+50.00

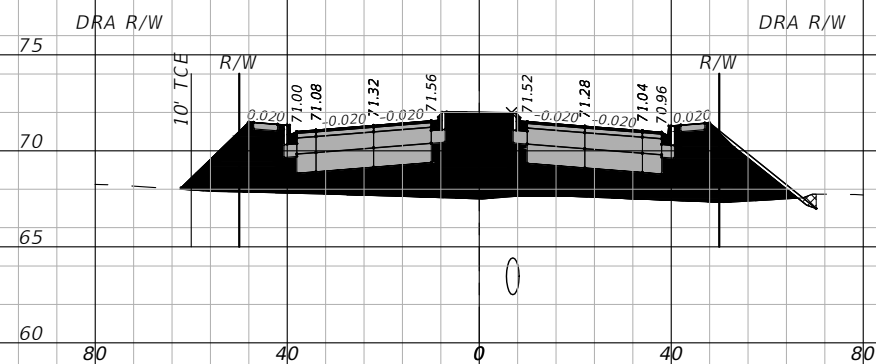

216+75.00

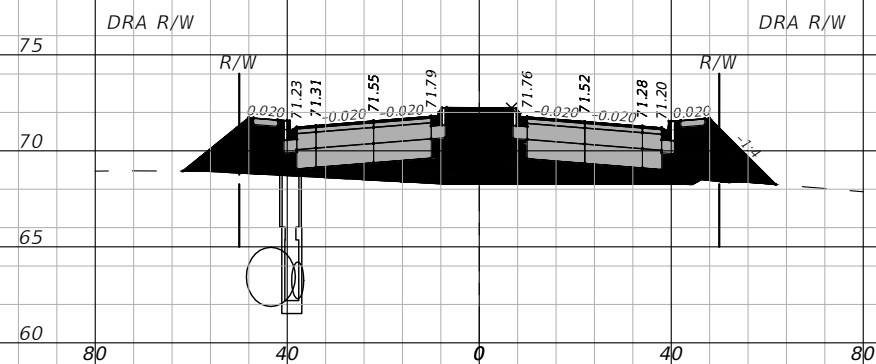

217+25.00

1" = 40' Horizontal
1" = 10' Vertical

REVISIONS			
DATE	DESCRIPTION	DATE	DESCRIPTION
11/30/22	ADDED TCE REFERENCES		
1/23/23	REVISED TCE REFERENCES NEAR DRA		

NOEL JOHN COOPER, P.E.
P.E. LICENSE NUMBER 69534
STATE OF FLORIDA, DATE: _____
VALID ONLY WITH EMBOSSED SEAL.

PREPARED BY


Gary Anson

NW 44th AVENUE EXTENSION PHASE 2


ROADWAY CROSS-SECTIONS - (12)

SHEET NO.
45


THE OFFICIAL RECORD OF THIS SHEET IS THE ELECTRONIC FILE DIGITALLY SIGNED AND SEALED UNDER RULE 61G15-23.004, F.A.C.

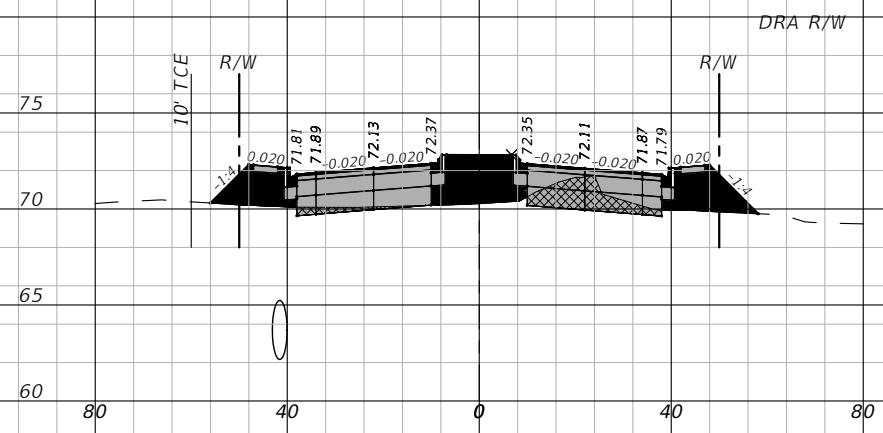


218+49.19

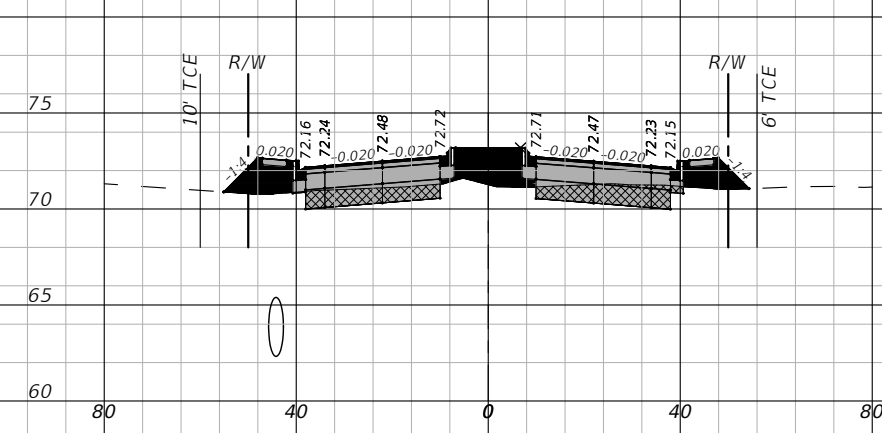


219+25.00

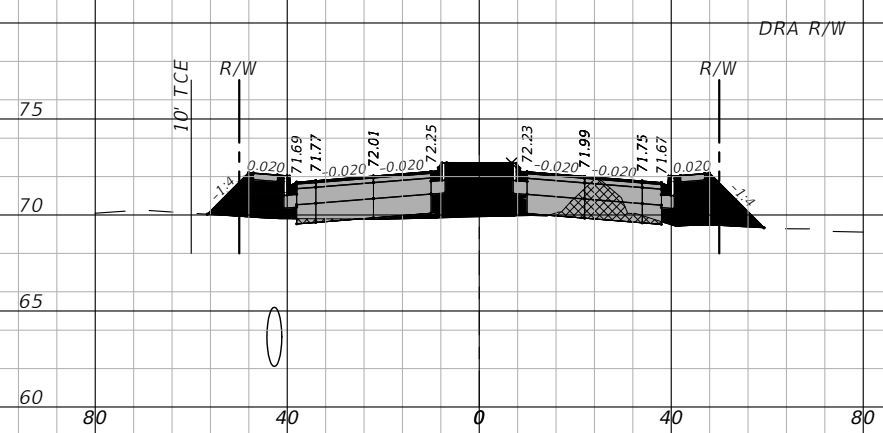


218+25.00

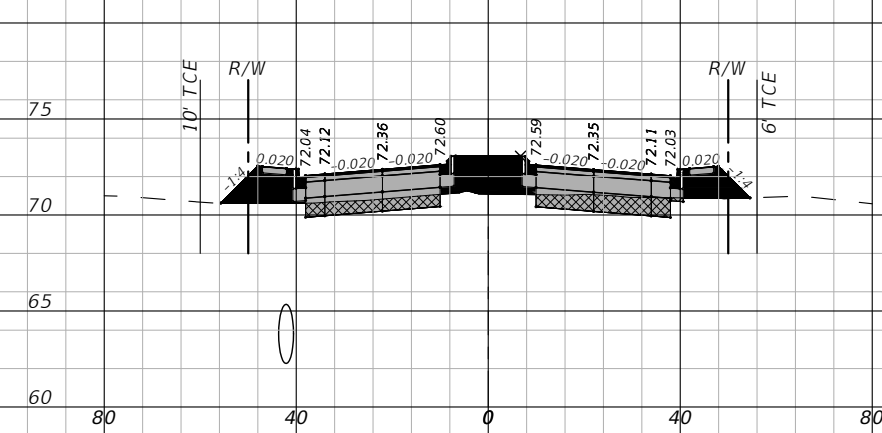

219+00.00

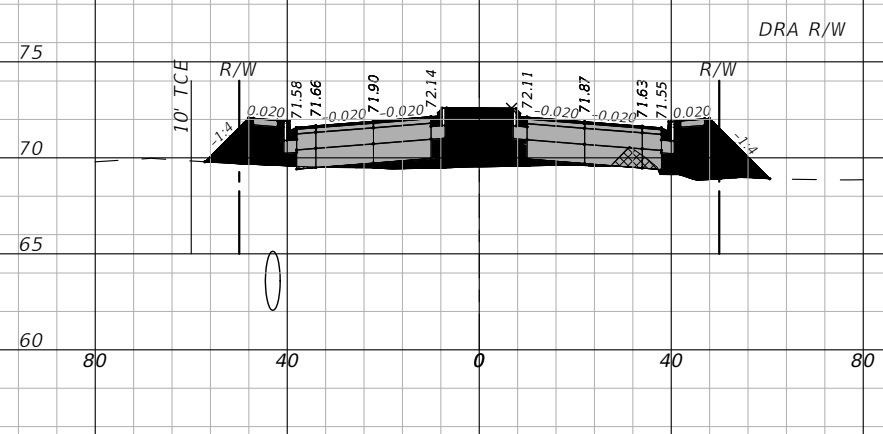

218+00.00

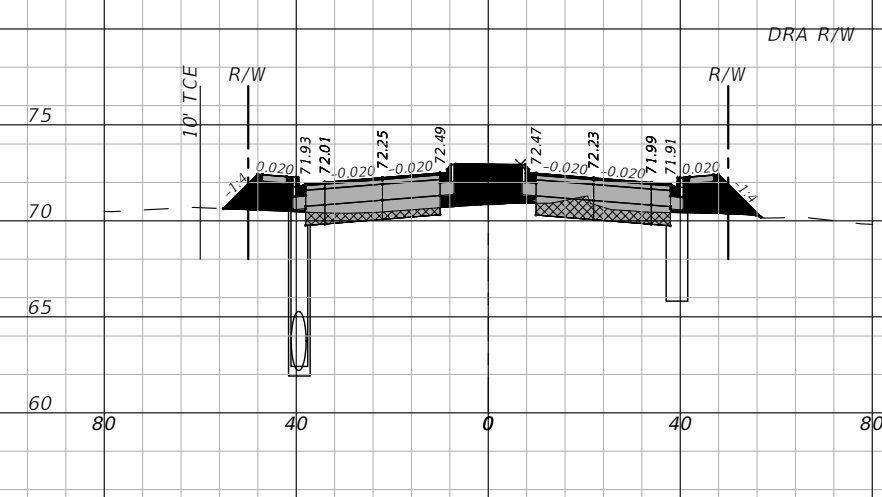

218+75.00

1" = 40' Horizontal
1" = 10' Vertical

REVISIONS			
DATE	DESCRIPTION	DATE	DESCRIPTION
11/30/22	ADDED TCE REFERENCES		

NOEL JOHN COOPER, P.E.
P.E. LICENSE NUMBER 69534
STATE OF FLORIDA, DATE: _____
VALID ONLY WITH EMBOSSED SEAL.

PREPARED BY


Gary Anson

NW 44th AVENUE EXTENSION PHASE 2


ROADWAY CROSS-SECTIONS - (13)

SHEET NO.
46


THE OFFICIAL RECORD OF THIS SHEET IS THE ELECTRONIC FILE DIGITALLY SIGNED AND SEALED UNDER RULE 61G15-23.004, F.A.C.

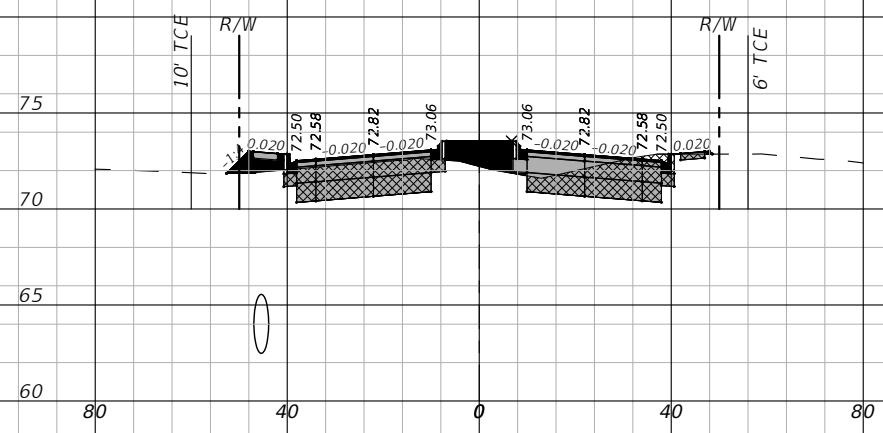


220+00.00

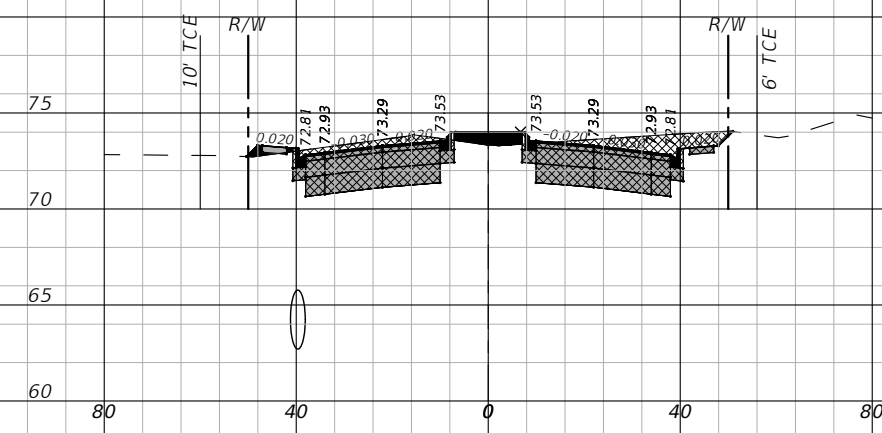


221+00.00

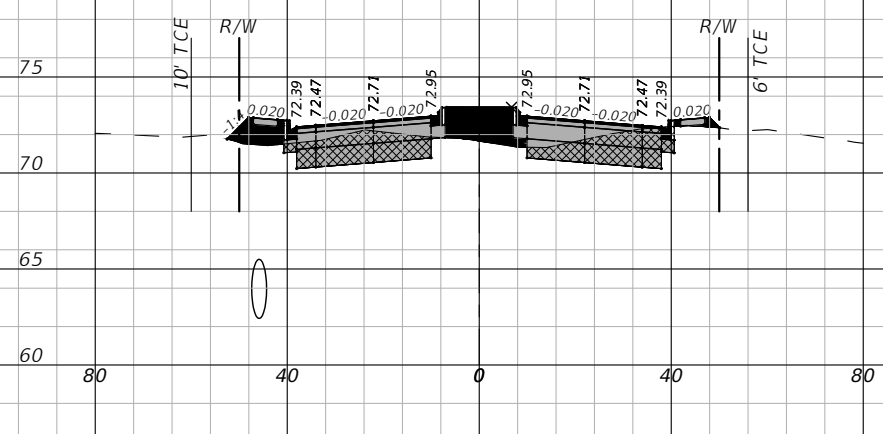


219+75.00

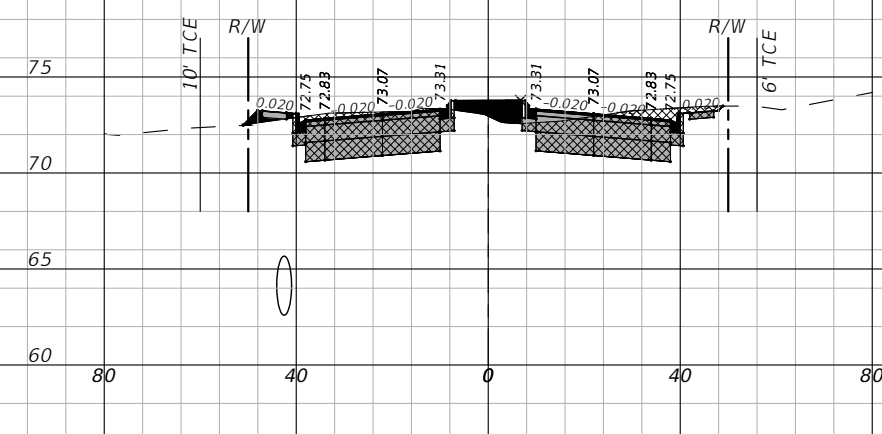

220+52.29

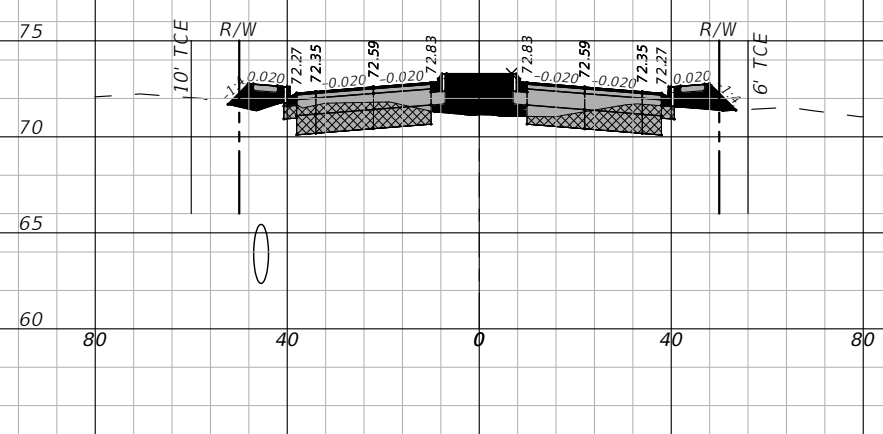

219+50.00

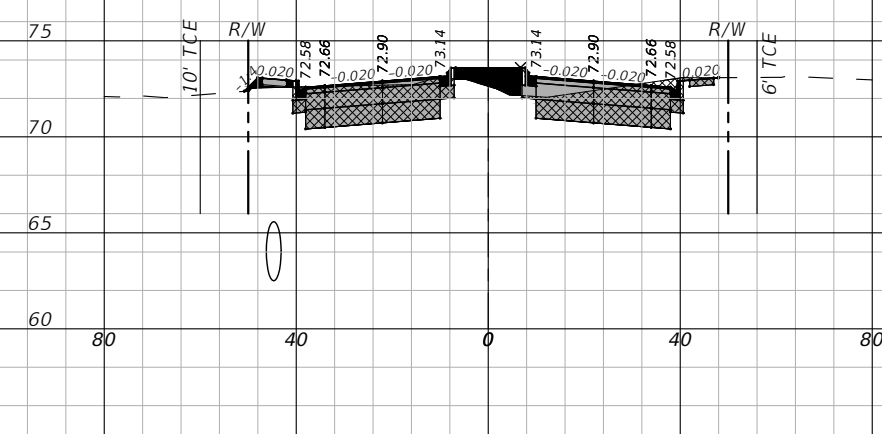

220+15.89

1" = 40' Horizontal
1" = 10' Vertical

REVISIONS			
DATE	DESCRIPTION	DATE	DESCRIPTION
11/30/22	ADDED TCE REFERENCES		

NOEL JOHN COOPER, P.E.
P.E. LICENSE NUMBER 69534
STATE OF FLORIDA, DATE: _____
VALID ONLY WITH EMBOSSED SEAL.

PREPARED BY


Gary Anson

NW 44th AVENUE EXTENSION PHASE 2


ROADWAY CROSS-SECTIONS - (14)

SHEET NO.
47


THE OFFICIAL RECORD OF THIS SHEET IS THE ELECTRONIC FILE DIGITALLY SIGNED AND SEALED UNDER RULE 61G15-23.004, F.A.C.

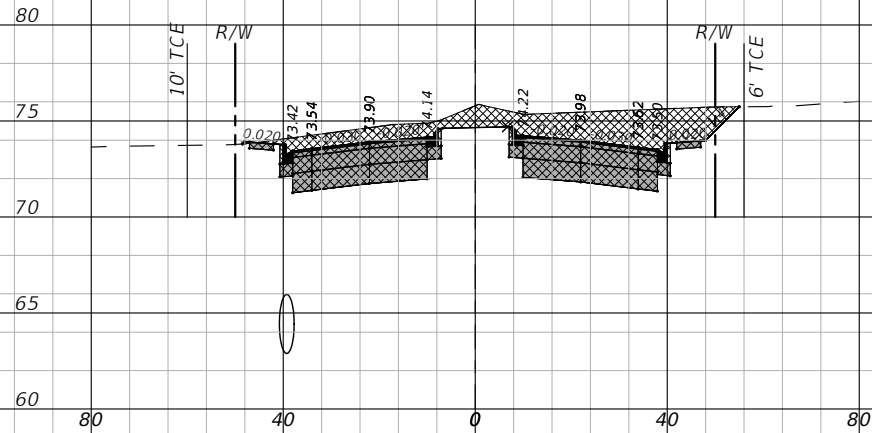


222+00.00

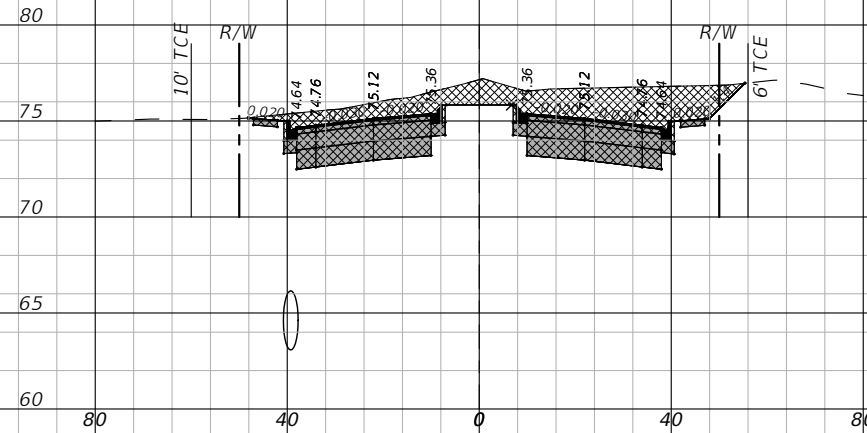

223+00.00

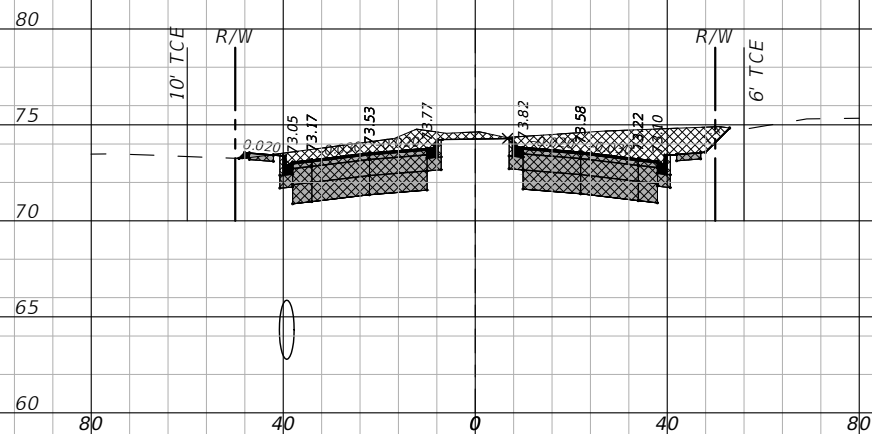

221+50.00

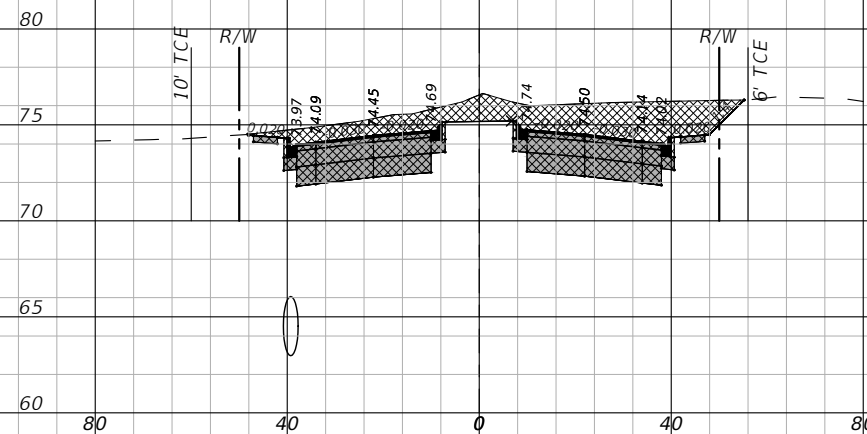

222+50.00

1" = 40' Horizontal
1" = 10' Vertical

REVISIONS			
DATE	DESCRIPTION	DATE	DESCRIPTION
11/30/22	ADDED TCE REFERENCES		

NOEL JOHN COOPER, P.E.
P.E. LICENSE NUMBER 69534
STATE OF FLORIDA, DATE: _____
VALID ONLY WITH EMBOSSED SEAL.

PREPARED BY





Gary Anson

NW 44th AVENUE EXTENSION PHASE 2

ROADWAY CROSS-SECTIONS - (15)

SHEET NO.
48

THE OFFICIAL RECORD OF THIS SHEET IS THE ELECTRONIC FILE DIGITALLY SIGNED AND SEALED UNDER RULE 61G15-23.004, F.A.C.

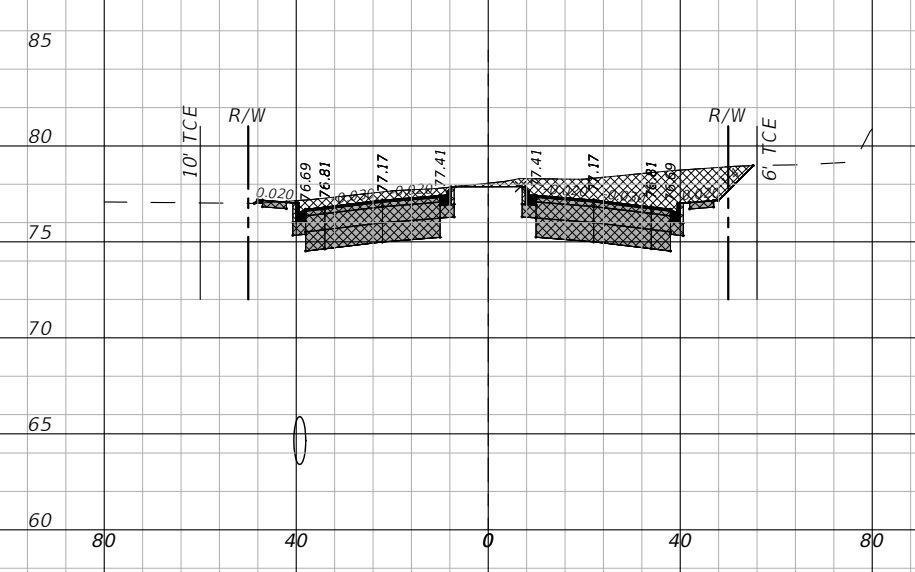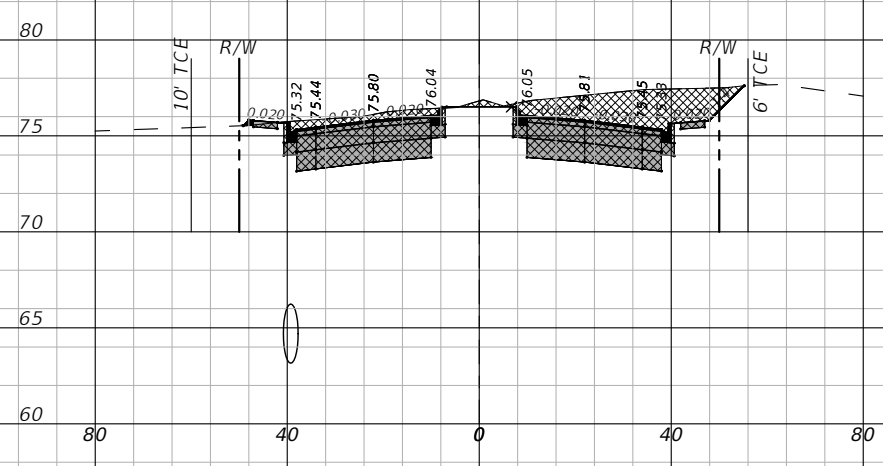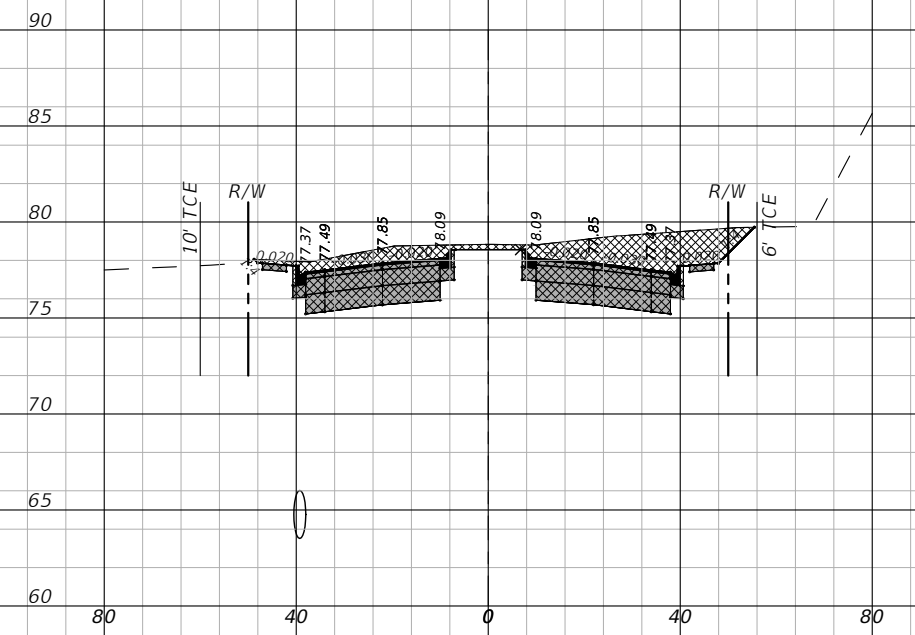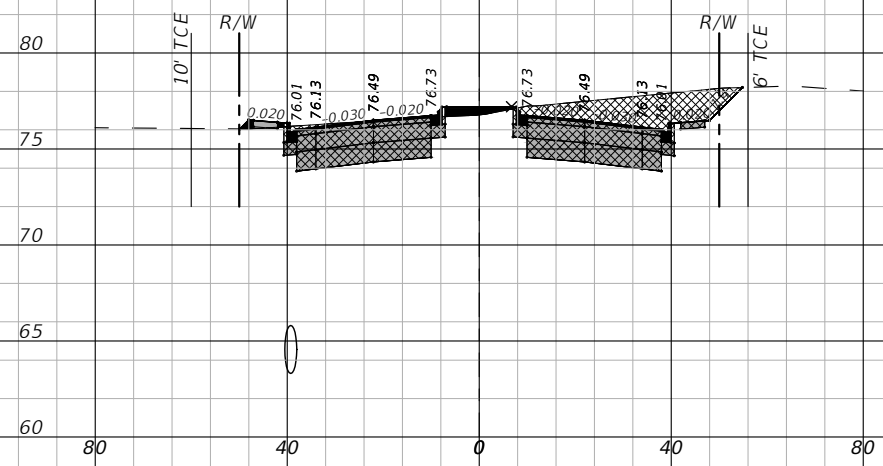

1" = 40' Horizontal
1" = 10' Vertical

REVISIONS			
DATE	DESCRIPTION	DATE	DESCRIPTION
11/30/22	ADDED TCE REFERENCES		

NOEL JOHN COOPER, P.E.
P.E. LICENSE NUMBER 69534
STATE OF FLORIDA, DATE: _____
VALID ONLY WITH EMBOSSED SEAL.

PREPARED BY


Gary Anson

NW 44th AVENUE EXTENSION PHASE 2


ROADWAY CROSS-SECTIONS - (16)

SHEET NO.
49

THE OFFICIAL RECORD OF THIS SHEET IS THE ELECTRONIC FILE DIGITALLY SIGNED AND SEALED UNDER RULE 61G15-23.004, F.A.C.

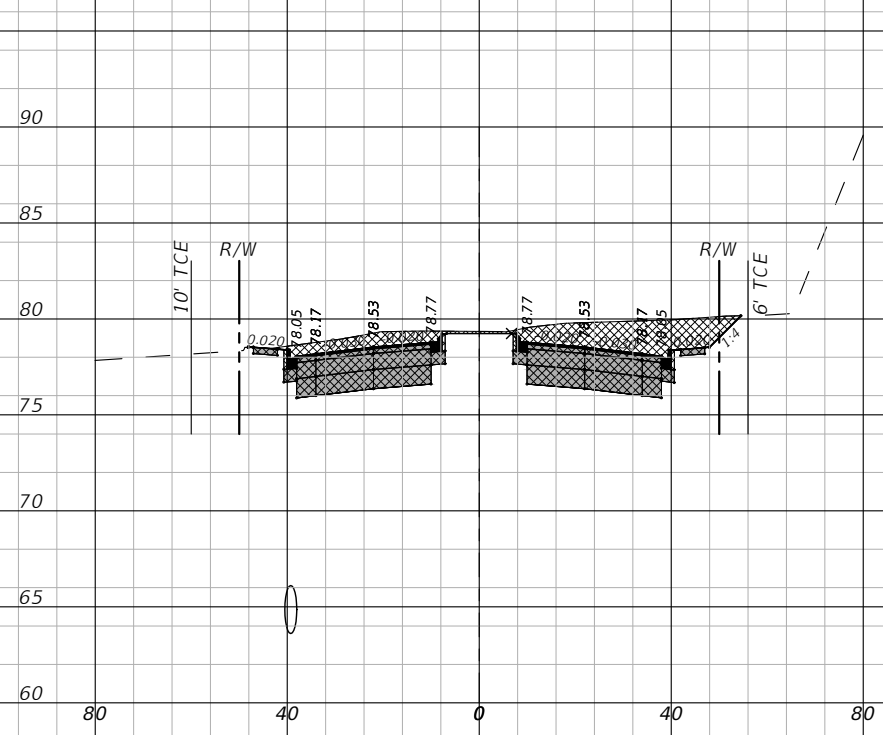

225+50.00

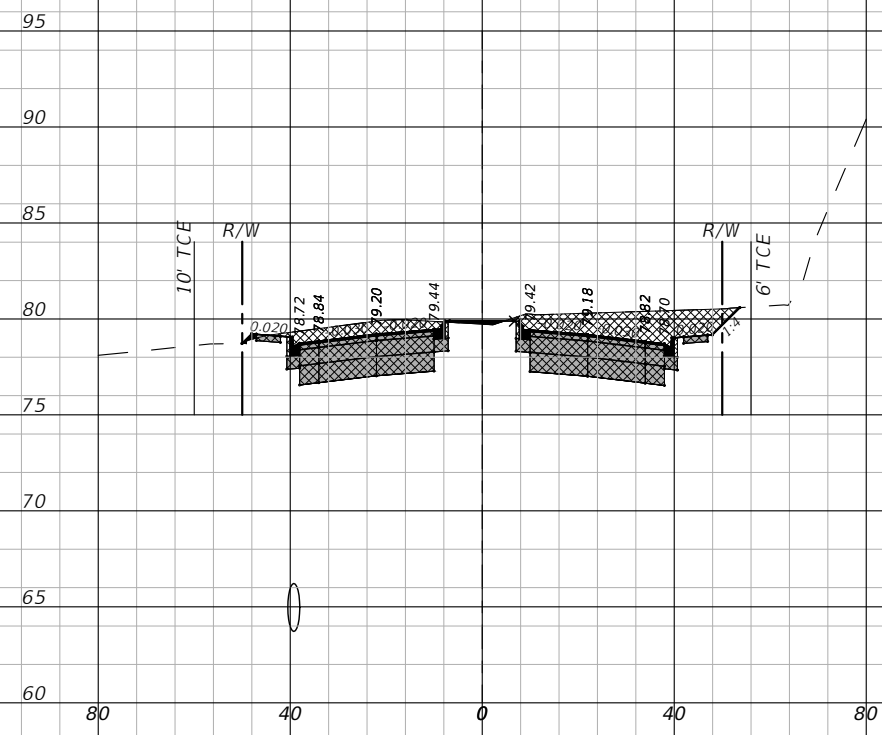

226+00.00

1" = 40' Horizontal
1" = 10' Vertical

REVISIONS			
DATE	DESCRIPTION	DATE	DESCRIPTION
11/30/22	ADDED TCE REFERENCES		

NOEL JOHN COOPER, P.E.
P.E. LICENSE NUMBER 69534
STATE OF FLORIDA, DATE: _____
VALID ONLY WITH EMBOSSED SEAL.

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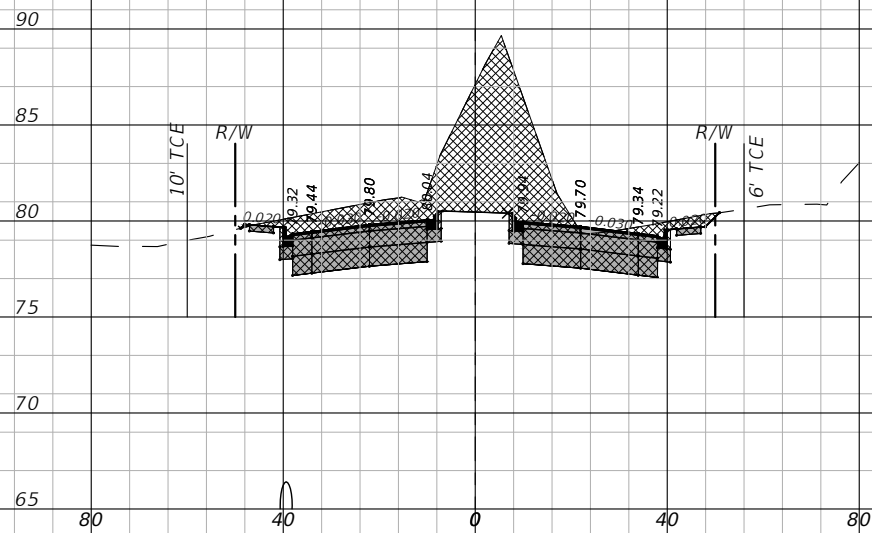
Gary Anson

NW 44th AVENUE EXTENSION PHASE 2


ROADWAY CROSS-SECTIONS - (17)

SHEET NO.
50


THE OFFICIAL RECORD OF THIS SHEET IS THE ELECTRONIC FILE DIGITALLY SIGNED AND SEALED UNDER RULE 61G15-23.004, F.A.C.




227+00.00

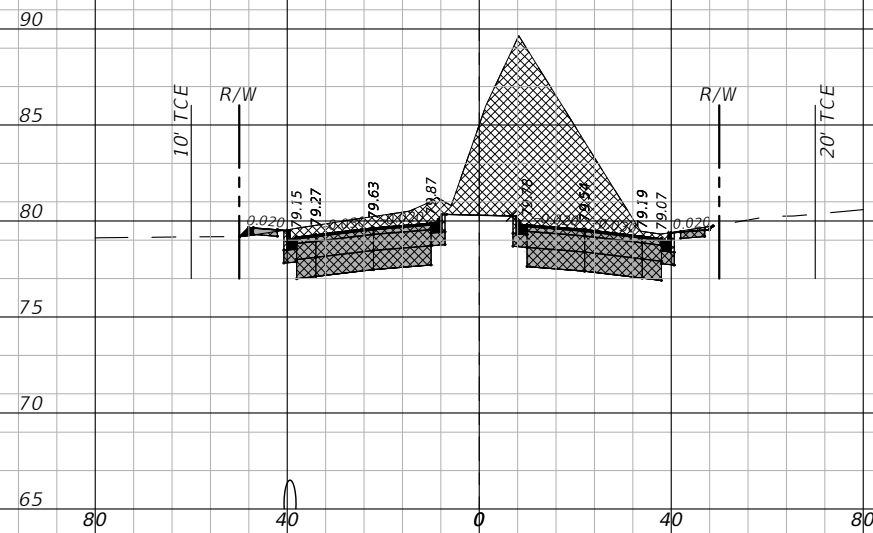

227+50.00

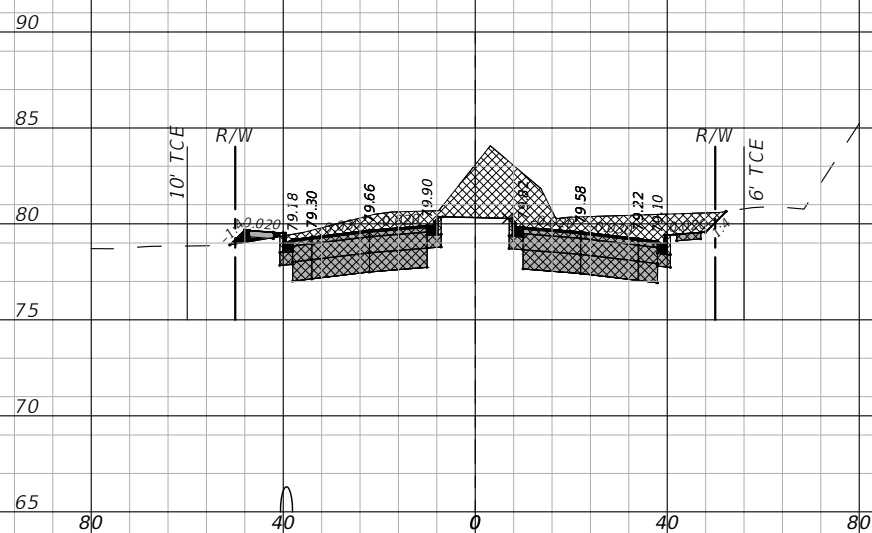

226+50.00

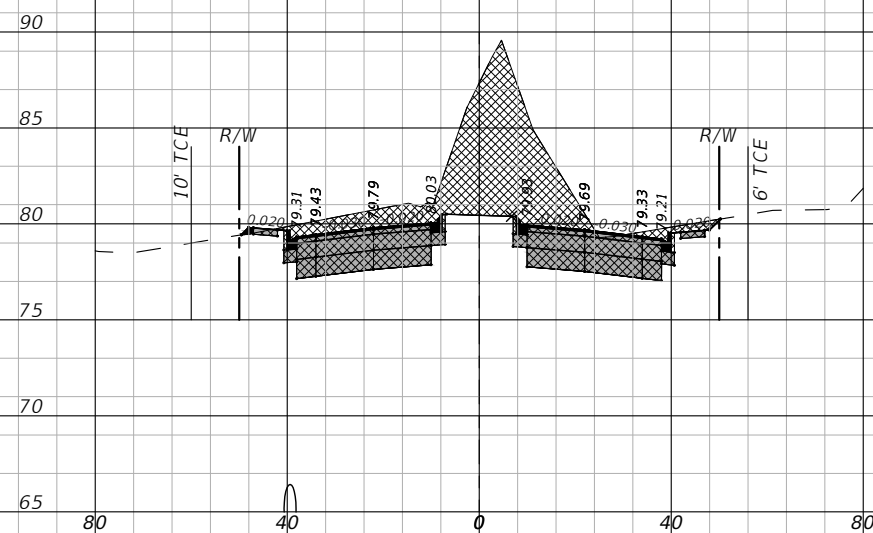

227+10.93

1" = 40' Horizontal
1" = 10' Vertical

REVISIONS			
DATE	DESCRIPTION	DATE	DESCRIPTION
11/30/22	ADDED TCE REFERENCES		

NOEL JOHN COOPER, P.E.
P.E. LICENSE NUMBER 69534
STATE OF FLORIDA, DATE: _____
VALID ONLY WITH EMBOSSED SEAL.

PREPARED BY


Gary Anson

NW 44th AVENUE EXTENSION PHASE 2

ROADWAY CROSS-SECTIONS - (18)

SHEET NO.
51

THE OFFICIAL RECORD OF THIS SHEET IS THE ELECTRONIC FILE DIGITALLY SIGNED AND SEALED UNDER RULE 61G15-23.004, F.A.C.

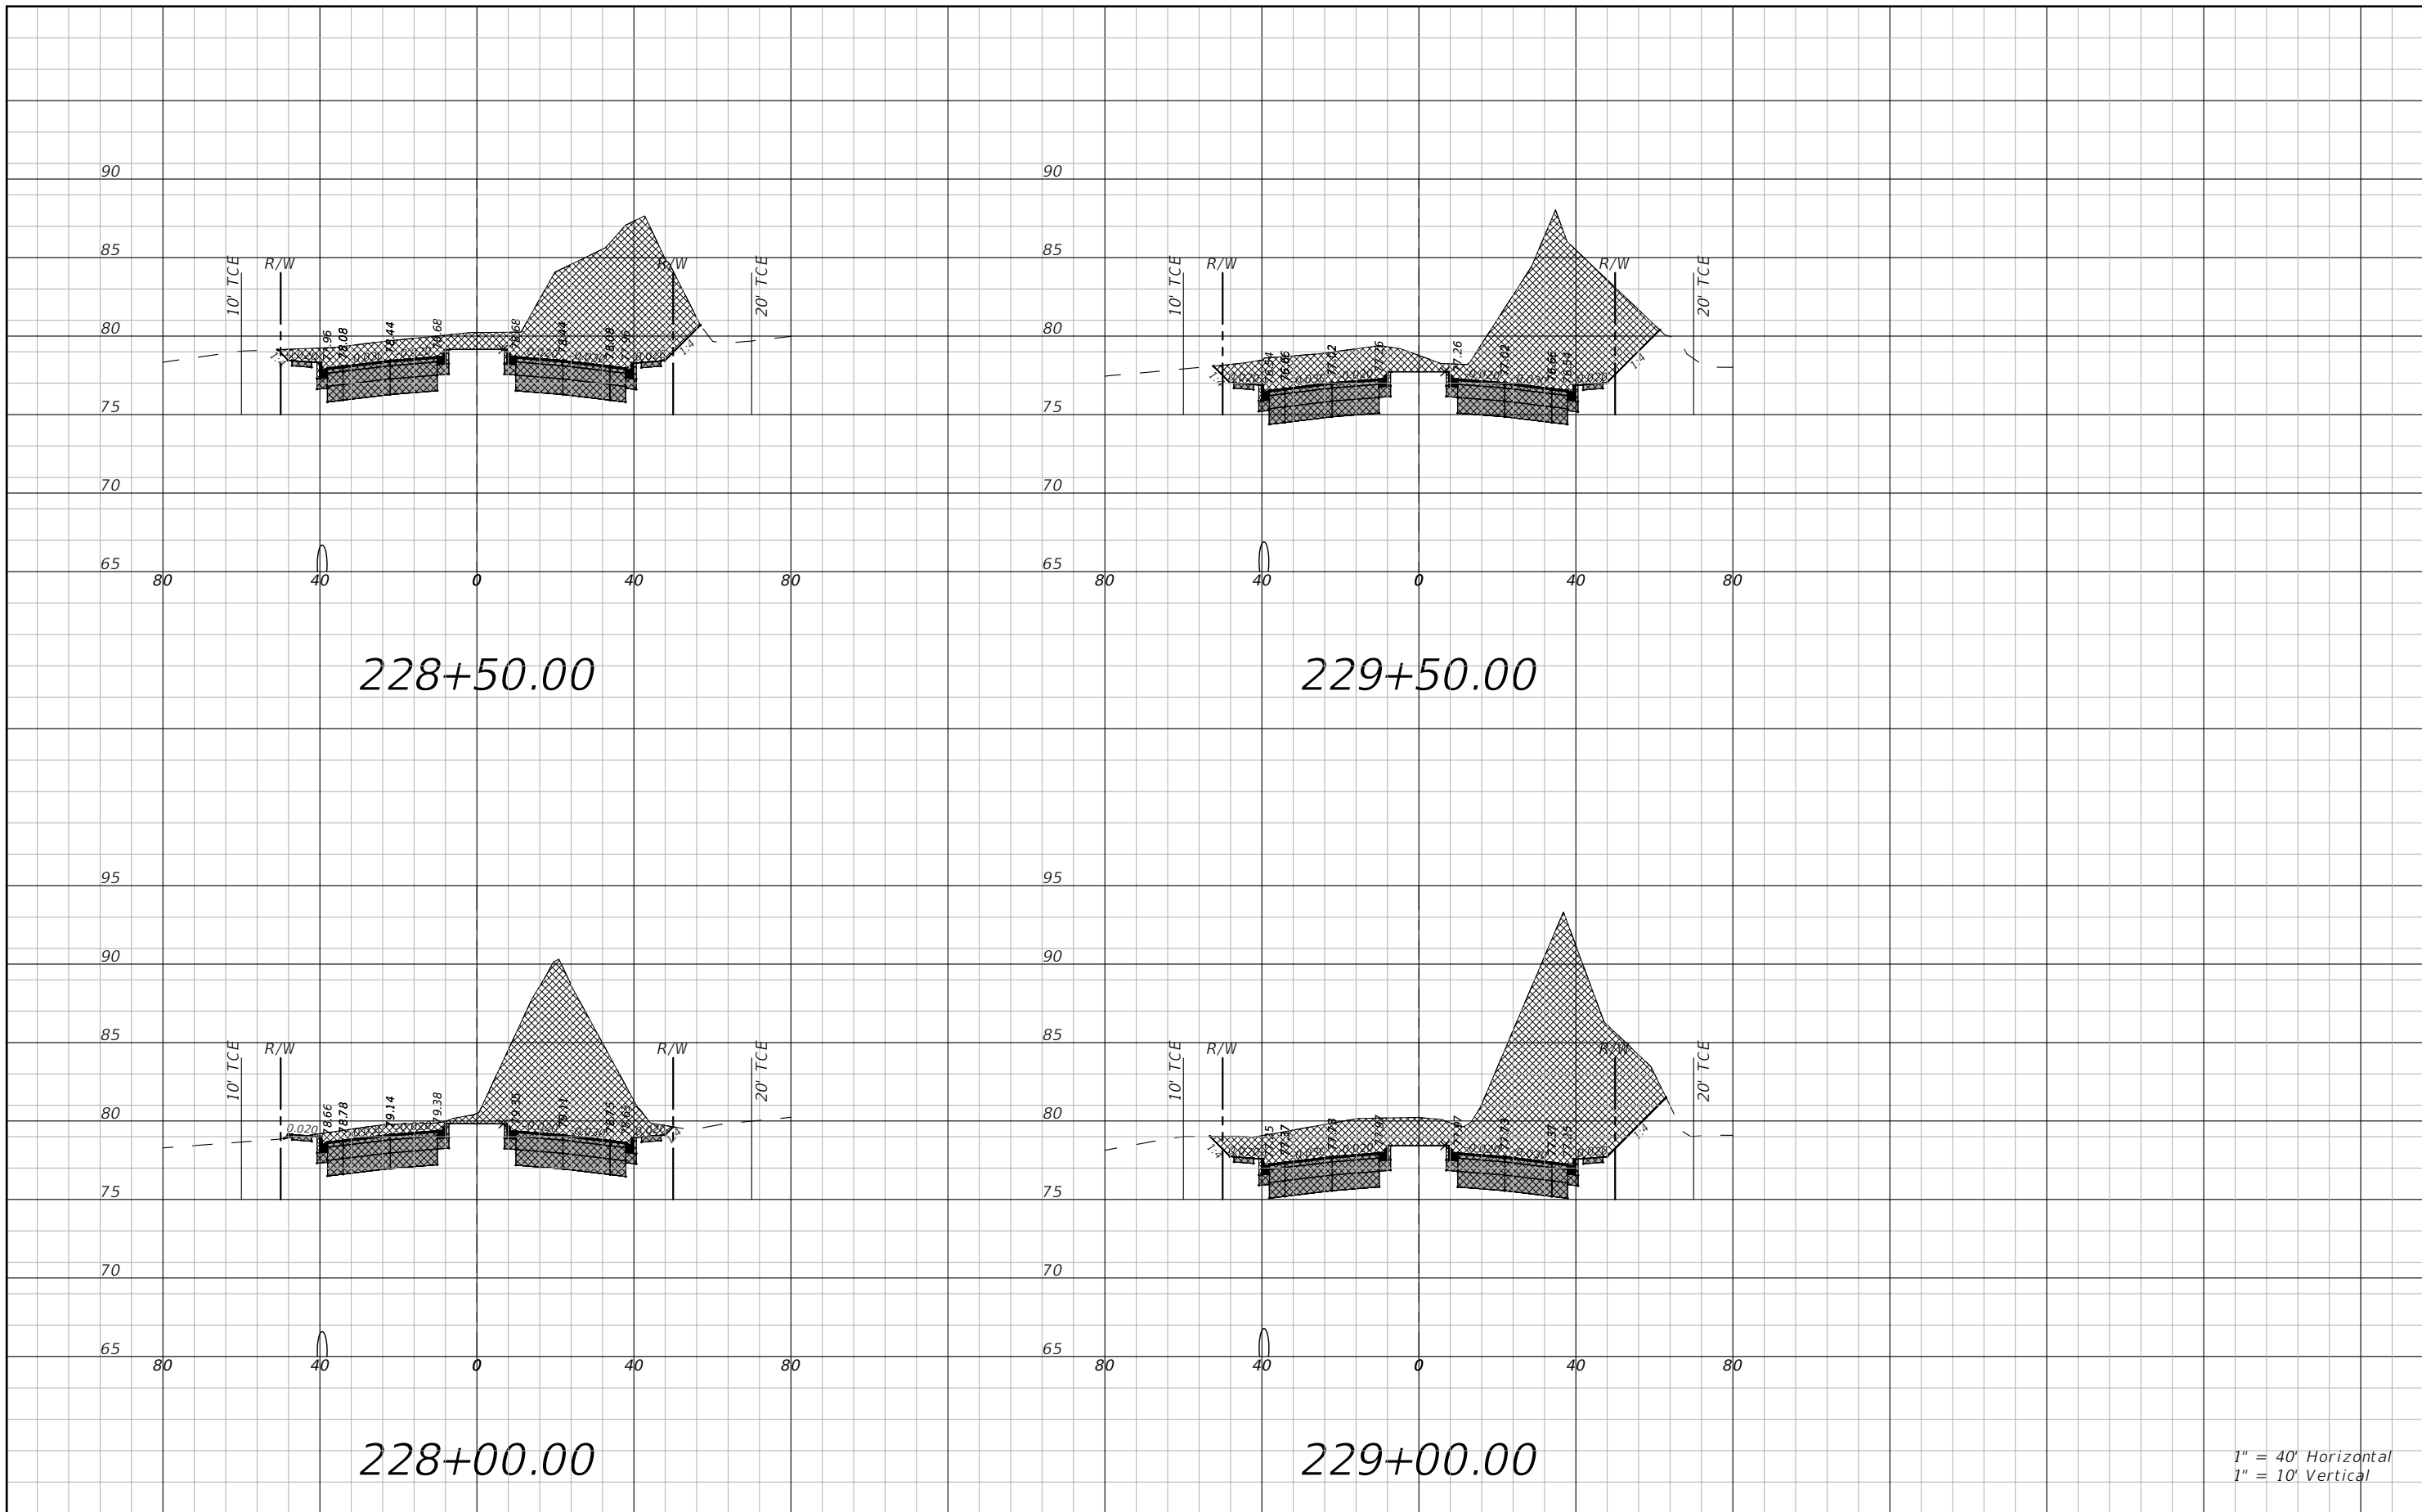

1" = 40' Horizontal
1" = 10' Vertical

REVISIONS			
DATE	DESCRIPTION	DATE	DESCRIPTION
11/30/22	ADDED TCE REFERENCES		

NOEL JOHN COOPER, P.E.
P.E. LICENSE NUMBER 69534
STATE OF FLORIDA, DATE: _____
VALID ONLY WITH EMBOSSED SEAL.

PREPARED BY


Gary Anson

NW 44th AVENUE EXTENSION PHASE 2


ROADWAY CROSS-SECTIONS - (19)

SHEET NO.
52


THE OFFICIAL RECORD OF THIS SHEET IS THE ELECTRONIC FILE DIGITALLY SIGNED AND SEALED UNDER RULE 61G15-23.004, F.A.C.

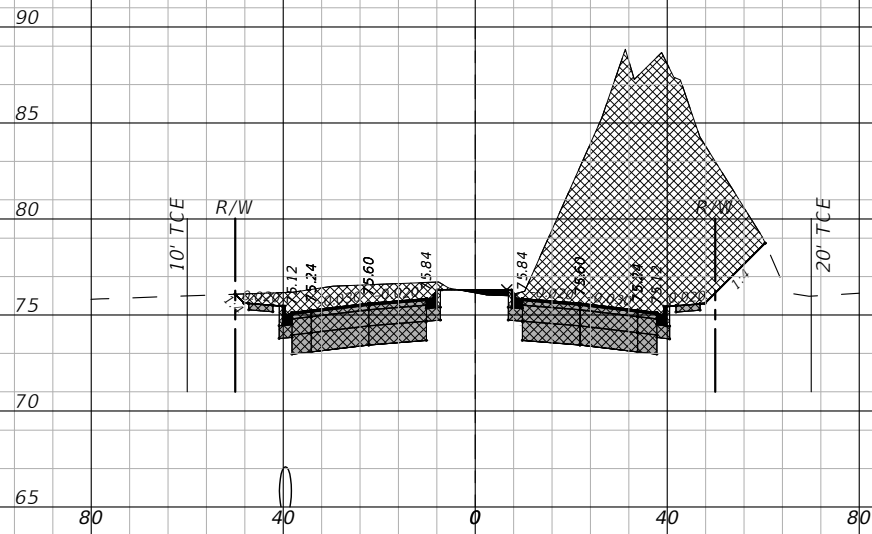


230+50.00

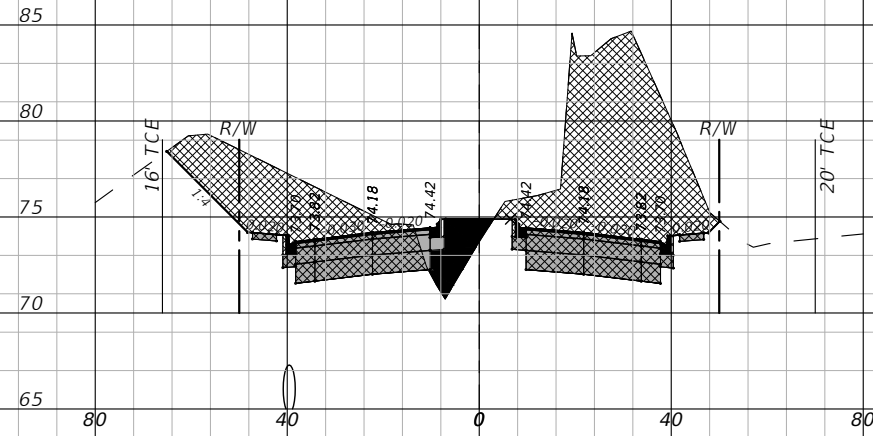

231+50.00

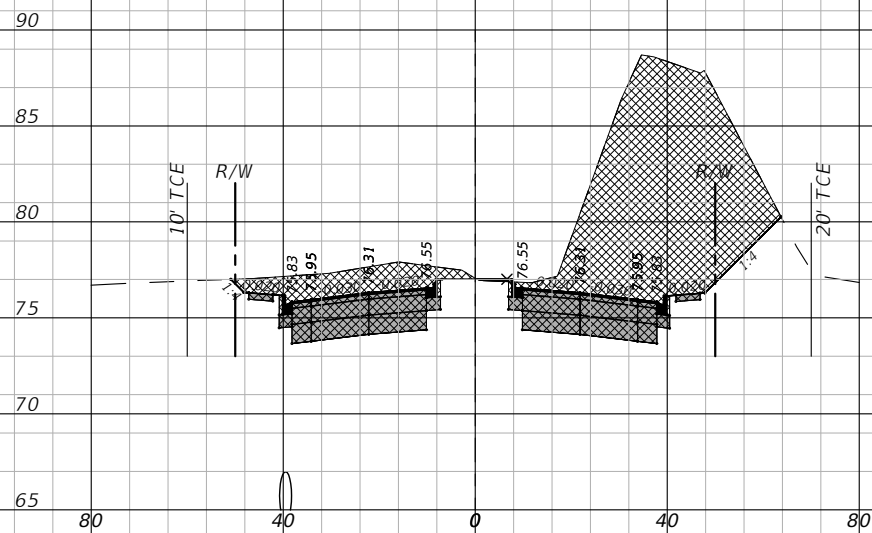

230+00.00

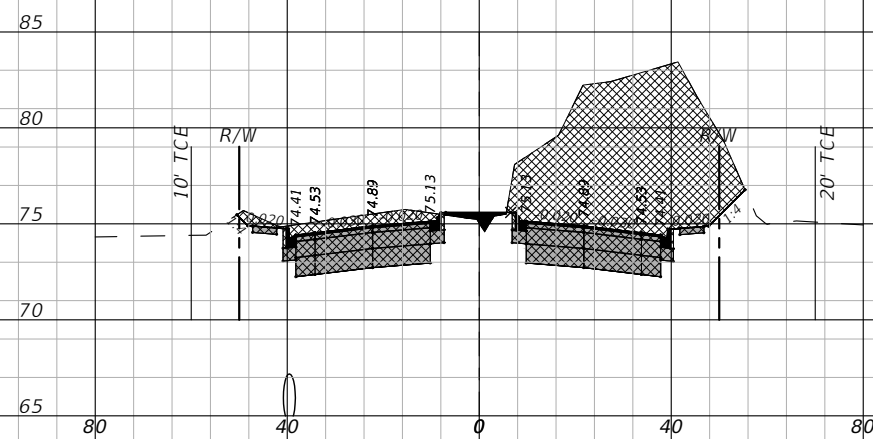

231+00.00

1" = 40' Horizontal
1" = 10' Vertical

REVISIONS			
DATE	DESCRIPTION	DATE	DESCRIPTION
11/30/22	ADDED TCE REFERENCES		
1/23/23	REVISED TCE REFERENCE		

NOEL JOHN COOPER, P.E.
P.E. LICENSE NUMBER 69534
STATE OF FLORIDA, DATE: _____
VALID ONLY WITH EMBOSSED SEAL.

PREPARED BY


Gary Anson

NW 44th AVENUE EXTENSION PHASE 2


ROADWAY CROSS-SECTIONS - (20)

SHEET NO.
53


THE OFFICIAL RECORD OF THIS SHEET IS THE ELECTRONIC FILE DIGITALLY SIGNED AND SEALED UNDER RULE 61G15-23.004, F.A.C.

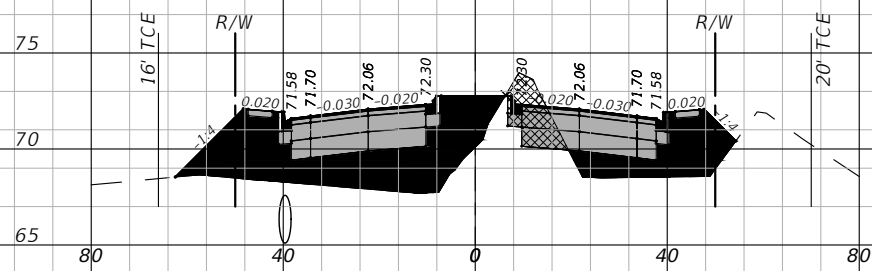


233+00.00

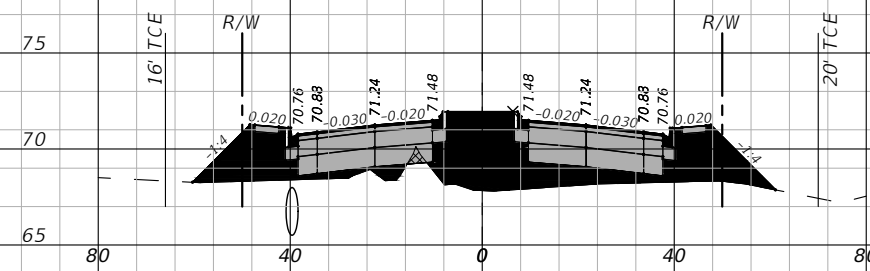


234+50.00

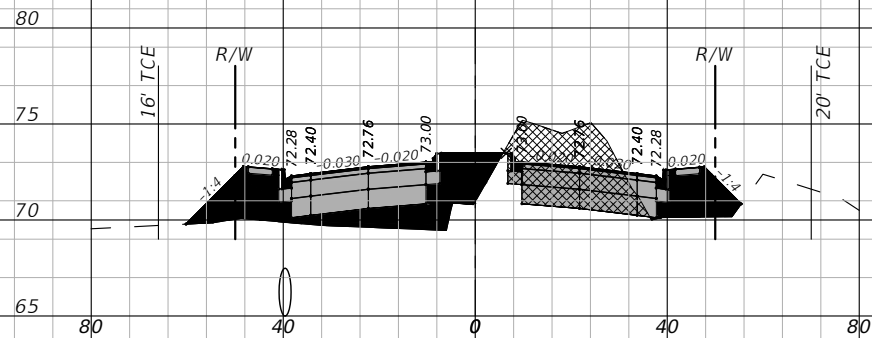


232+50.00

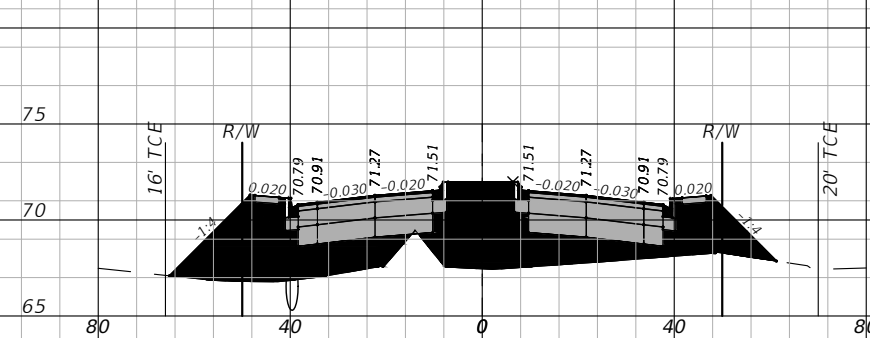

234+00.00

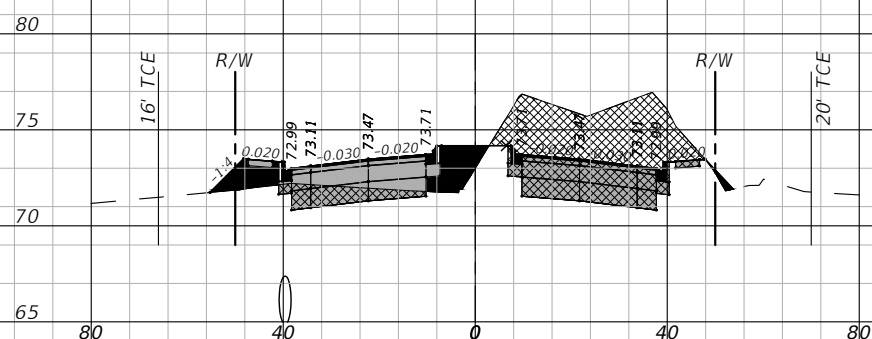

232+00.00

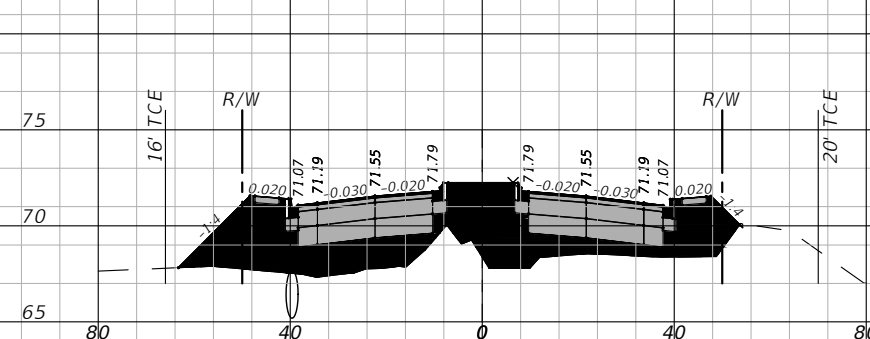

233+50.00

1" = 40' Horizontal
1" = 10' Vertical

REVISIONS			
DATE	DESCRIPTION	DATE	DESCRIPTION
11/30/22	ADDED TCE REFERENCES		

NOEL JOHN COOPER, P.E.
P.E. LICENSE NUMBER 69534
STATE OF FLORIDA, DATE: _____
VALID ONLY WITH EMBOSSED SEAL.

PREPARED BY


Gary Anson

NW 44th AVENUE EXTENSION PHASE 2


ROADWAY CROSS-SECTIONS - (21)

SHEET NO.
54


THE OFFICIAL RECORD OF THIS SHEET IS THE ELECTRONIC FILE DIGITALLY SIGNED AND SEALED UNDER RULE 61G15-23.004, F.A.C.

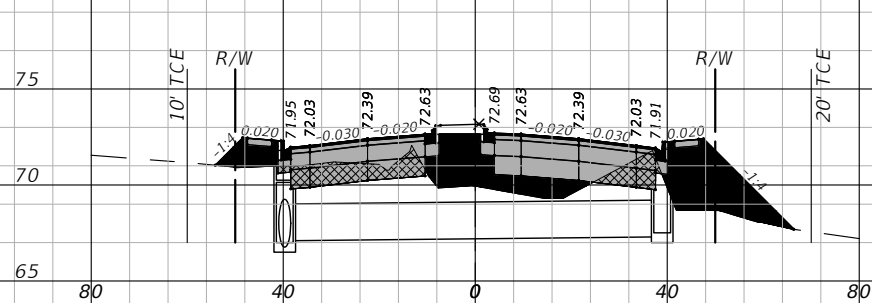


236+00.00

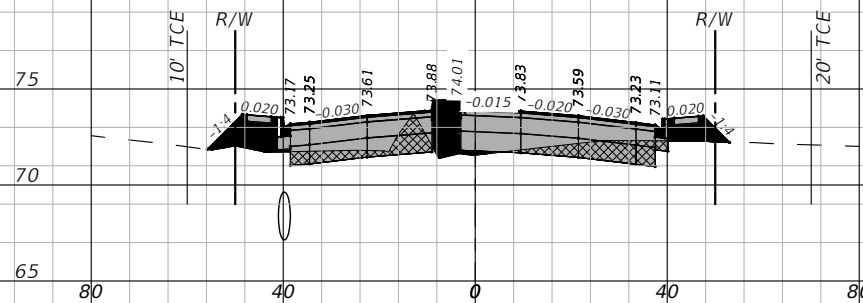


237+50.00

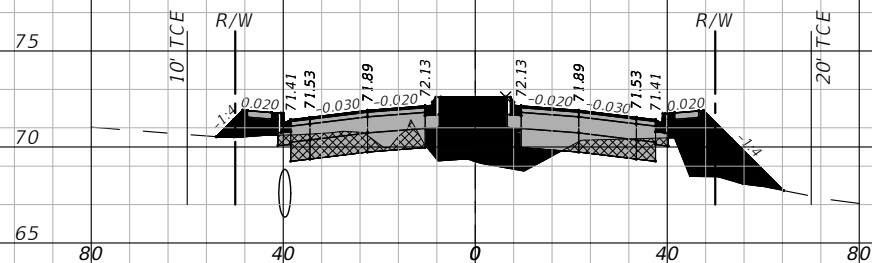


235+50.00

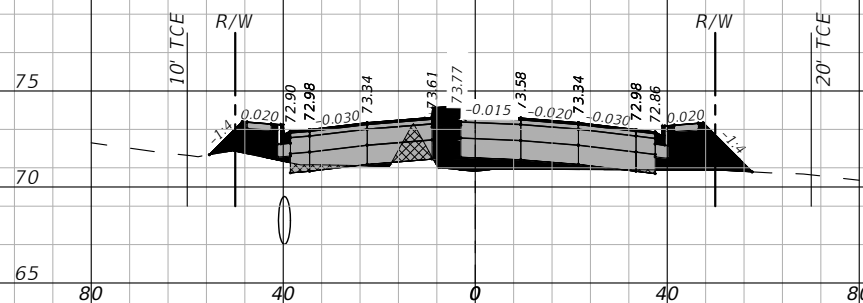

237+00.00

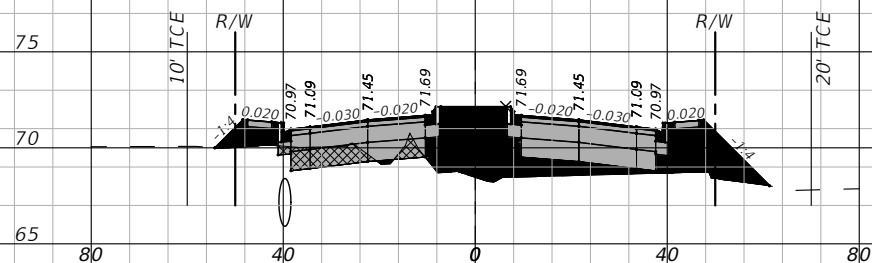

235+00.00

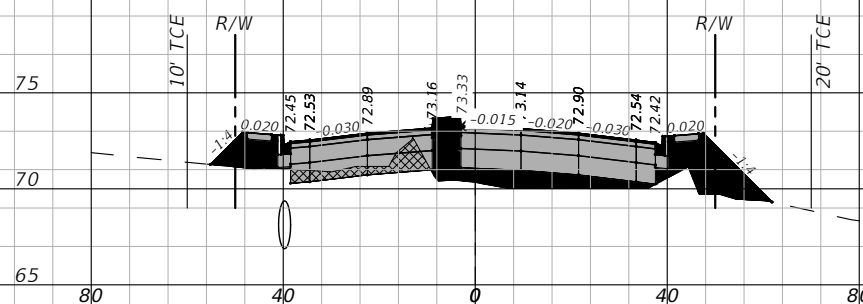

236+50.00

1" = 40' Horizontal
1" = 10' Vertical

REVISIONS			
DATE	DESCRIPTION	DATE	DESCRIPTION
11/30/22	ADDED TCE REFERENCES MODIFIED CROSS SLOPE		

NOEL JOHN COOPER, P.E.
P.E. LICENSE NUMBER 69534
STATE OF FLORIDA, DATE: _____
VALID ONLY WITH EMBOSSED SEAL.

PREPARED BY


Gary Anson

NW 44th AVENUE EXTENSION PHASE 2


ROADWAY CROSS-SECTIONS - (22)

SHEET NO.
55


THE OFFICIAL RECORD OF THIS SHEET IS THE ELECTRONIC FILE DIGITALLY SIGNED AND SEALED UNDER RULE 61G15-23.004, F.A.C.

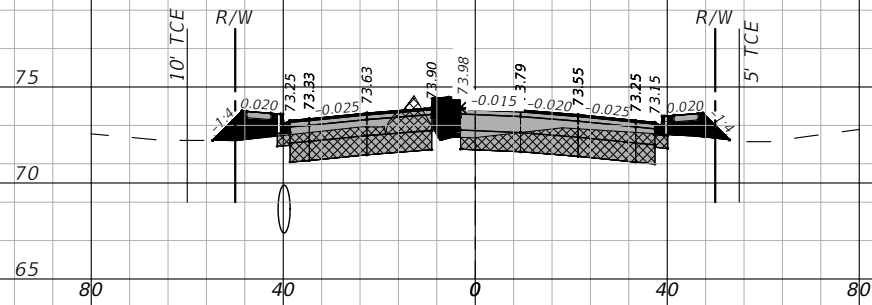


238+50.00

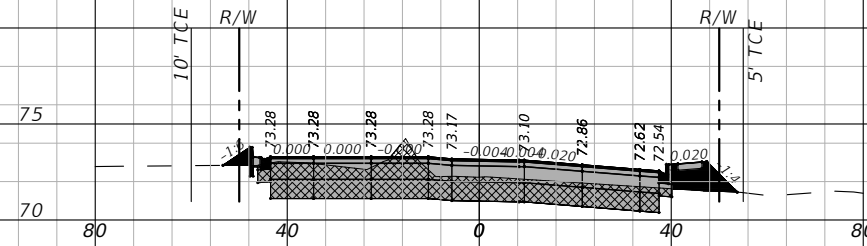


239+39.76

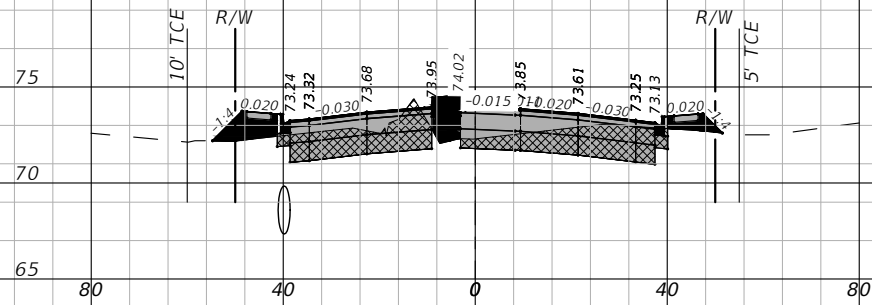


238+31.76

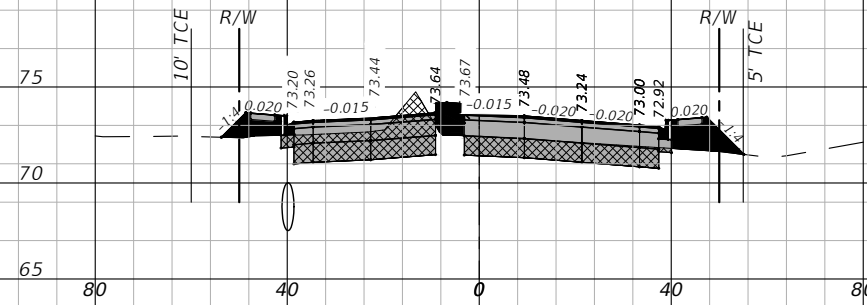

239+00.00

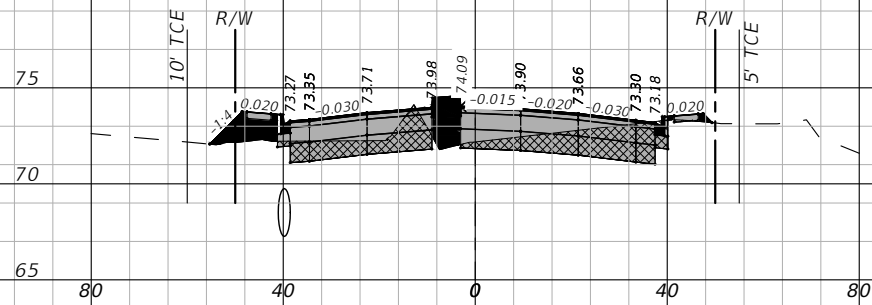

238+00.00

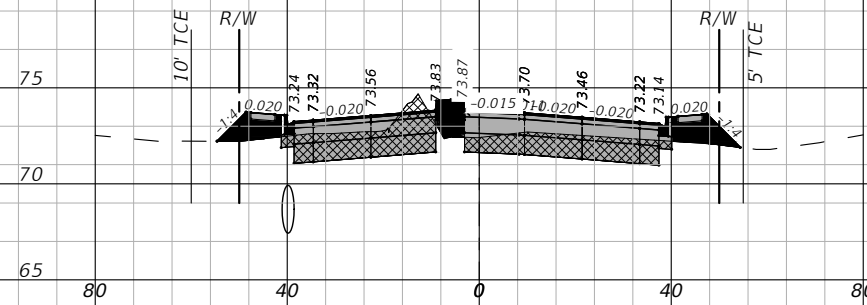

238+67.76

1" = 40' Horizontal
1" = 10' Vertical

REVISIONS	
DATE	DESCRIPTION
11/30/22	ADDED TCE REFERENCES MODIFIED CROSS-SLOPE
1/23/23	ADDED TCE REFERENCES

NOEL JOHN COOPER, P.E.
P.E. LICENSE NUMBER 69534
STATE OF FLORIDA, DATE: _____
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PREPARED BY


Gary Anson

NW 44th AVENUE EXTENSION PHASE 2

ROADWAY CROSS-SECTIONS - (23)


SHEET NO.
56

THE OFFICIAL RECORD OF THIS SHEET IS THE ELECTRONIC FILE DIGITALLY SIGNED AND SEALED UNDER RULE 61G15-23.004, F.A.C.

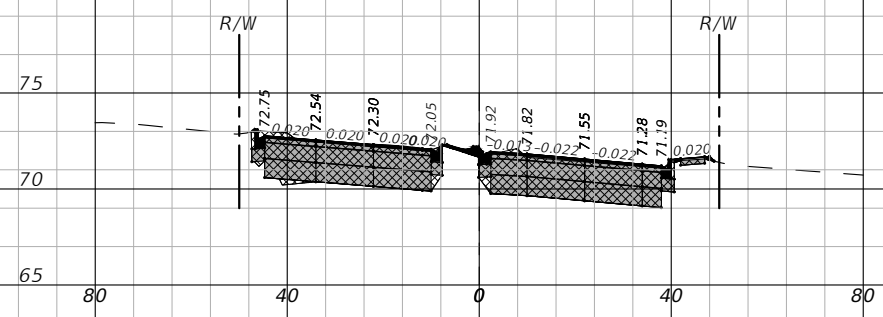


240+35.25


(END NEW PAVEMENT EARTHWORK)
(BEGIN EXISTING PAVEMENT EXPANSION & MILLING & RESURFACING EARTHWORK)

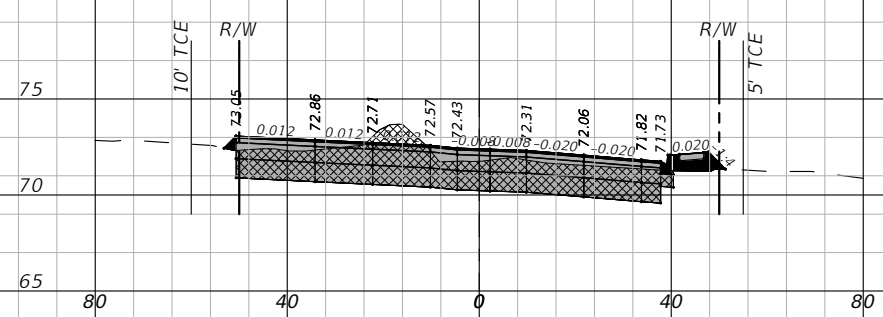


240+00.00

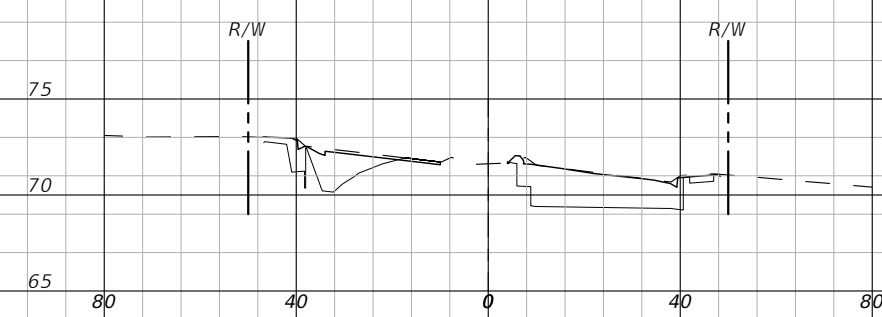

240+54.96

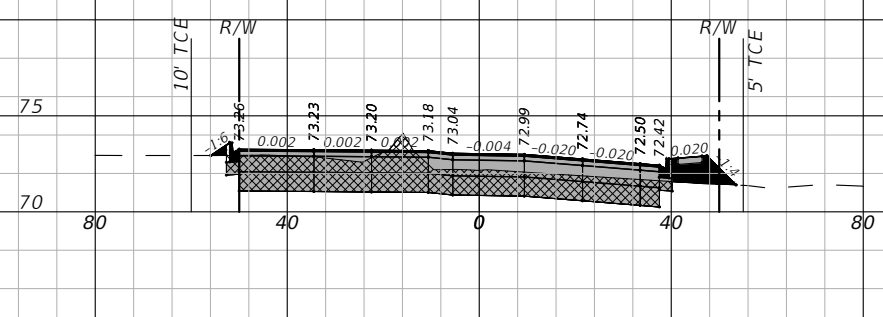

239+50.00

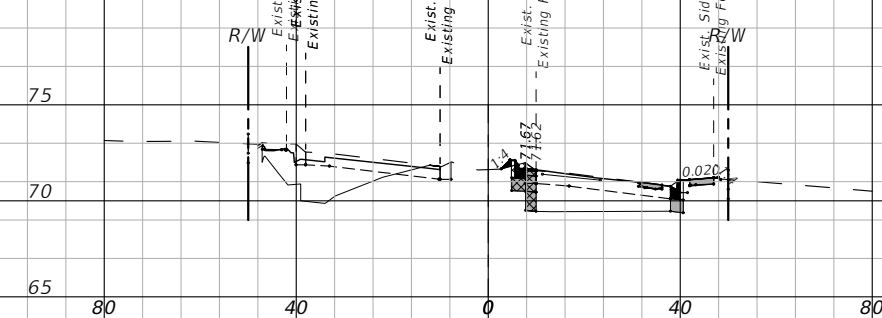

240+50.00

1" = 40' Horizontal
1" = 10' Vertical

REVISIONS			
DATE	DESCRIPTION	DATE	DESCRIPTION
11/30/22	ADDED TCE REFERENCES		

NOEL JOHN COOPER, P.E.
P.E. LICENSE NUMBER 69534
STATE OF FLORIDA, DATE: _____
VALID ONLY WITH EMBOSSED SEAL.

PREPARED BY



Gary Anson

NW 44th AVENUE EXTENSION PHASE 2

ROADWAY
CROSS-SECTIONS - (24)



SHEET NO.
57

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199+00		200+00		201+00		202+00		203+00		204+00													
REVISIONS <table border="1"> <thead> <tr> <th>DATE</th> <th>DESCRIPTION</th> <th>DATE</th> <th>DESCRIPTION</th> </tr> </thead> <tbody> <tr> <td>02/09/23</td> <td>Revised Pavement Limit</td> <td></td> <td></td> </tr> <tr> <td>2/15/23</td> <td>Removed Bore For Water Line</td> <td></td> <td></td> </tr> </tbody> </table>				DATE	DESCRIPTION	DATE	DESCRIPTION	02/09/23	Revised Pavement Limit			2/15/23	Removed Bore For Water Line			PREPARED BY 				PROJECT NO. ---- PROJECT NAME: NW 44TH AVENUE EXTENSION PHASE 2 UTILITY PLAN AND PROFILE <i>(1)</i>			
DATE	DESCRIPTION	DATE	DESCRIPTION																				
02/09/23	Revised Pavement Limit																						
2/15/23	Removed Bore For Water Line																						
DATE 02/09/23 2/15/23				DESCRIPTION Revised Pavement Limit Removed Bore For Water Line				HECTOR A. COLON, PE P.E. LICENSE NUMBER 84007 CITY OF OCALA, FLORIDA 1805 NE 30TH AVENUE OCALA, FLORIDA 34470				SHEET NO. 58											

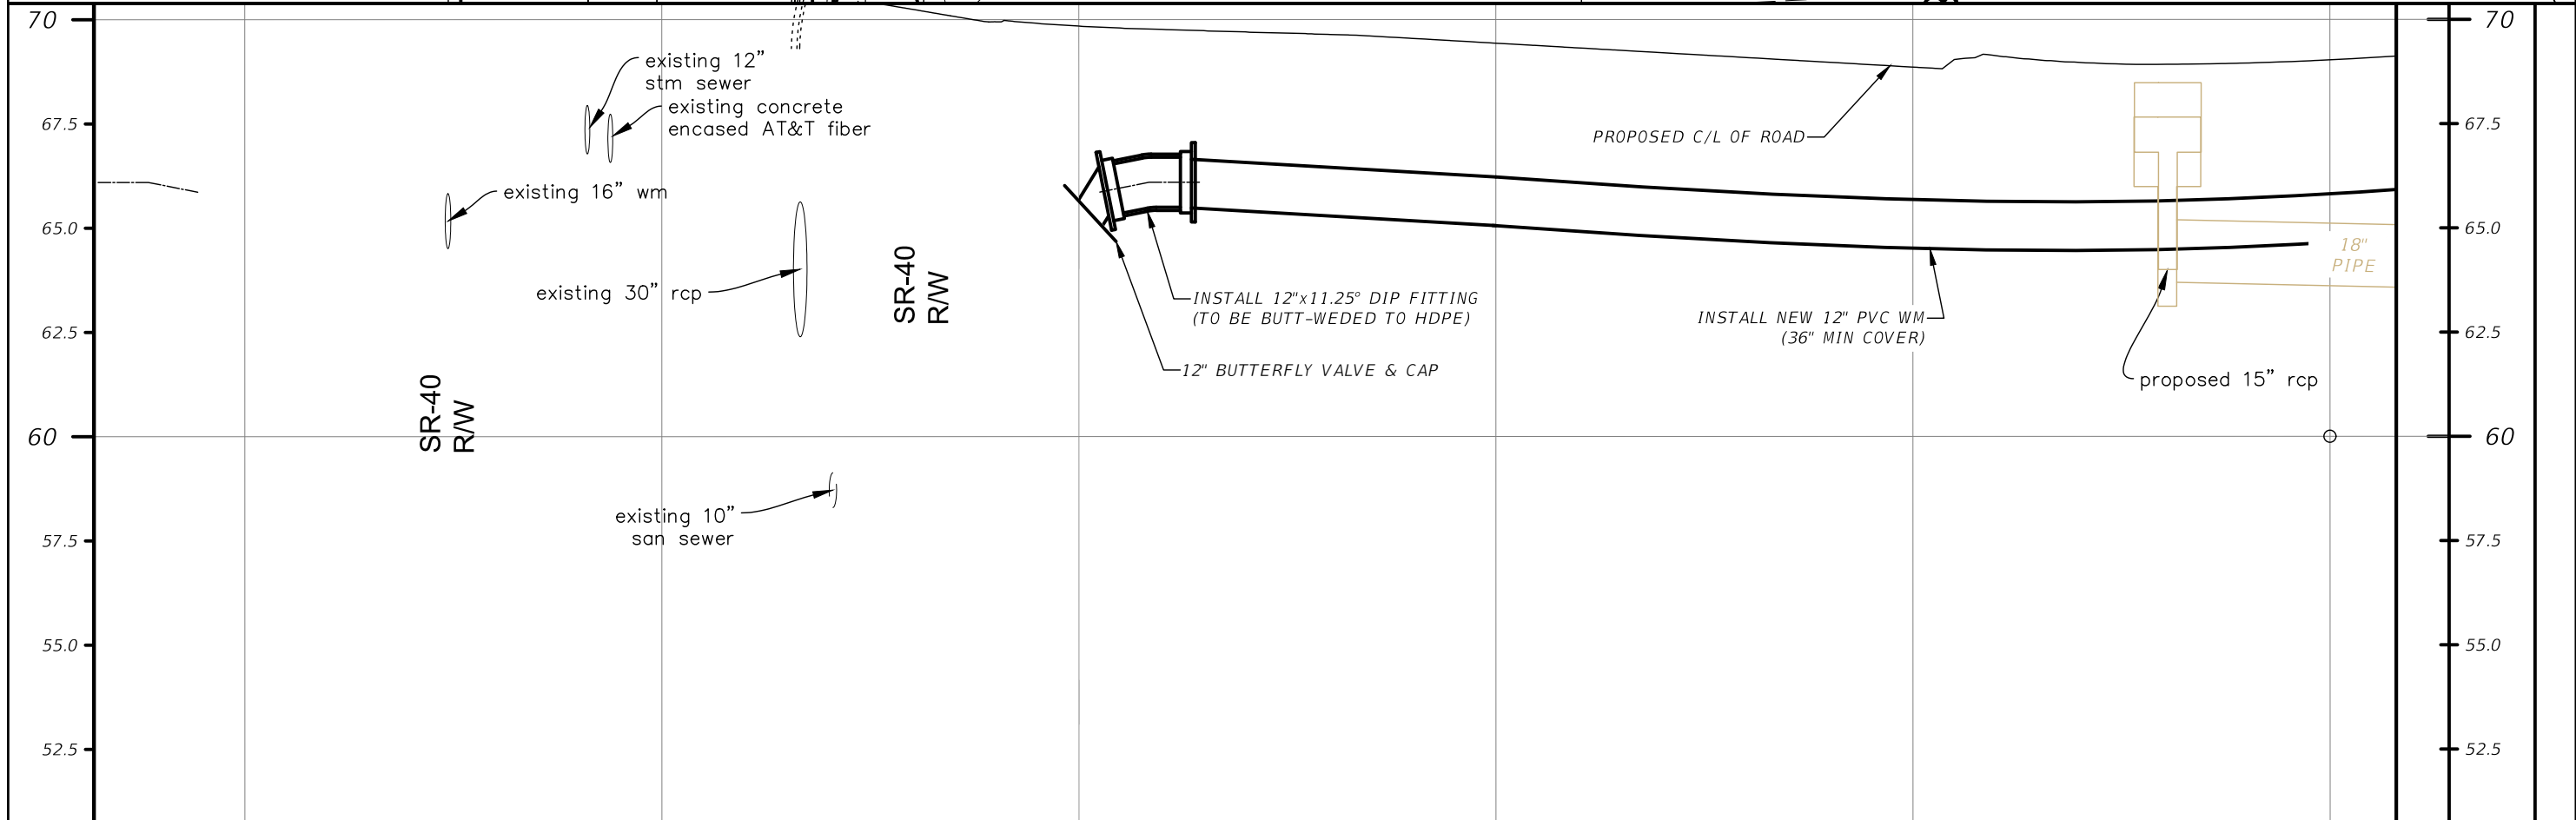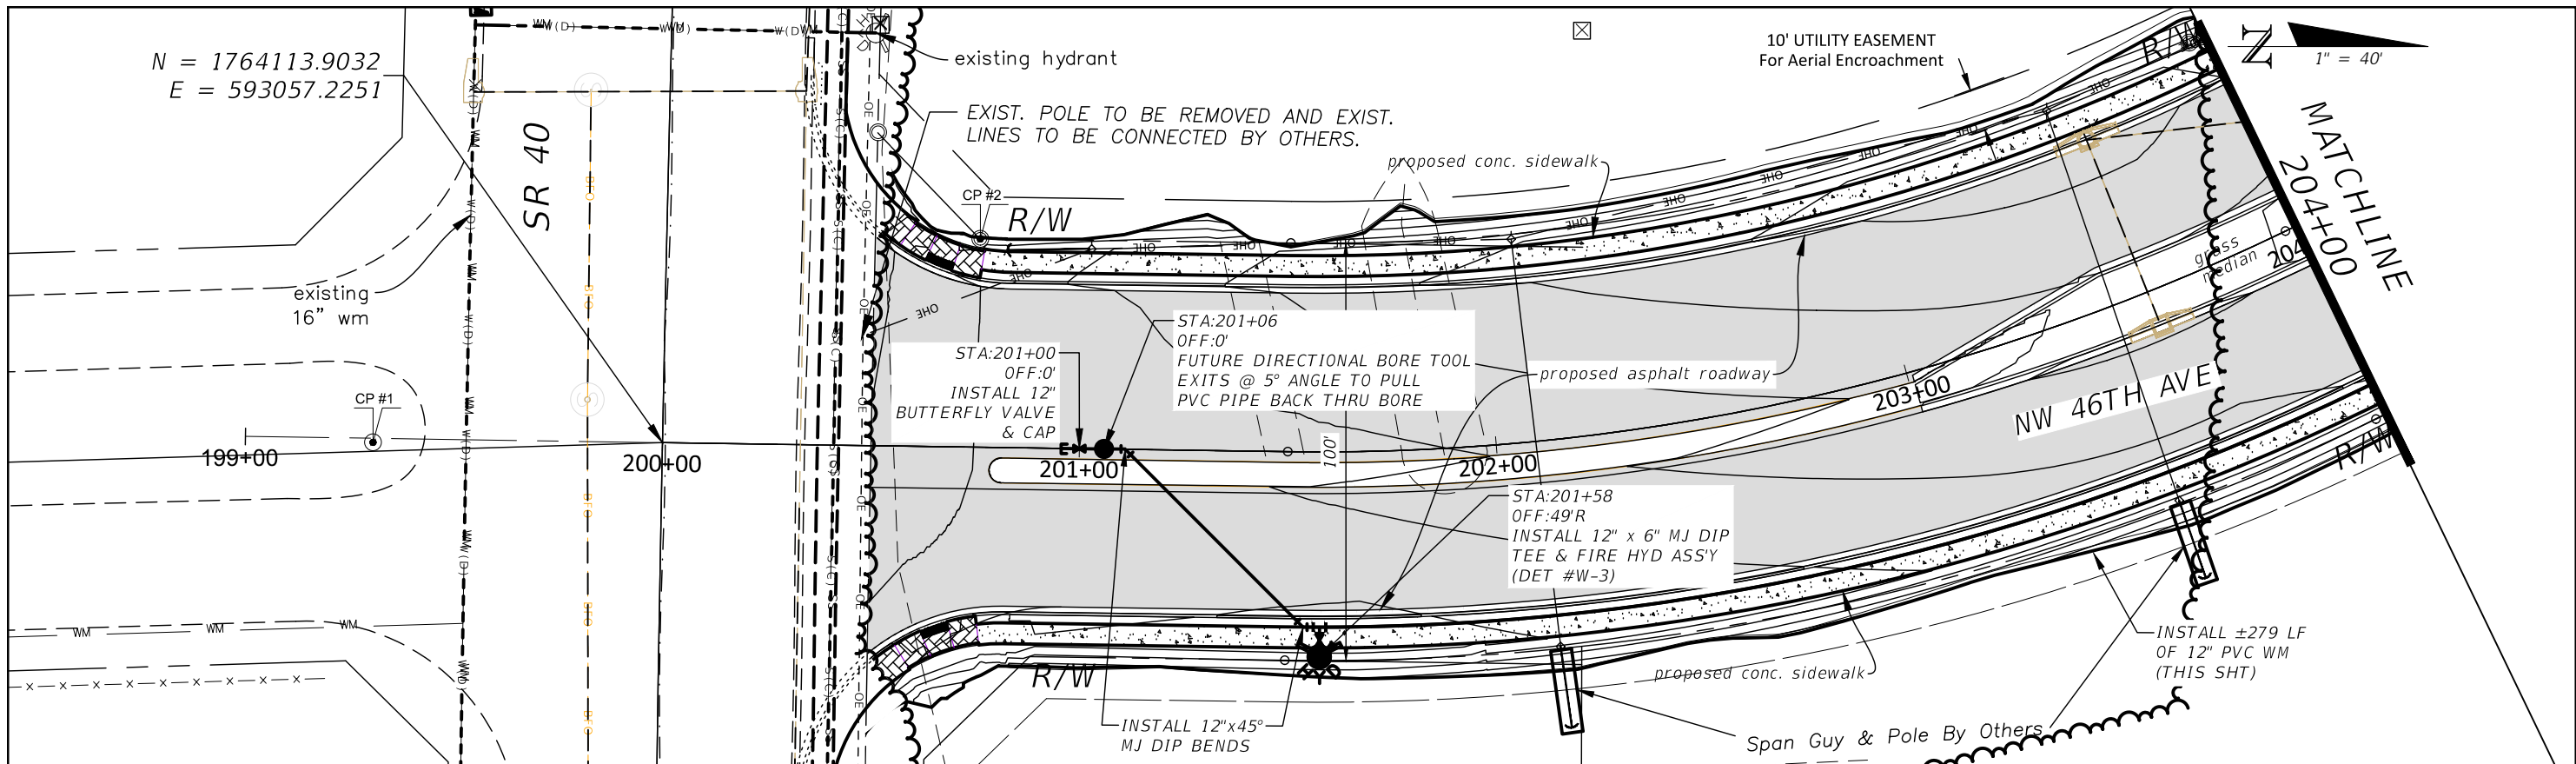N
1" = 40'





REVISIONS			
DATE	DESCRIPTION	DATE	DESCRIPTION

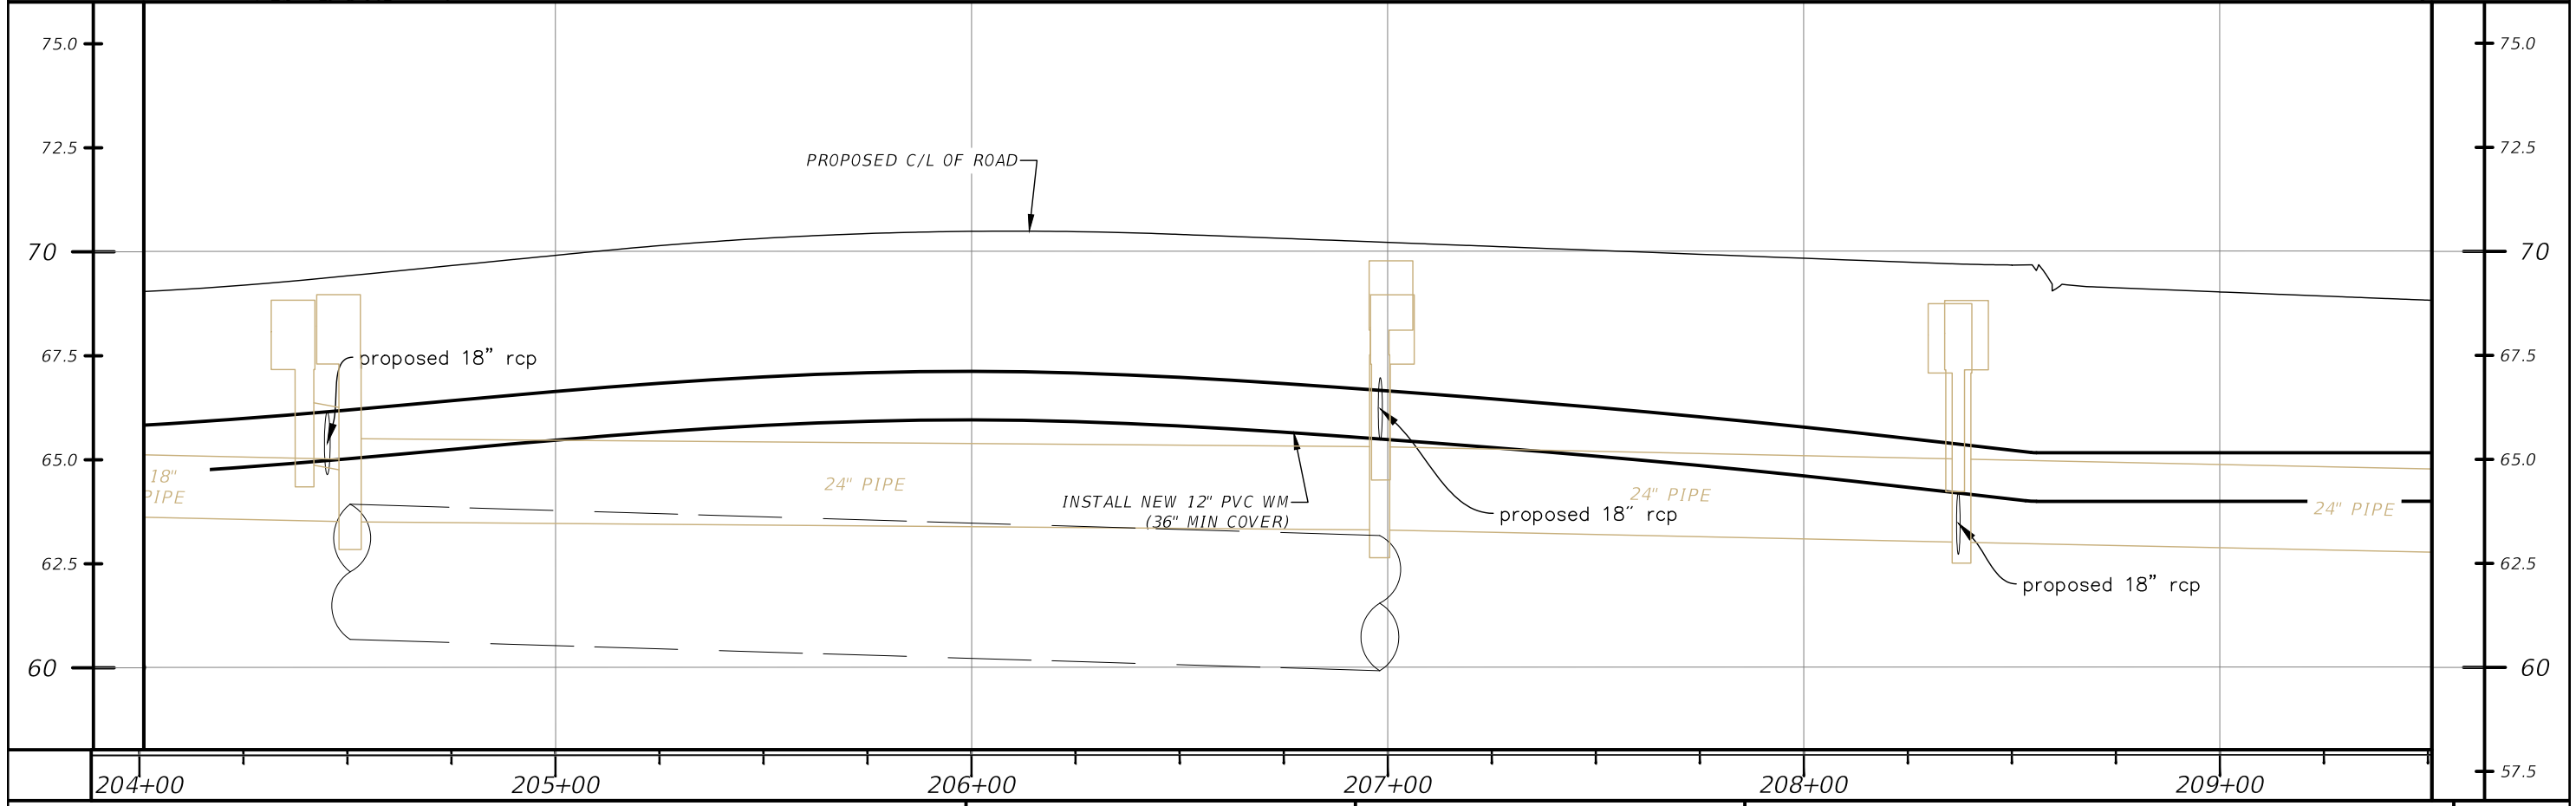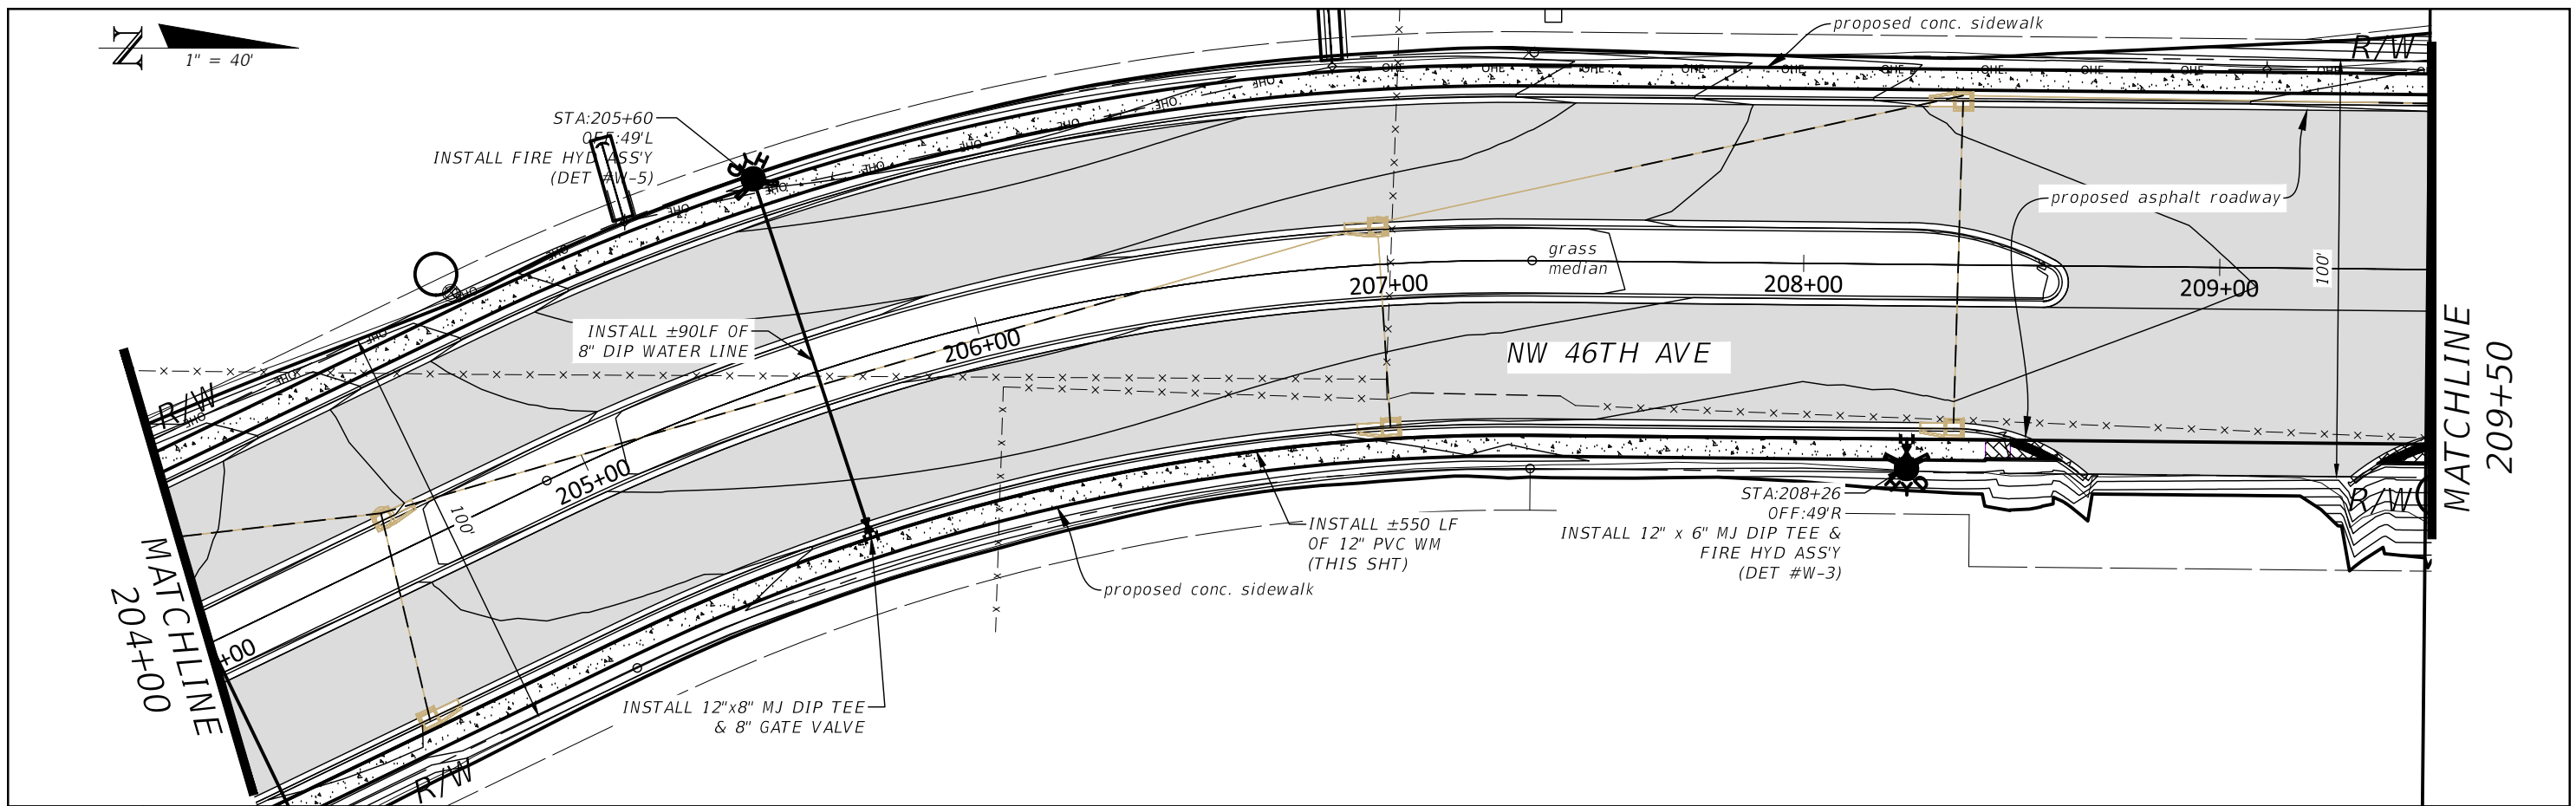HECTOR A. COLON, PE
P.E. LICENSE NUMBER 84007
CITY OF OCALA, FLORIDA
1805 NE 30TH AVENUE
OCALA, FLORIDA 34470





PREPARED BY
OCALA
CITY ENGINEER'S OFFICE

PROJECT NO. ---
PROJECT NAME: NW 44TH AVENUE EXTENSION PHASE 2
UTILITY PLAN AND PROFILE
(2)

SHEET NO.
59

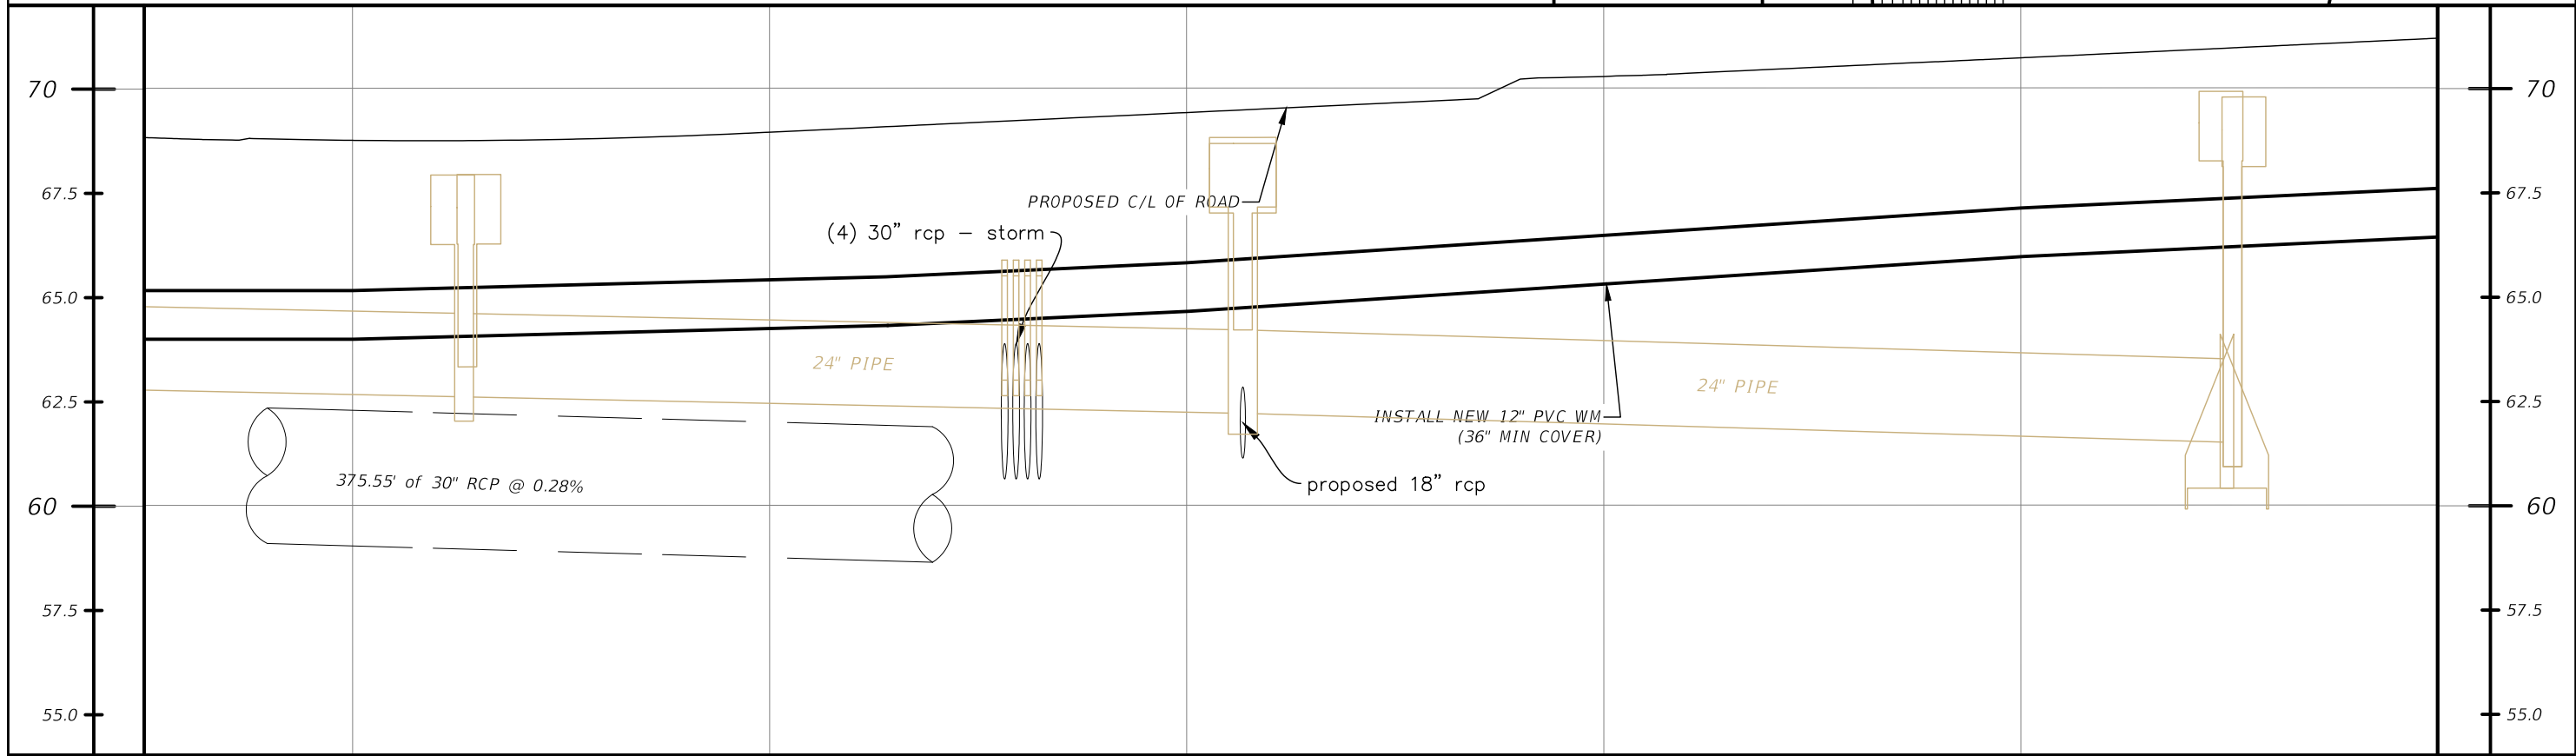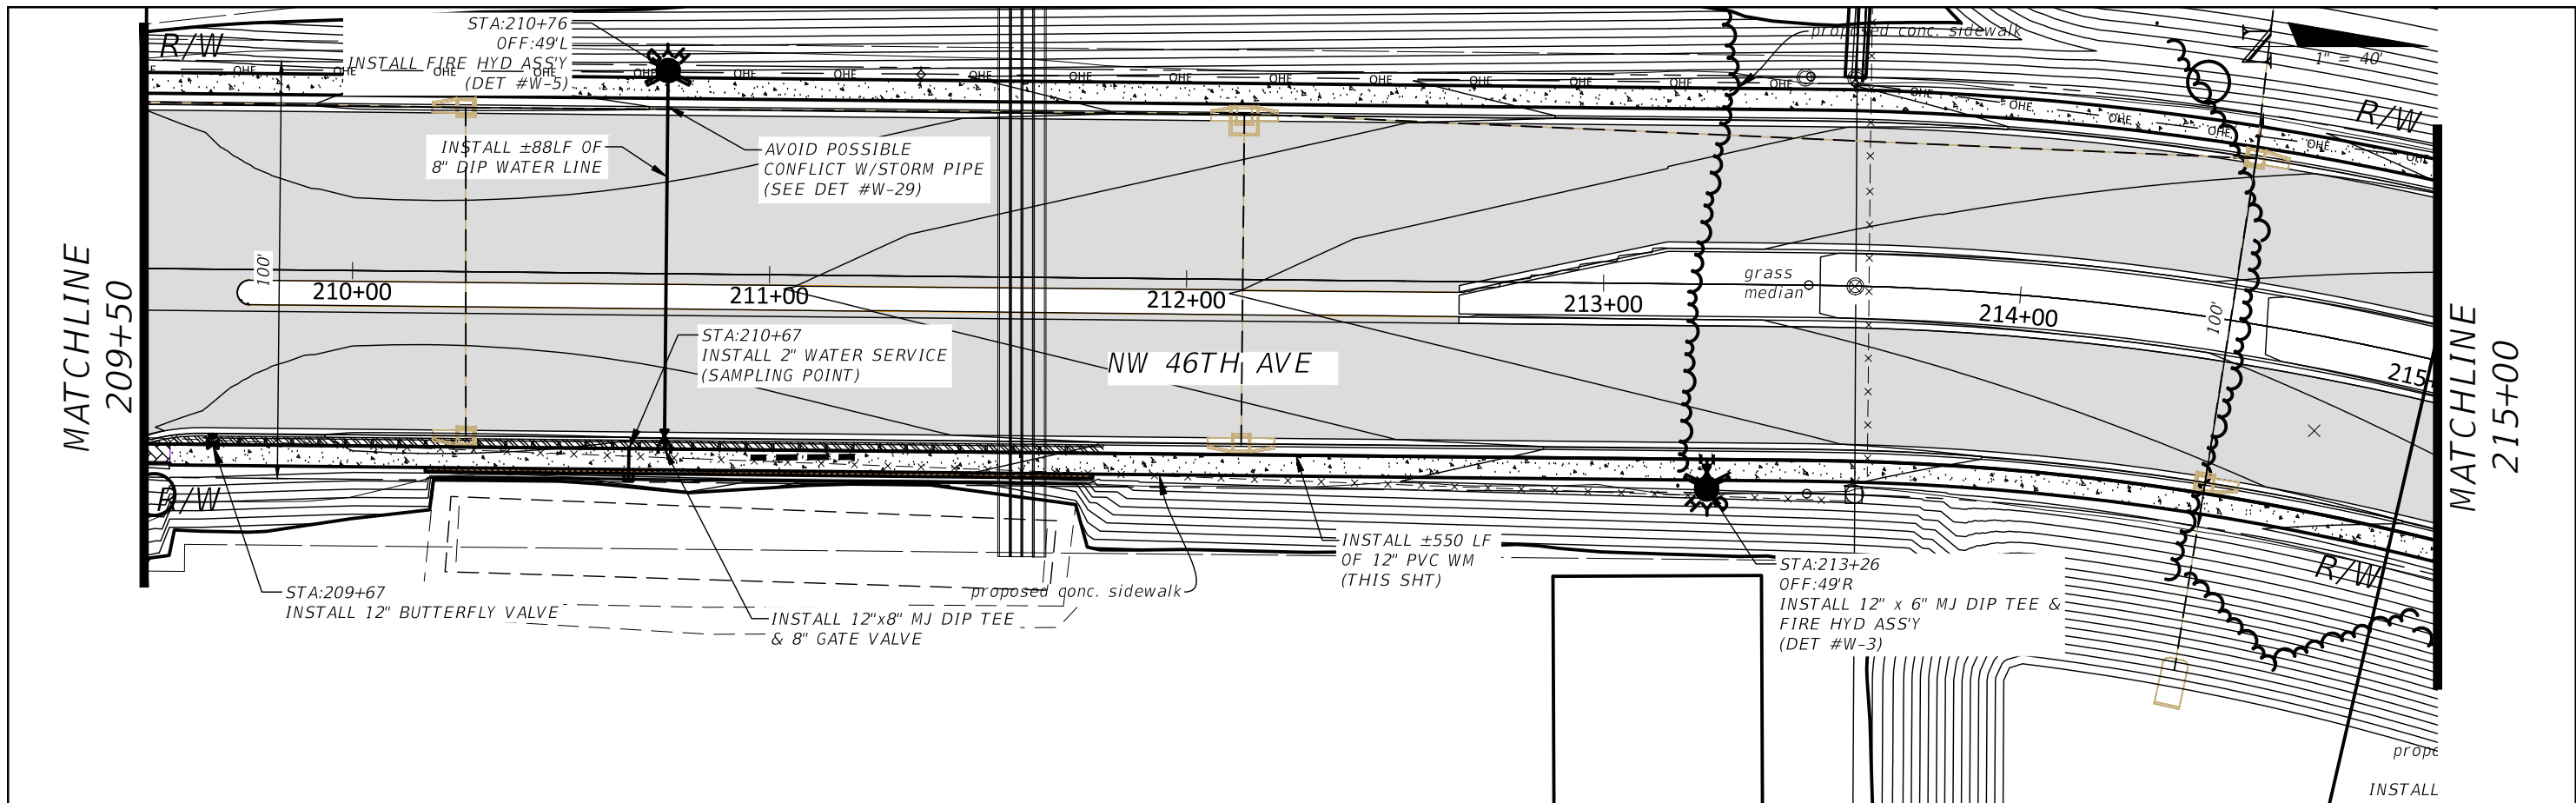



REVISIONS				HECTOR A. COLON, PE P.E. LICENSE NUMBER 84007 CITY OF OCALA, FLORIDA 1805 NE 30TH AVENUE OCALA, FLORIDA 34470	PREPARED BY OCALA CITY ENGINEER'S OFFICE	PROJECT NO. --- PROJECT NAME: NW 44TH AVENUE EXTENSION PHASE 2 UTILITY PLAN AND PROFILE (5)	SHEET NO. 60
DATE	DESCRIPTION	DATE	DESCRIPTION				

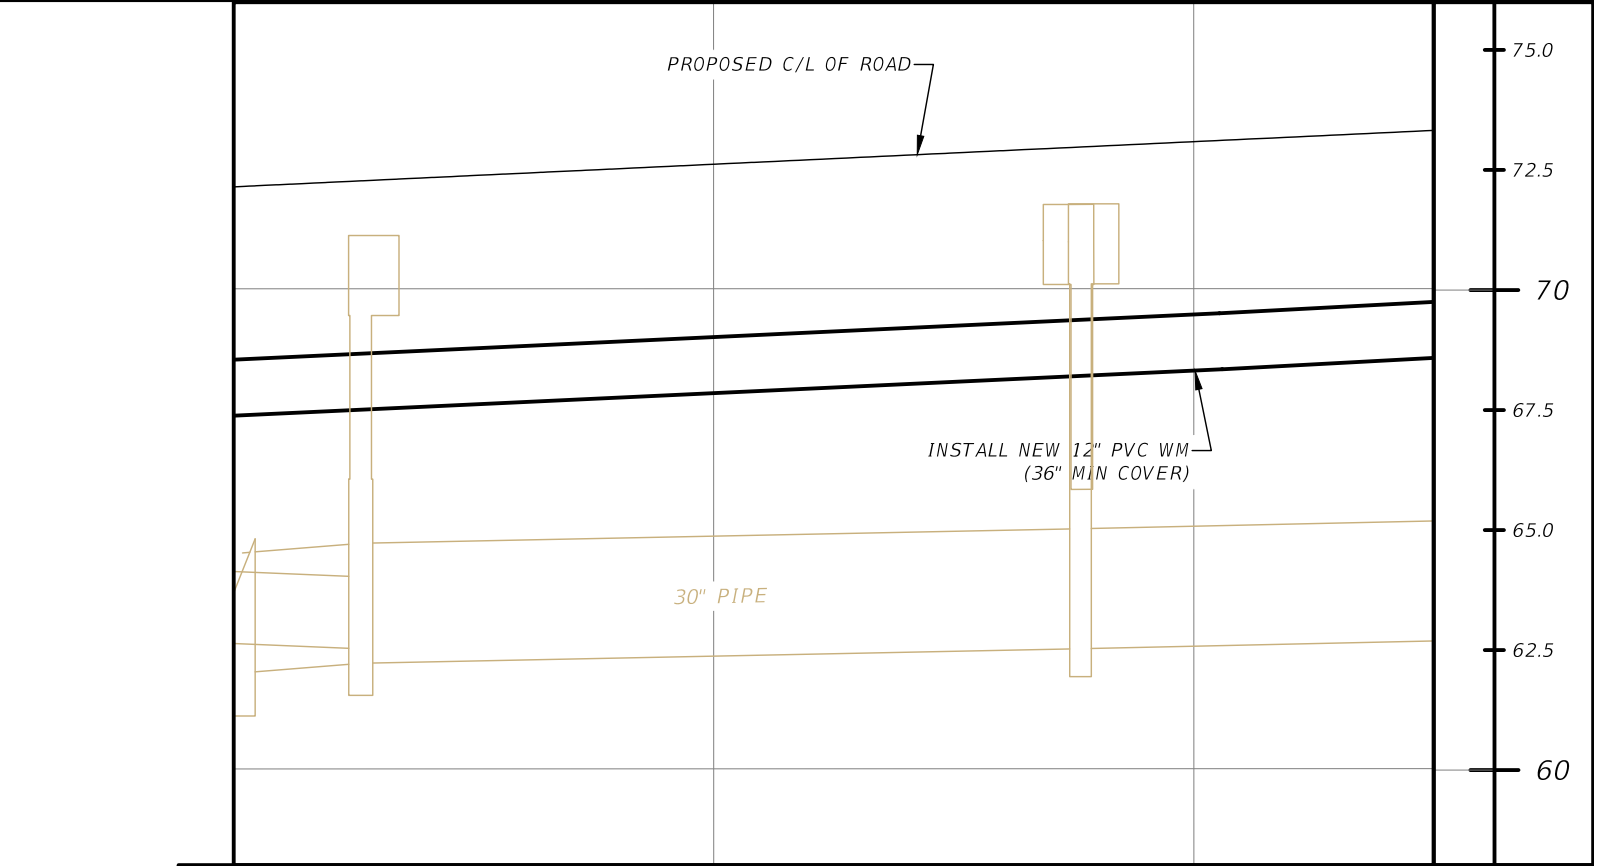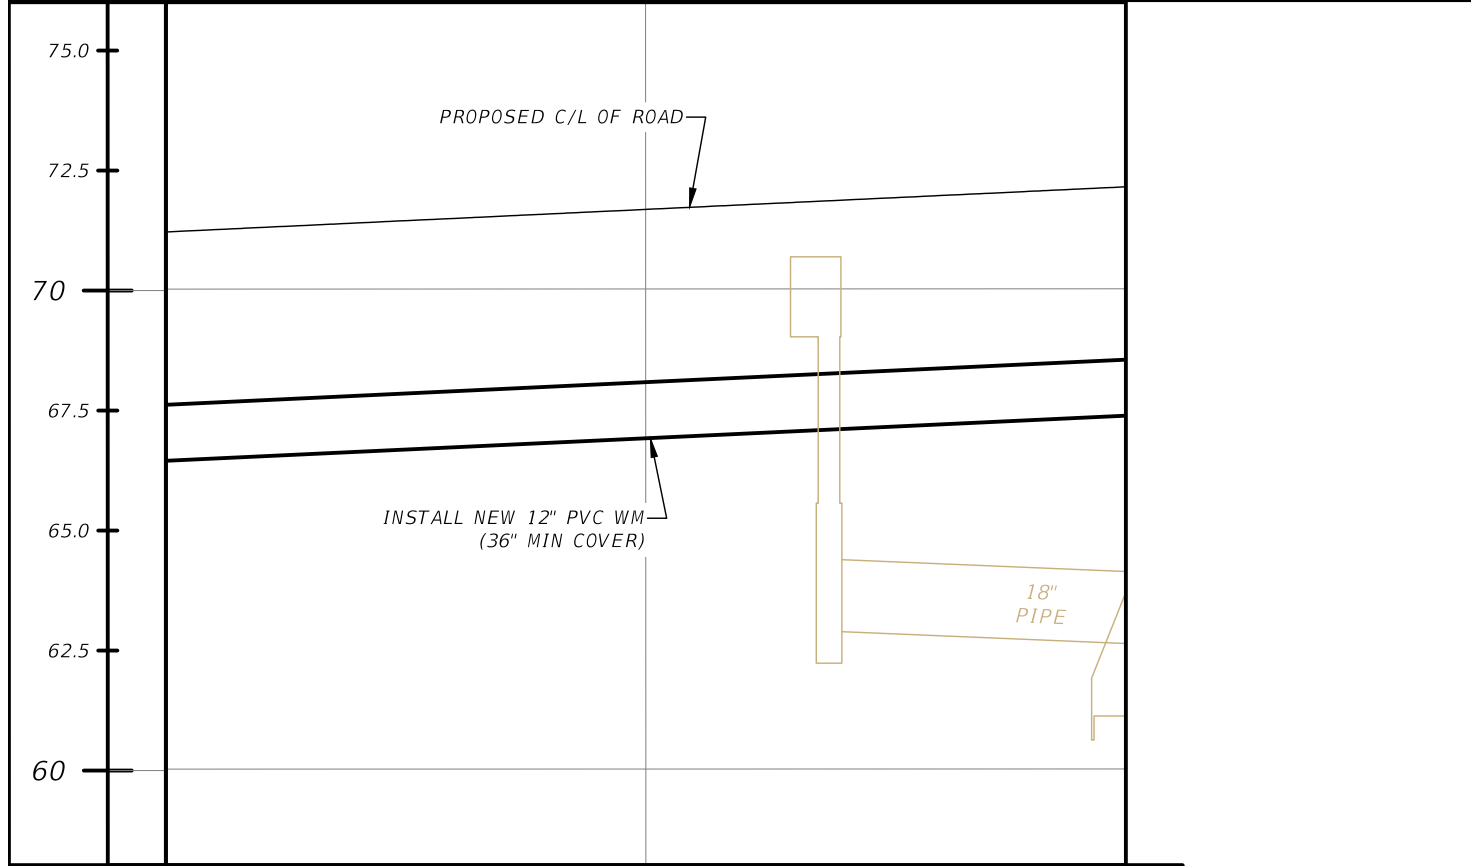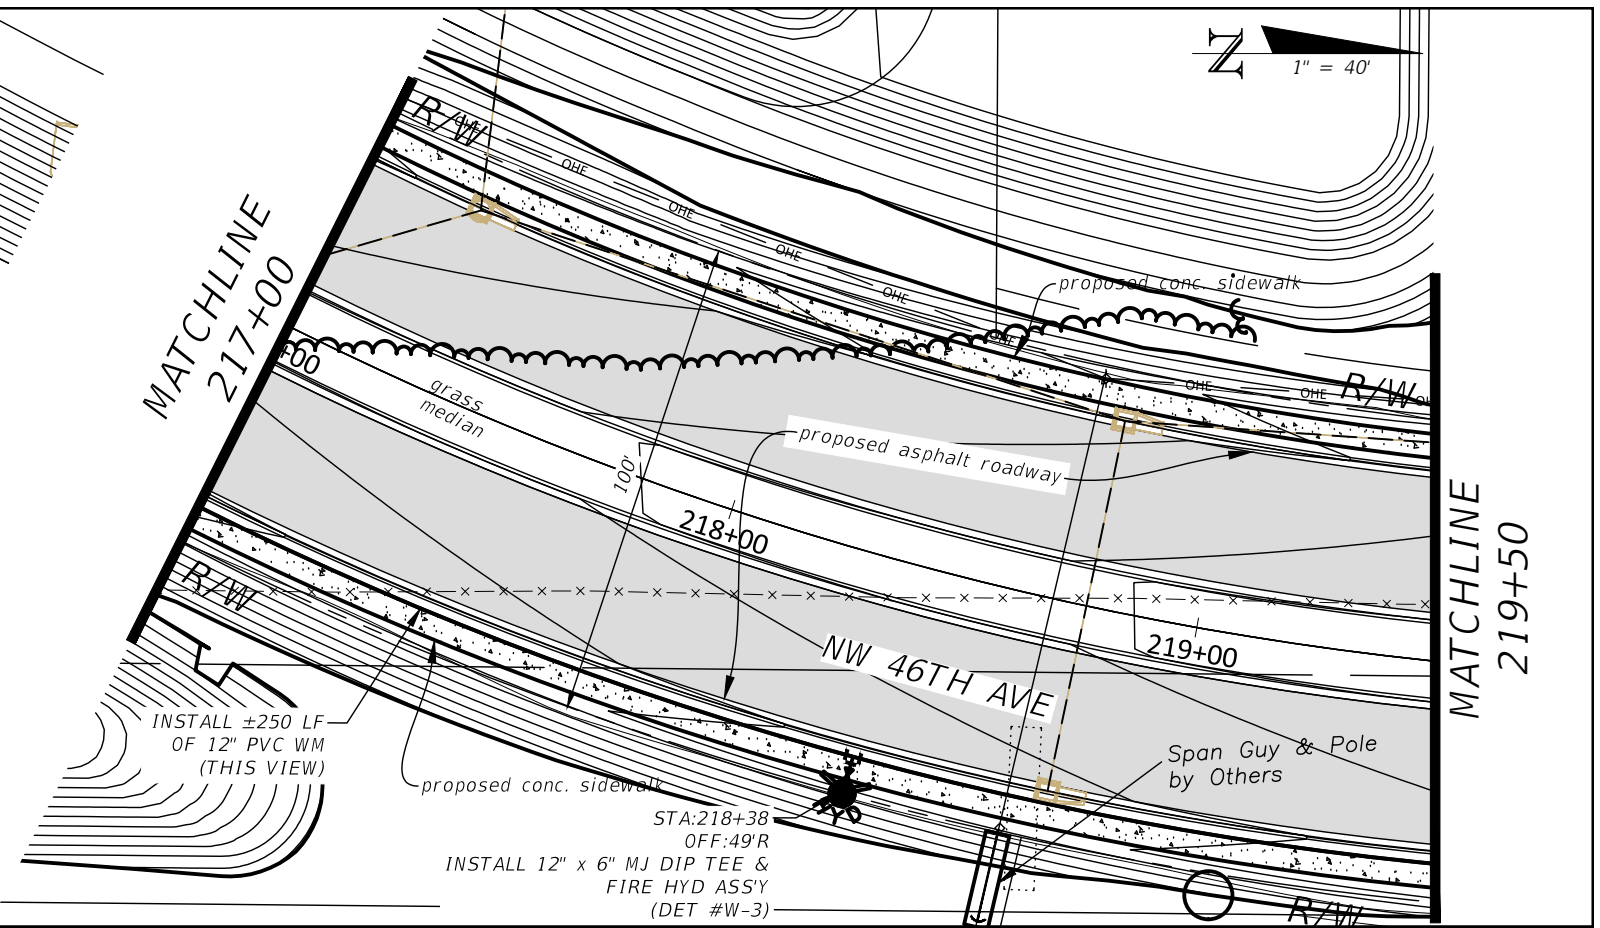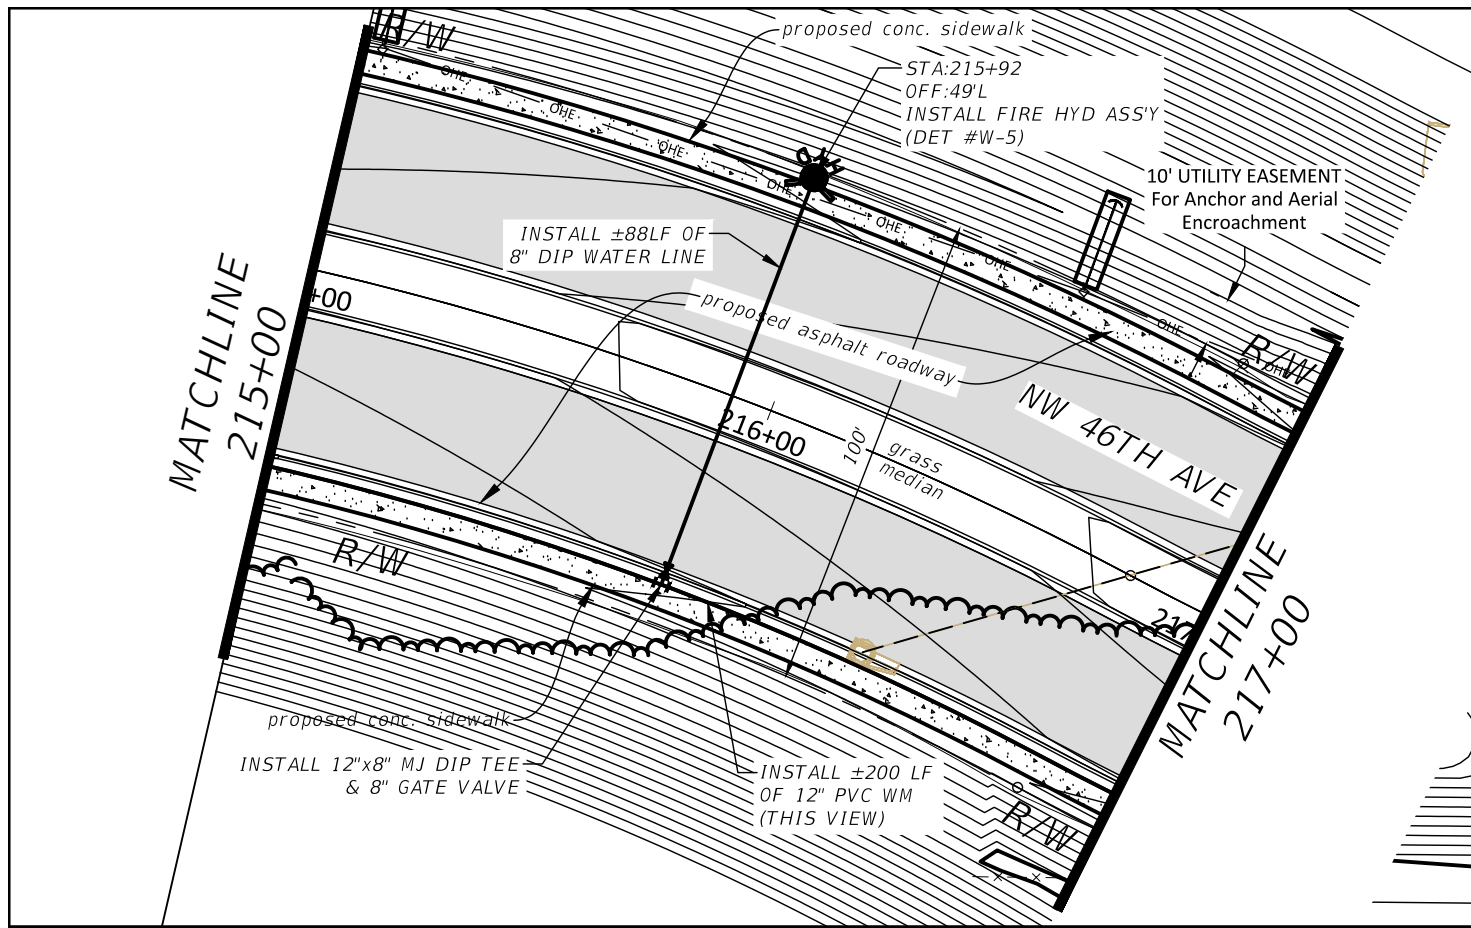

REVISIONS			
DATE	DESCRIPTION	DATE	DESCRIPTION

HECTOR A. COLON, PE
 P.E. LICENSE NUMBER 84007
 CITY OF OCALA, FLORIDA
 1805 NE 30TH AVENUE
 OCALA, FLORIDA 34470

PREPARED BY	PROJECT NO. ---	SHEET NO.
OCALA CITY ENGINEER'S OFFICE	PROJECT NAME: NW 44TH AVENUE EXTENSION PHASE 2 <i>UTILITY PLAN AND PROFILE</i> (4)	
Gary Anson	4/6/2023 6:20:43 PM	61

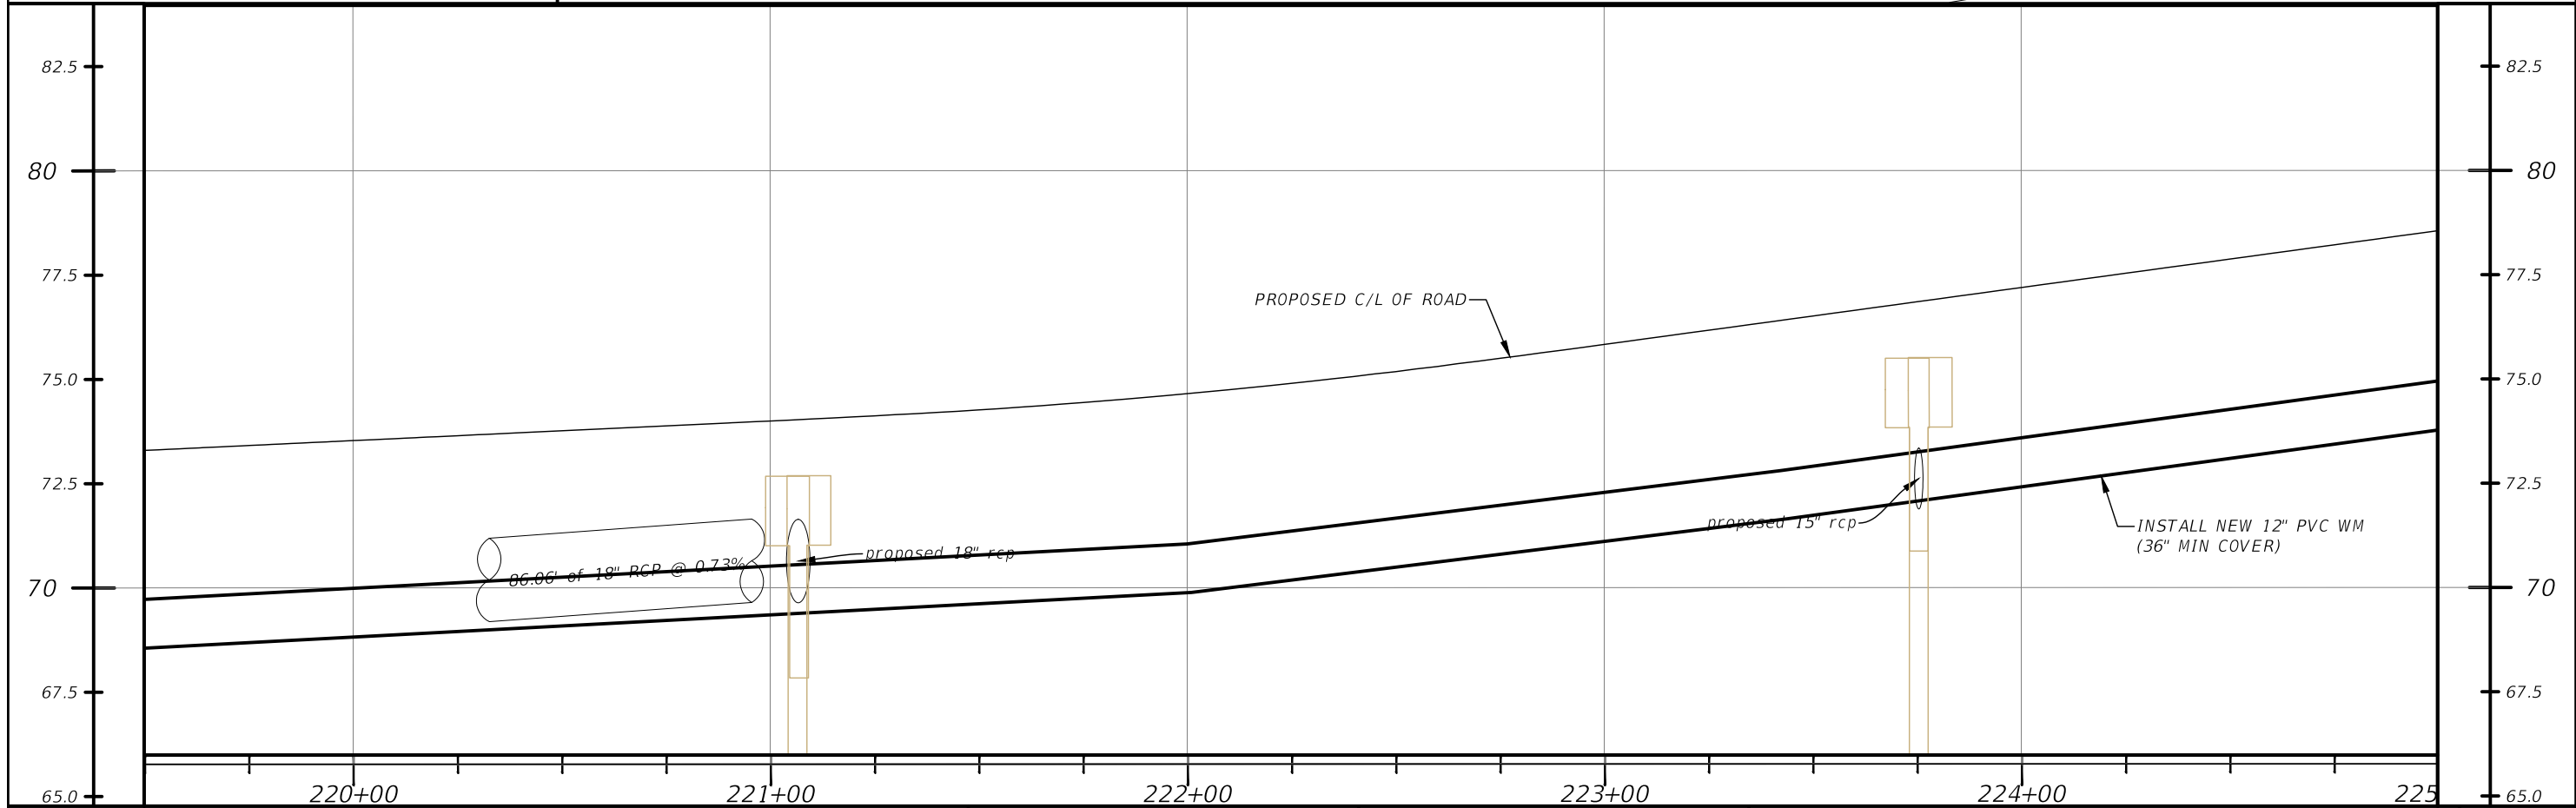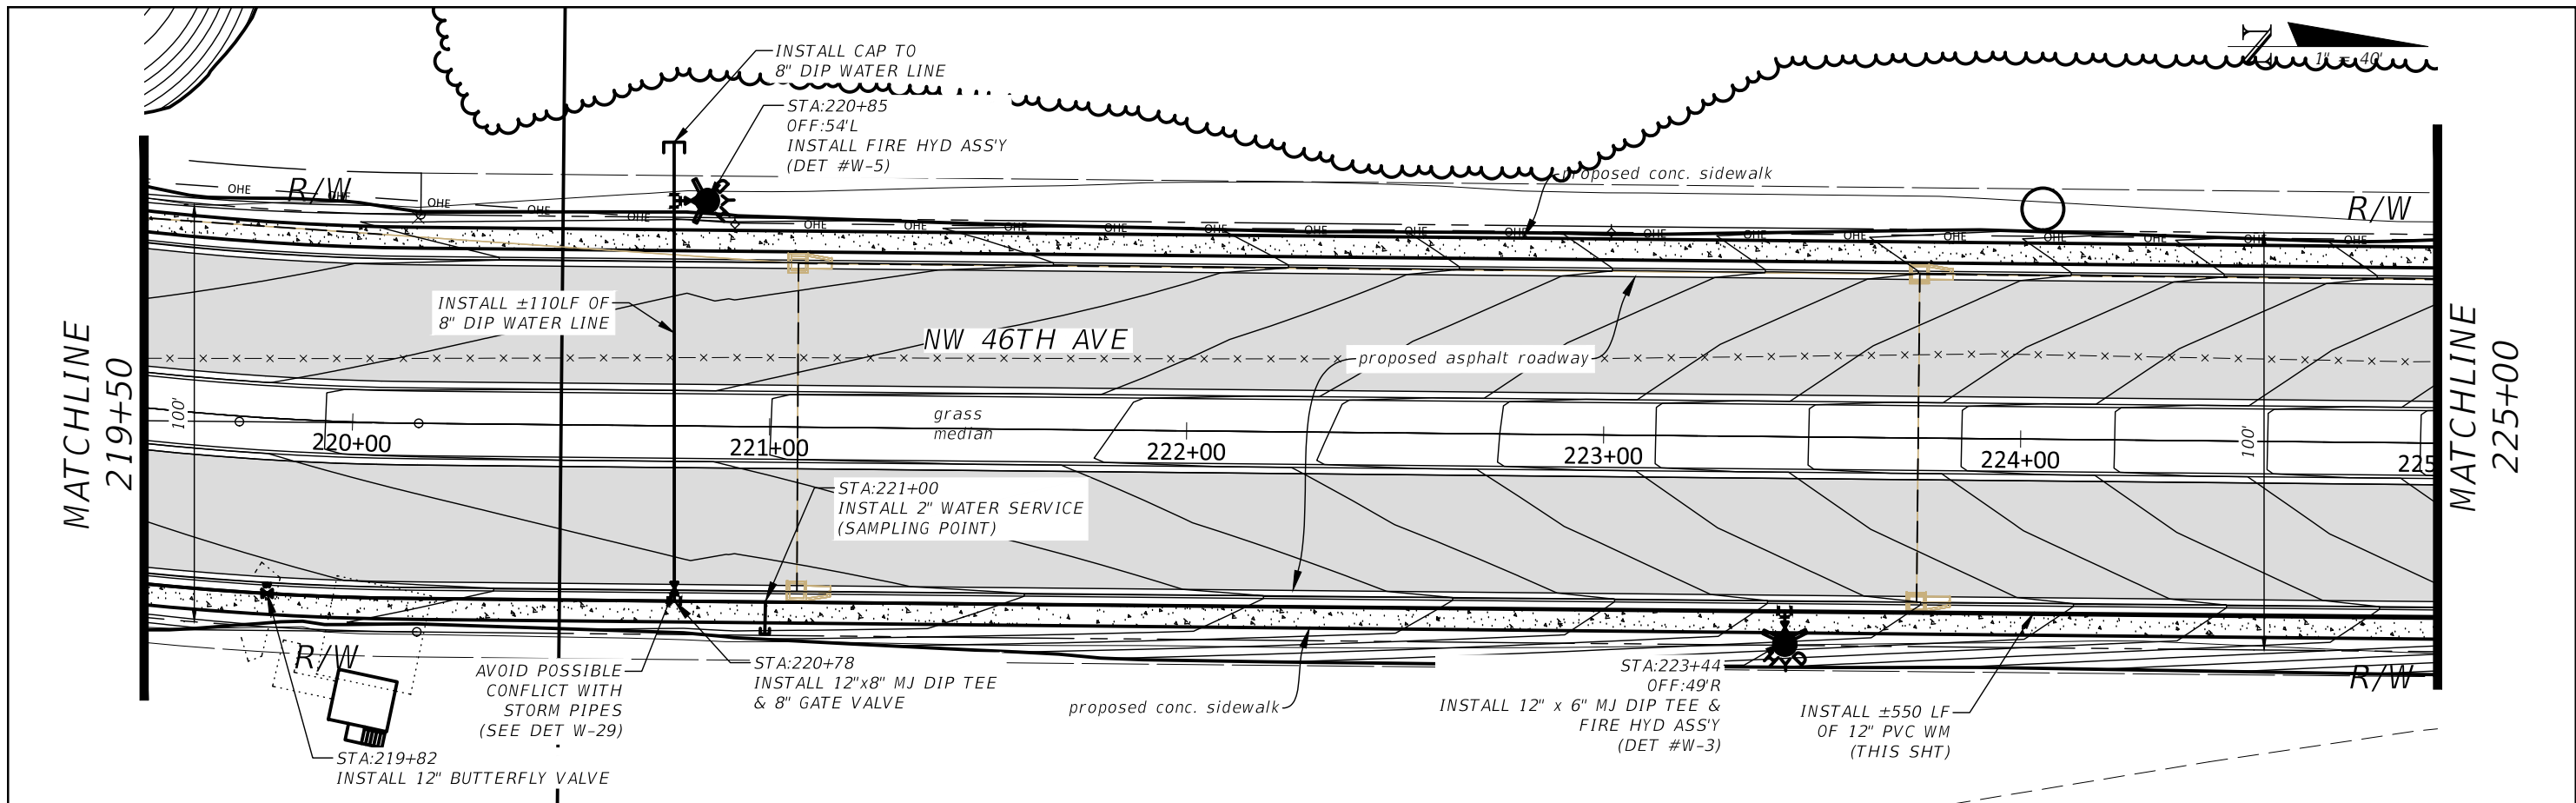

REVISIONS			
DATE	DESCRIPTION	DATE	DESCRIPTION




HECTOR A. COLON, PE
P.E. LICENSE NUMBER 84007
CITY OF OCALA, FLORIDA
1805 NE 30TH AVENUE
OCALA, FLORIDA 34470

PREPARED BY

Gary Anson

PROJECT NO. ---
PROJECT NAME: NW 44TH AVENUE EXTENSION PHASE 2
UTILITY PLAN AND PROFILE
(5)

SHEET NO.
62

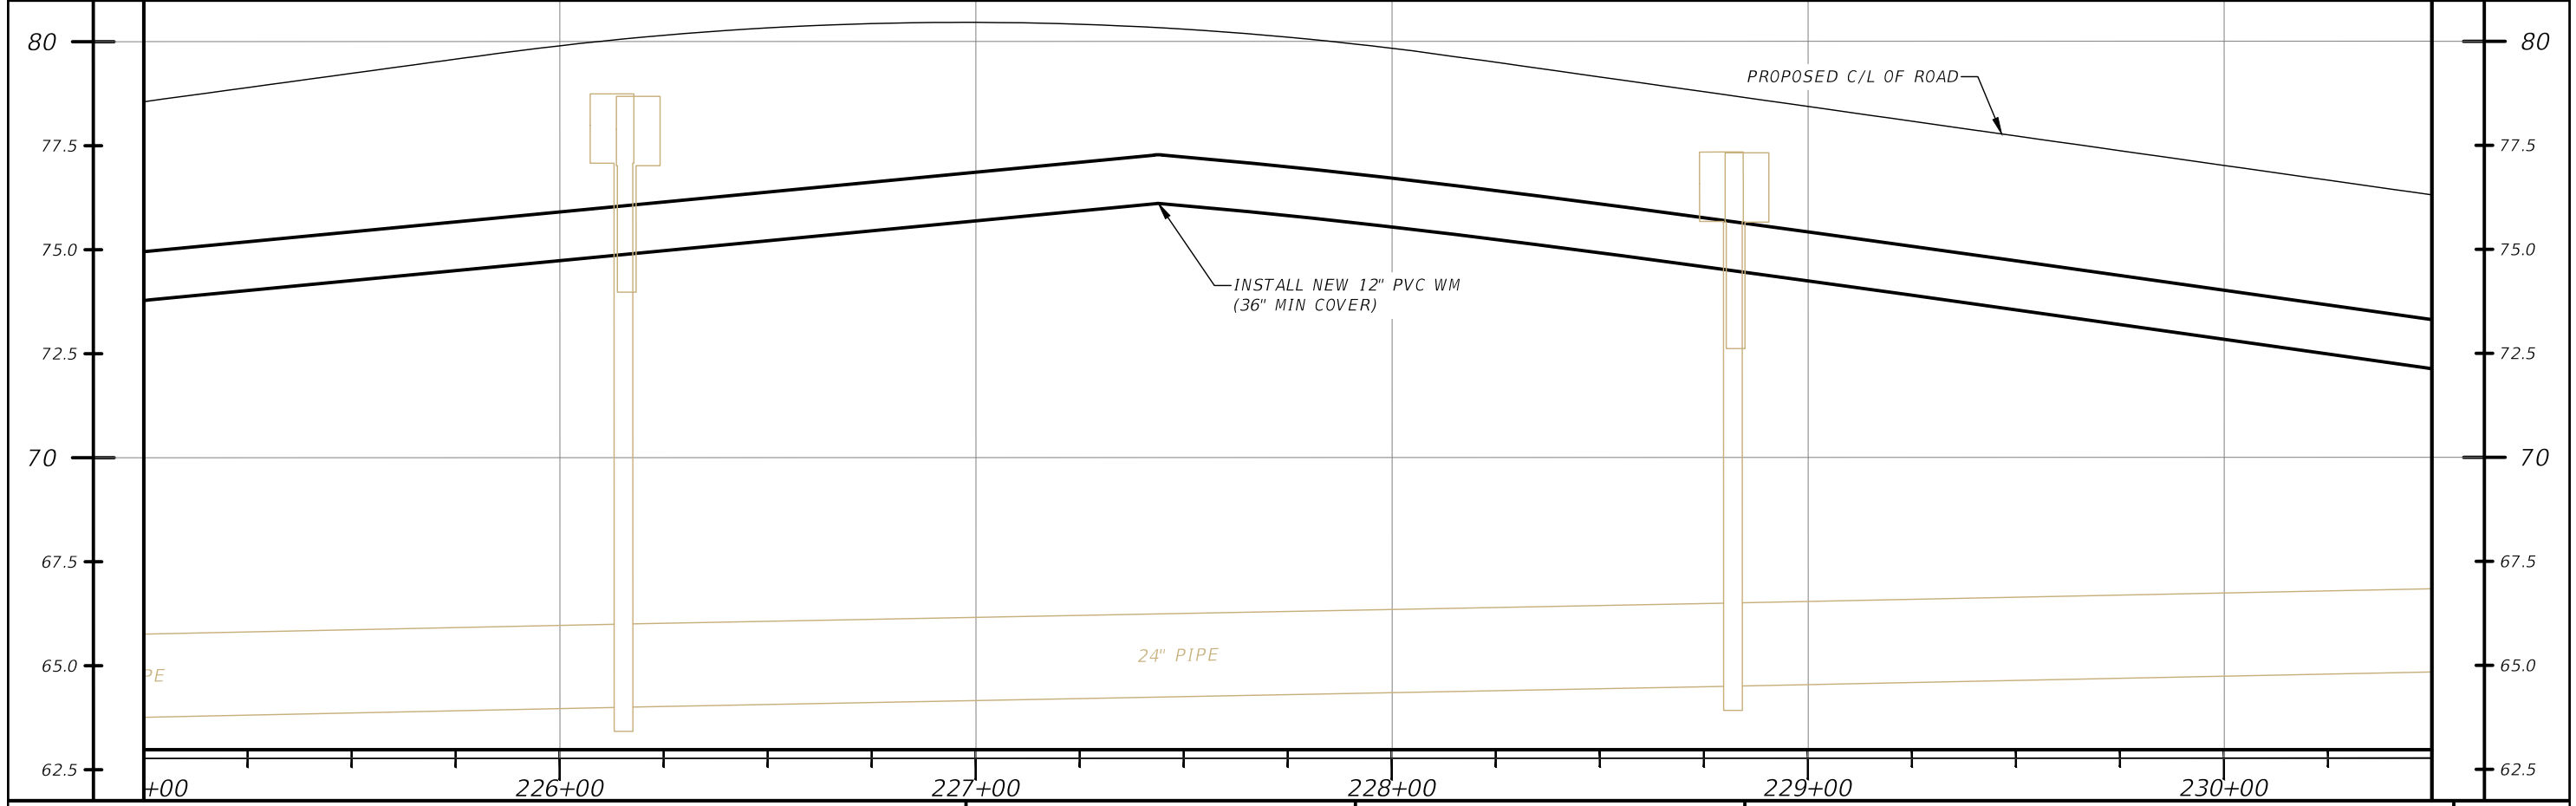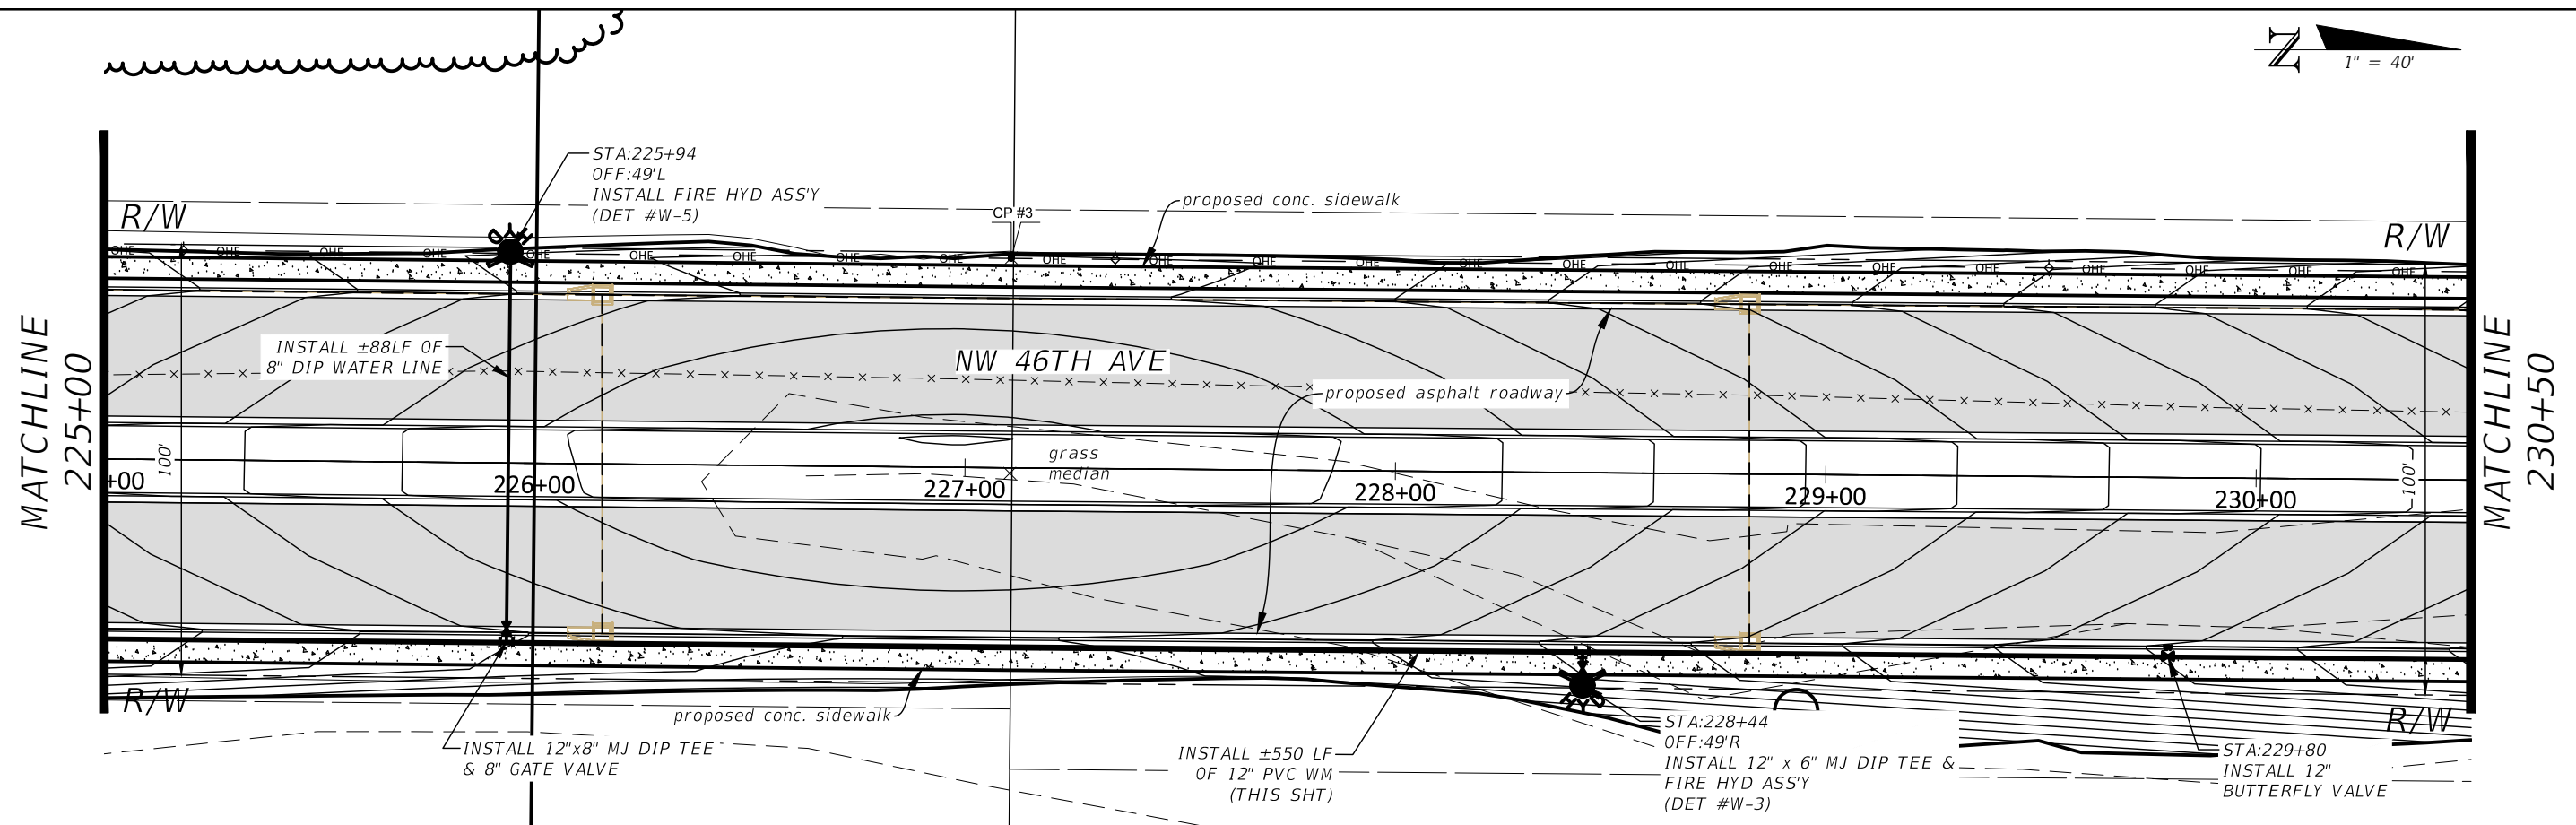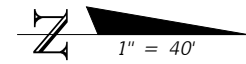

REVISIONS			
DATE	DESCRIPTION	DATE	DESCRIPTION


HECTOR A. COLON, PE
 P.E. LICENSE NUMBER 84007
 CITY OF OCALA, FLORIDA
 1805 NE 30TH AVENUE
 OCALA, FLORIDA 34470

PREPARED BY

 Gary Anson



PROJECT NO. ---
 PROJECT NAME: NW 44TH AVENUE EXTENSION PHASE 2
UTILITY PLAN AND PROFILE
 (6)

SHEET NO.
 63

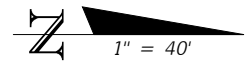

MATCHLINE
230+50

MATCHLINE
236+00

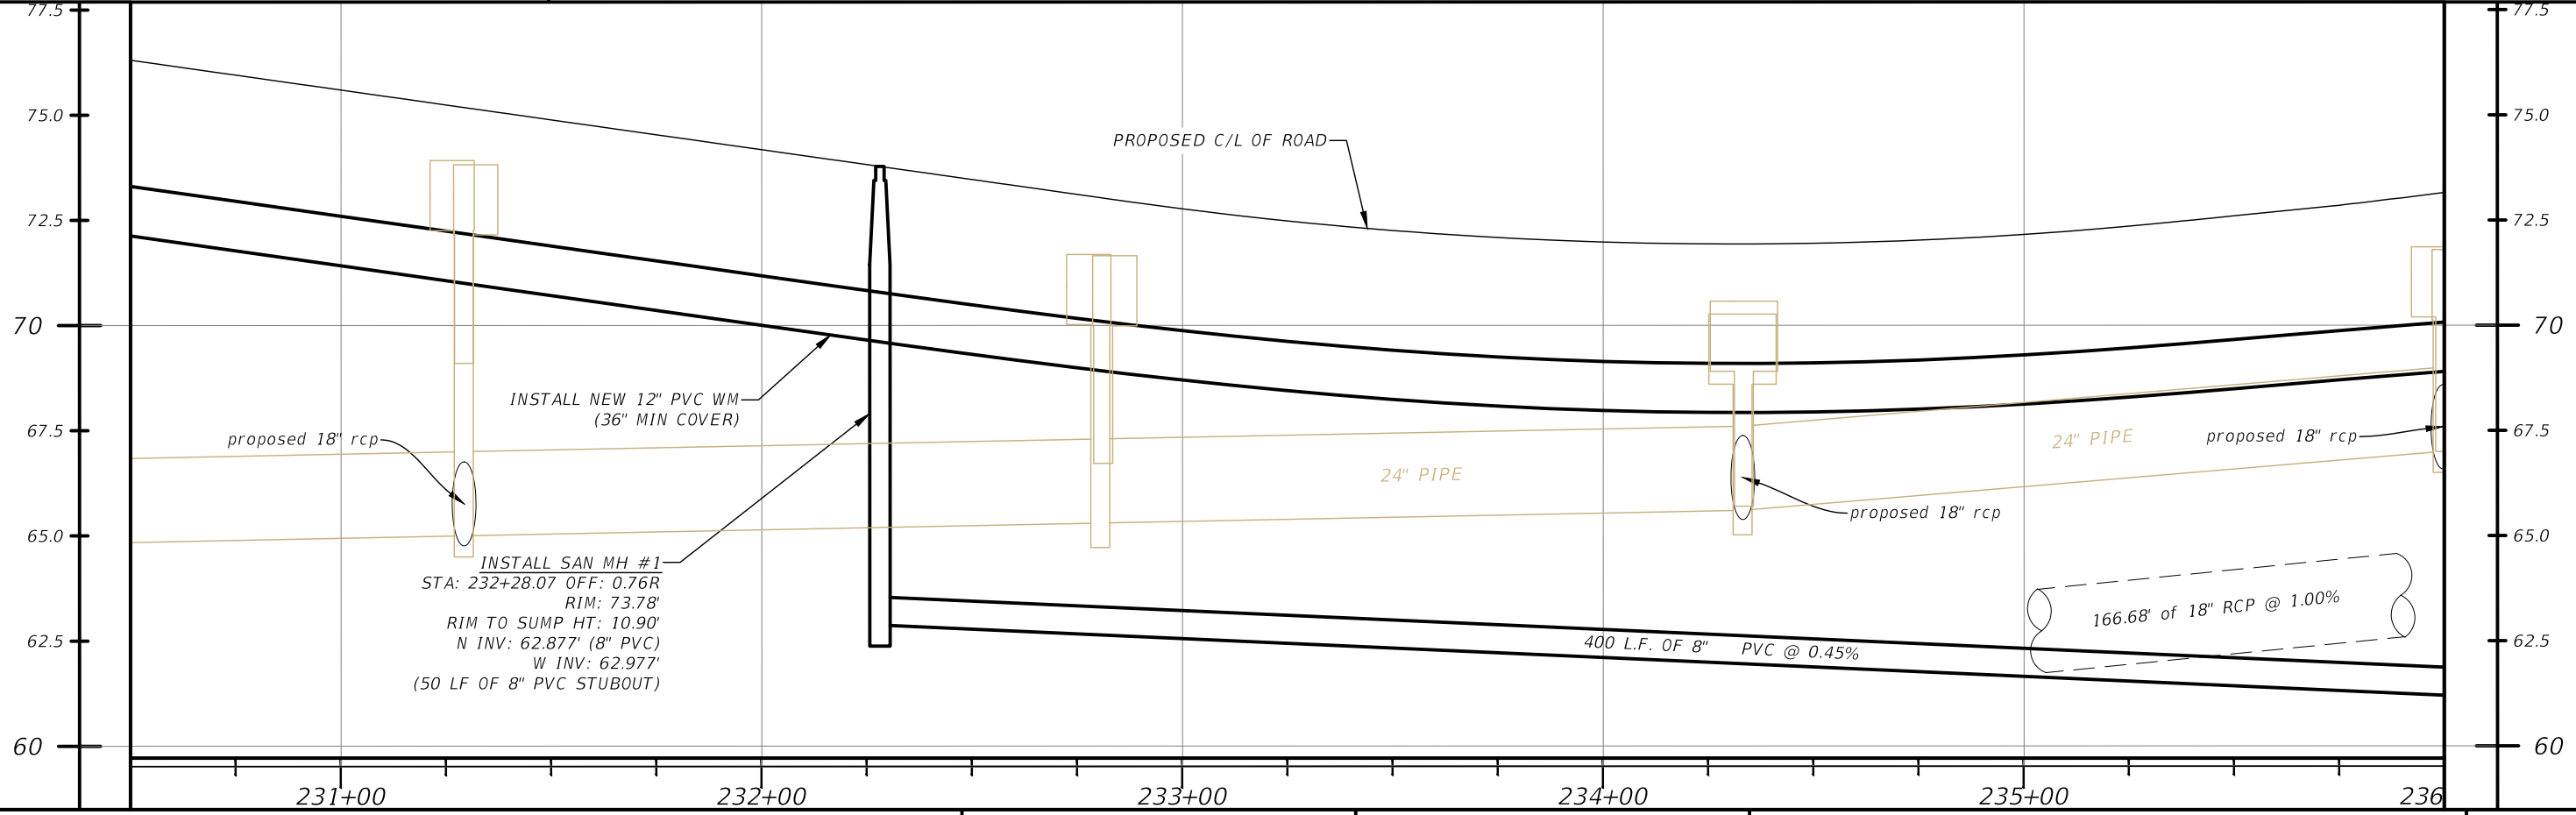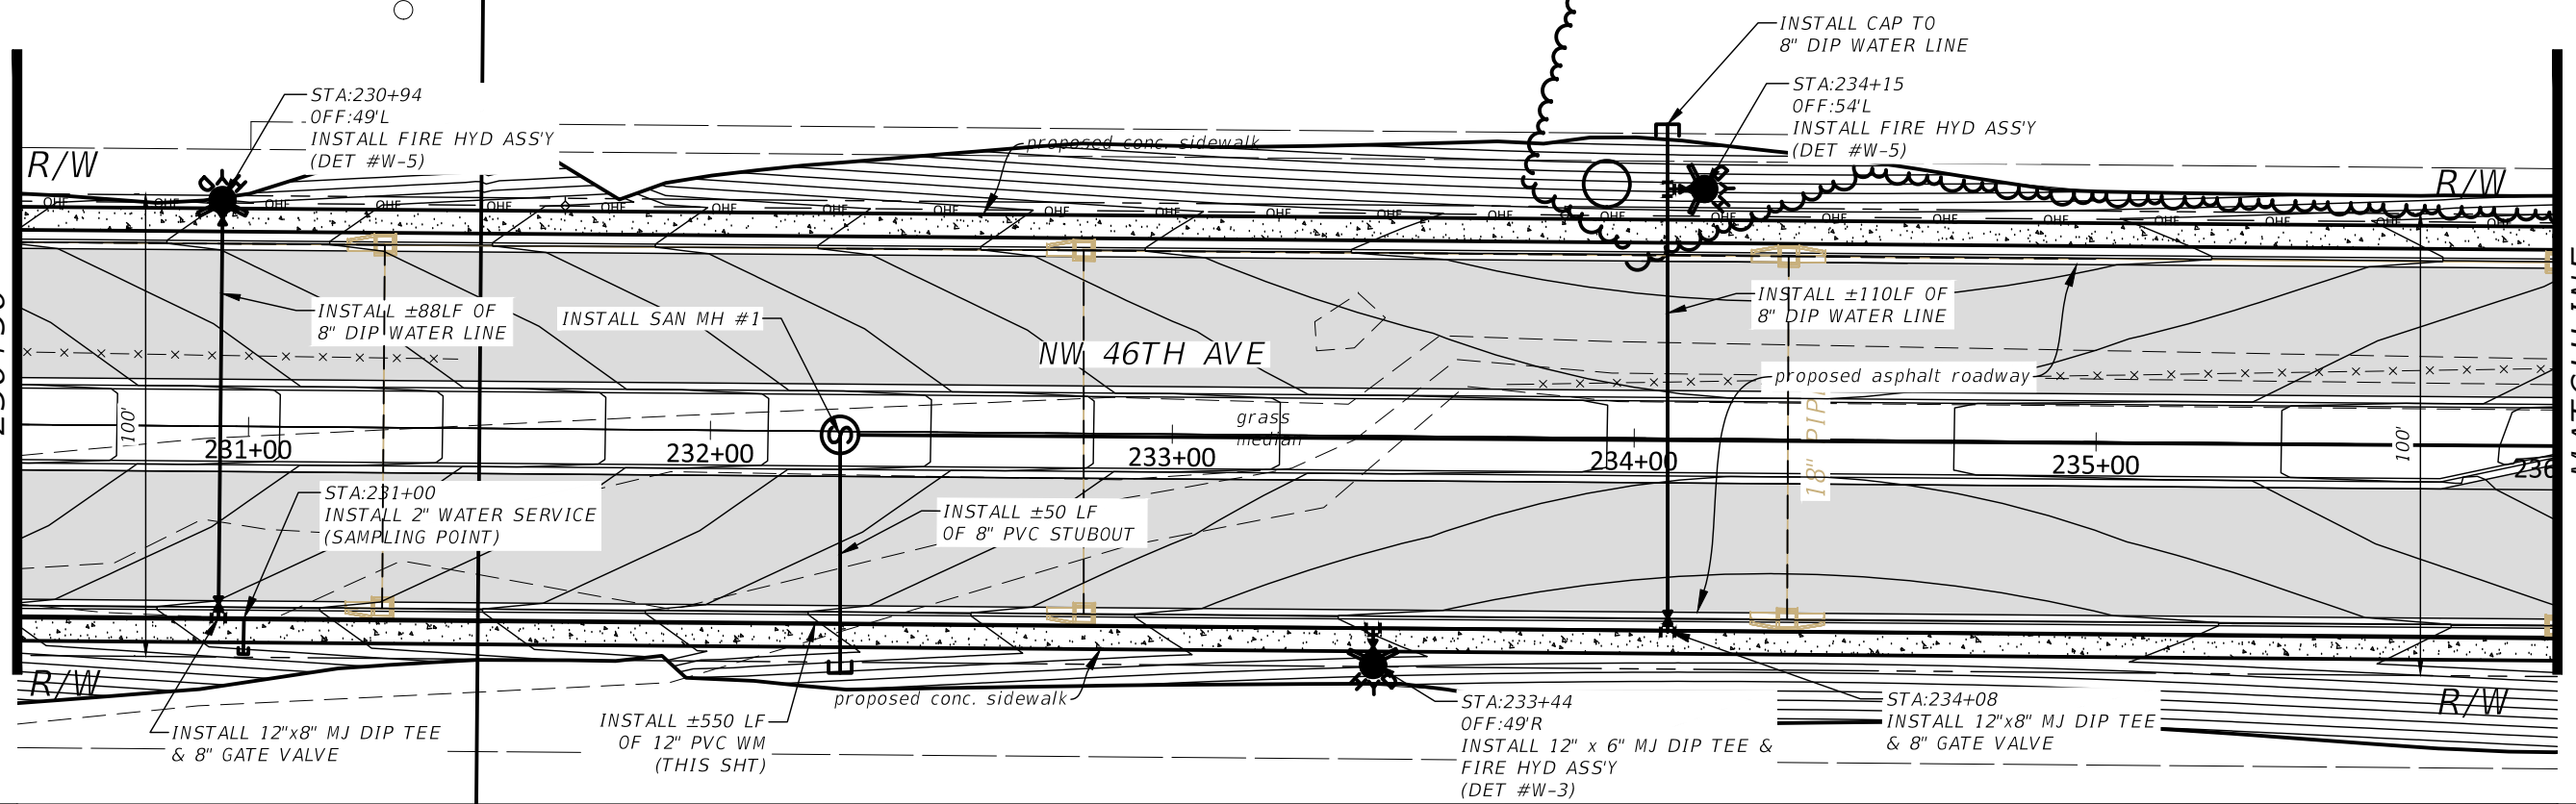

REVISIONS			
DATE	DESCRIPTION	DATE	DESCRIPTION

HECTOR A. COLON, PE
P.E. LICENSE NUMBER 84007
CITY OF OCALA, FLORIDA
1805 NE 30TH AVENUE
OCALA, FLORIDA 34470




PREPARED BY

Gary Anson



PROJECT NO. ---
PROJECT NAME: NW 44TH AVENUE EXTENSION PHASE 2
UTILITY PLAN AND PROFILE
(7)

SHEET NO.
64


MATCHLINE
(SEE SHT 13)

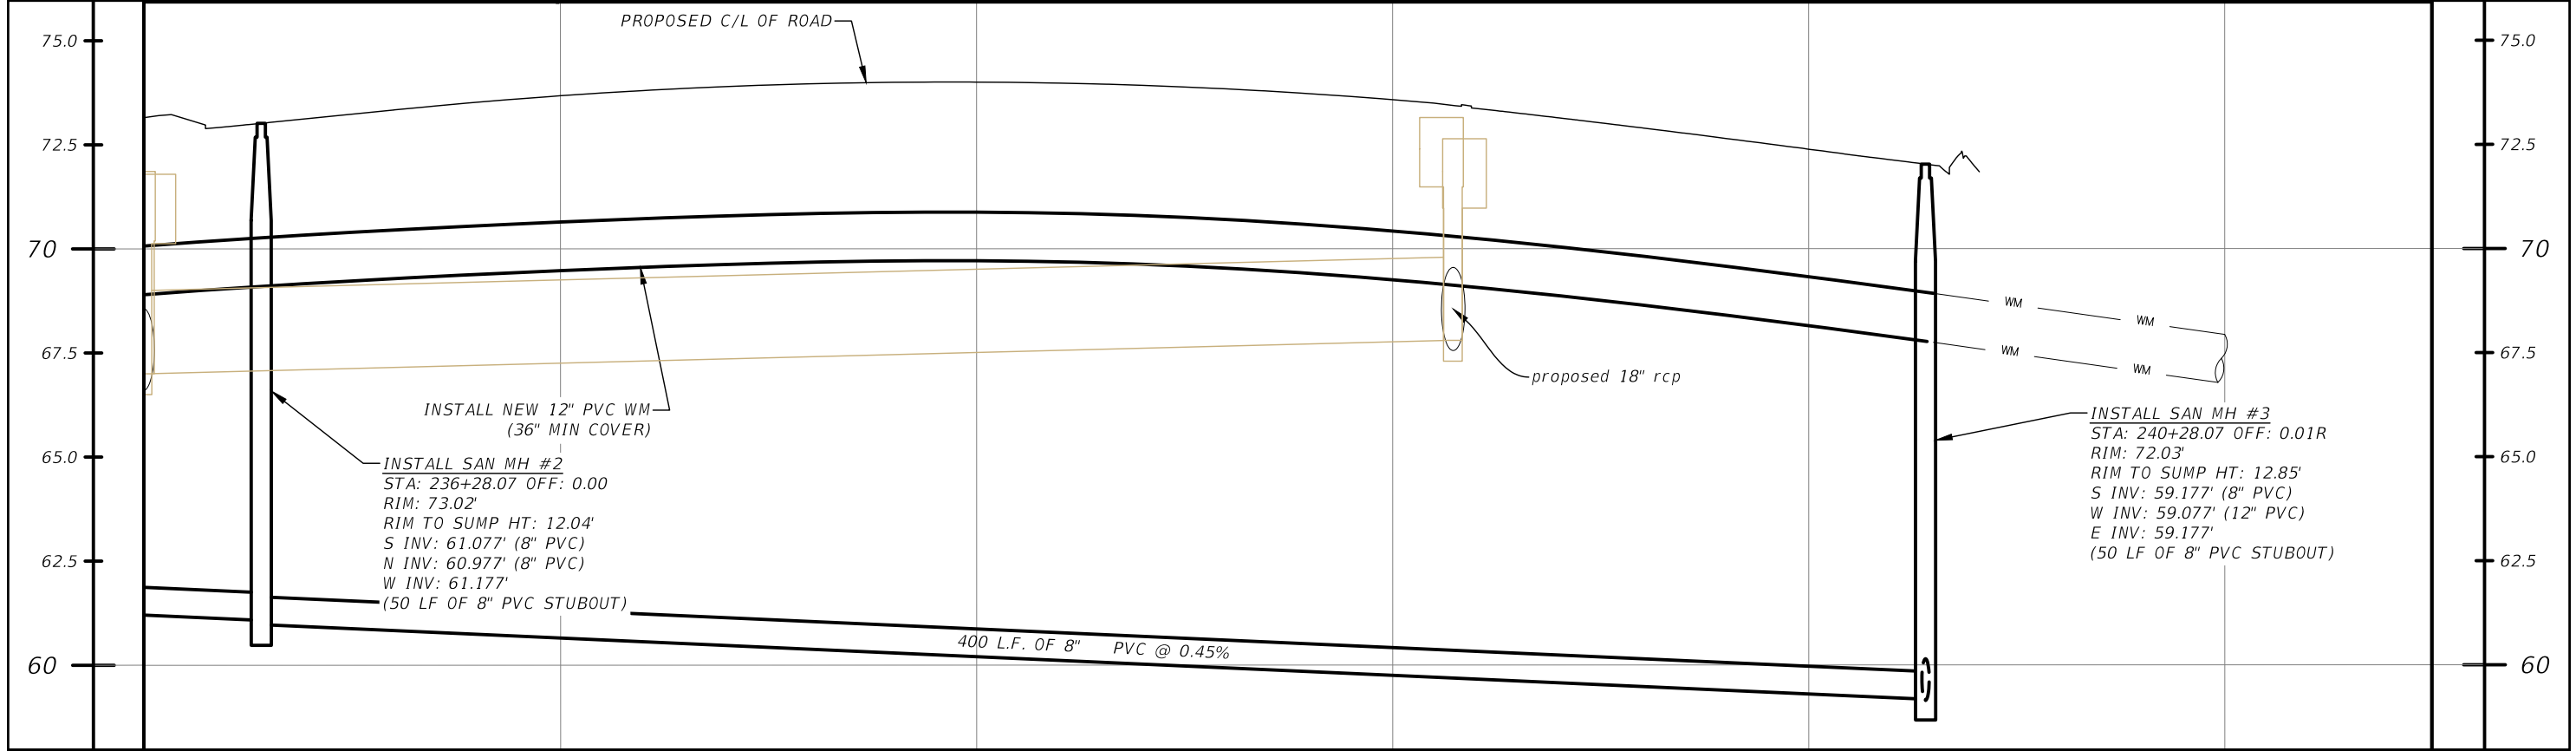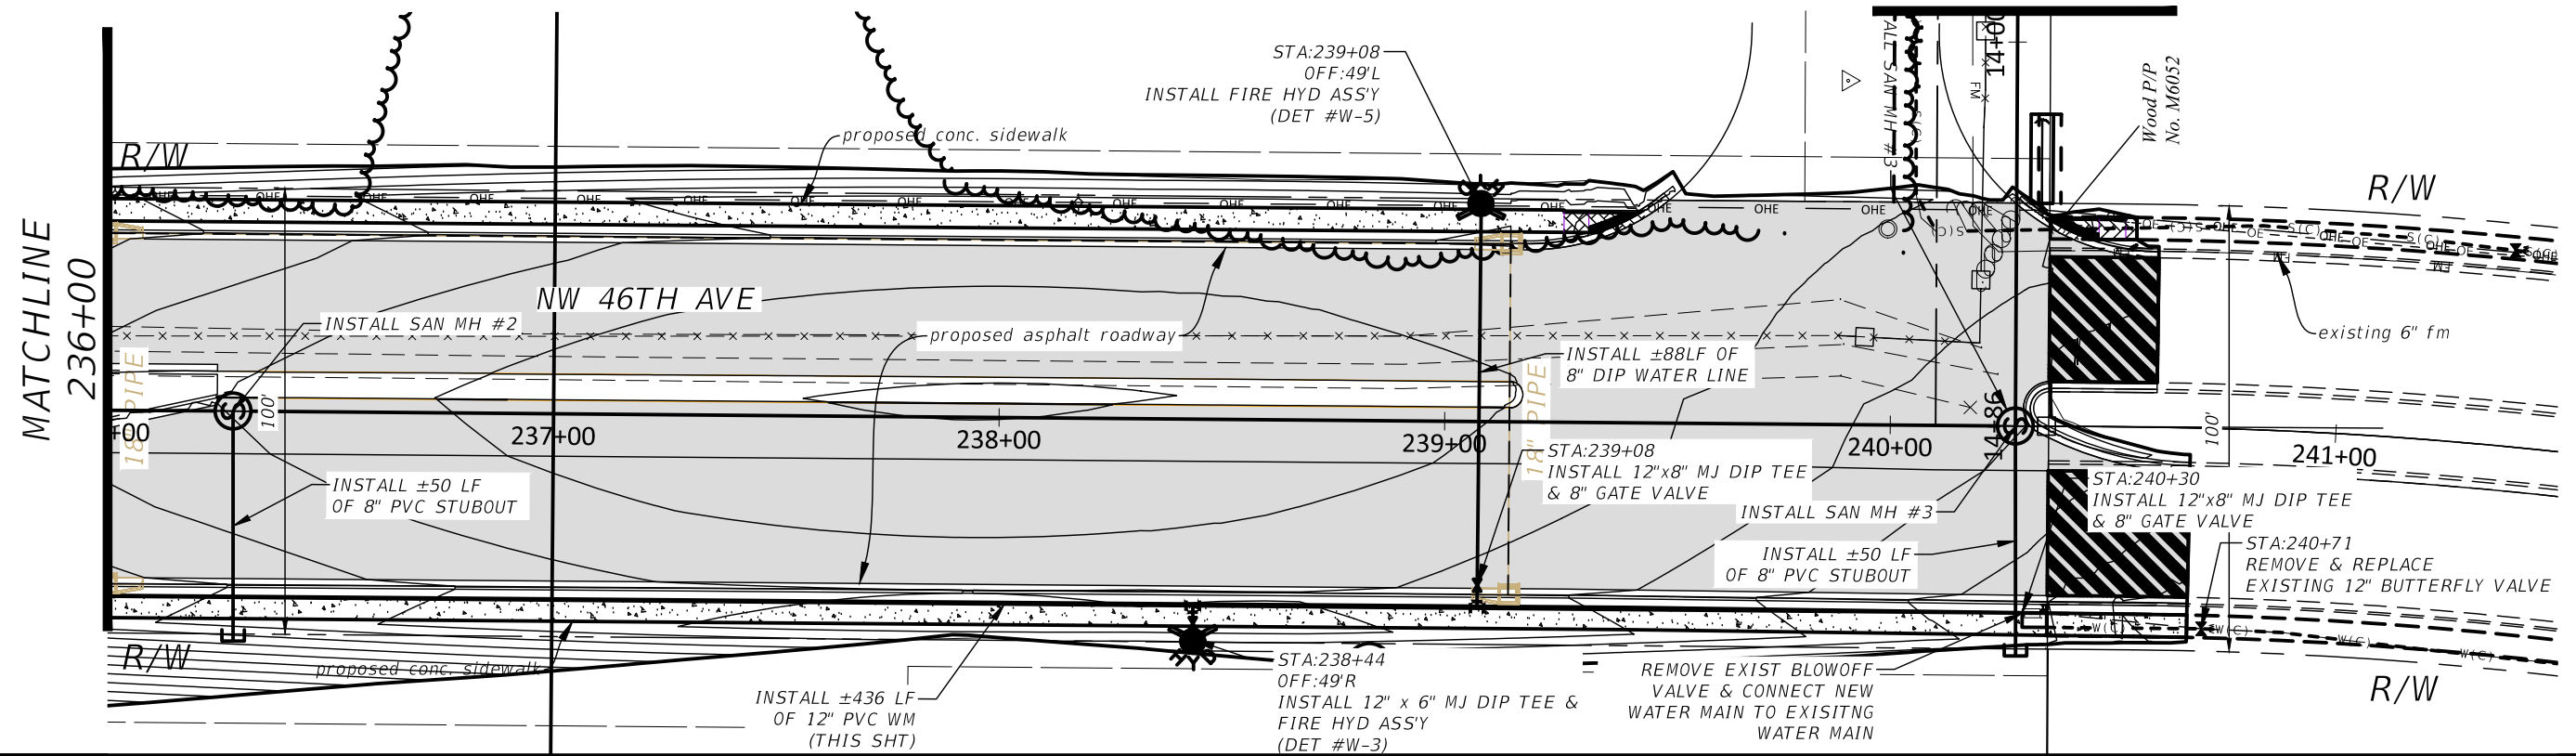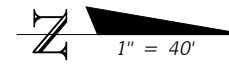


REVISIONS		DESCRIPTION		HECTOR A. COLON, PE P.E. LICENSE NUMBER 84007 CITY OF OCALA, FLORIDA 1805 NE 30TH AVENUE OCALA, FLORIDA 34470	PREPARED BY OCALA CITY ENGINEER'S OFFICE	PROJECT NO. ---- PROJECT NAME: NW 44TH AVENUE EXTENSION PHASE 2 UTILITY PLAN AND PROFILE (8)	SHEET NO. 65
DATE	DESCRIPTION	DATE	DESCRIPTION				

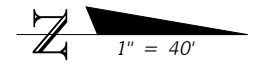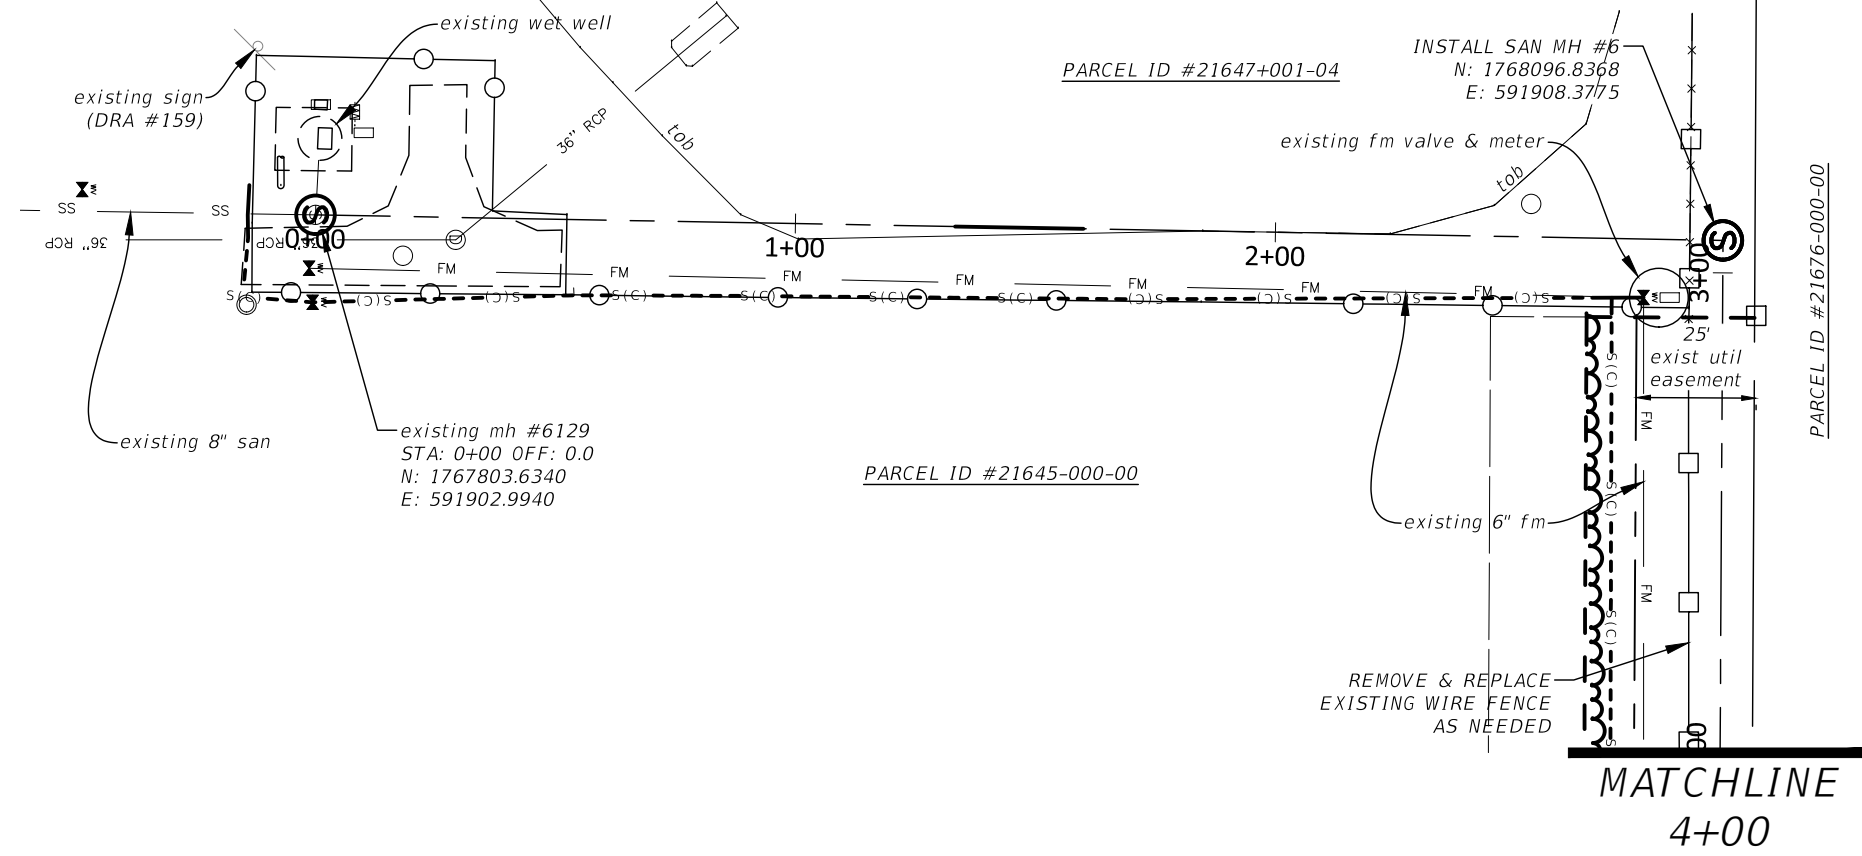


NOTE:
 REMOVE ALL TREES, CLEAR, & GRUB
 WITHIN ENTIRE 25' UTILITY EASEMENT

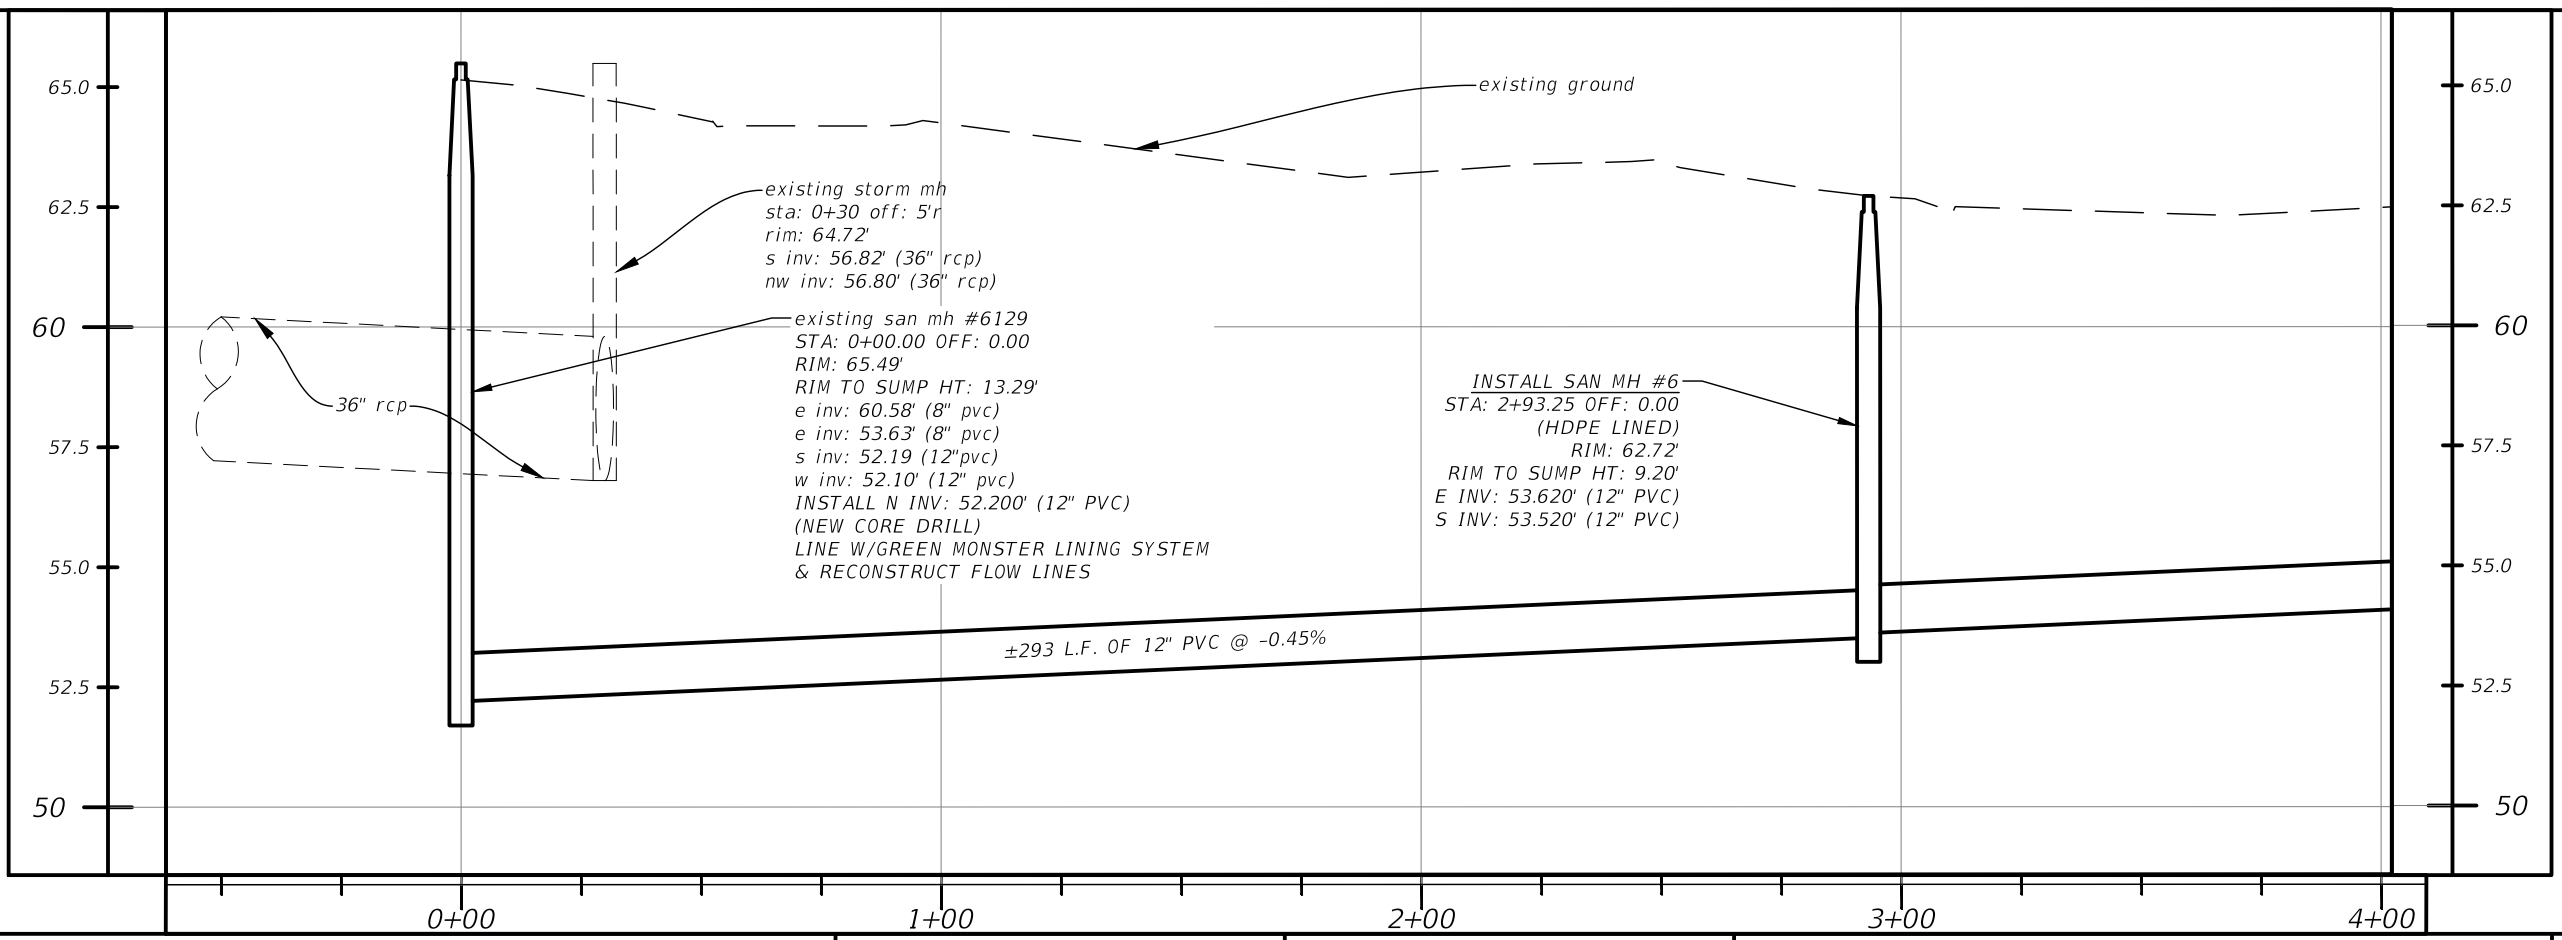


REVISIONS				HECTOR A. COLON, PE P.E. LICENSE NUMBER 84007 CITY OF OCALA, FLORIDA 1805 NE 30TH AVENUE OCALA, FLORIDA 34470	PREPARED BY 	PROJECT NO. --- PROJECT NAME: NW 44TH AVENUE EXTENSION PHASE 2 UTILITY PLAN AND PROFILE AT LS 87 (9)	SHEET NO. 66
DATE	DESCRIPTION	DATE	DESCRIPTION				

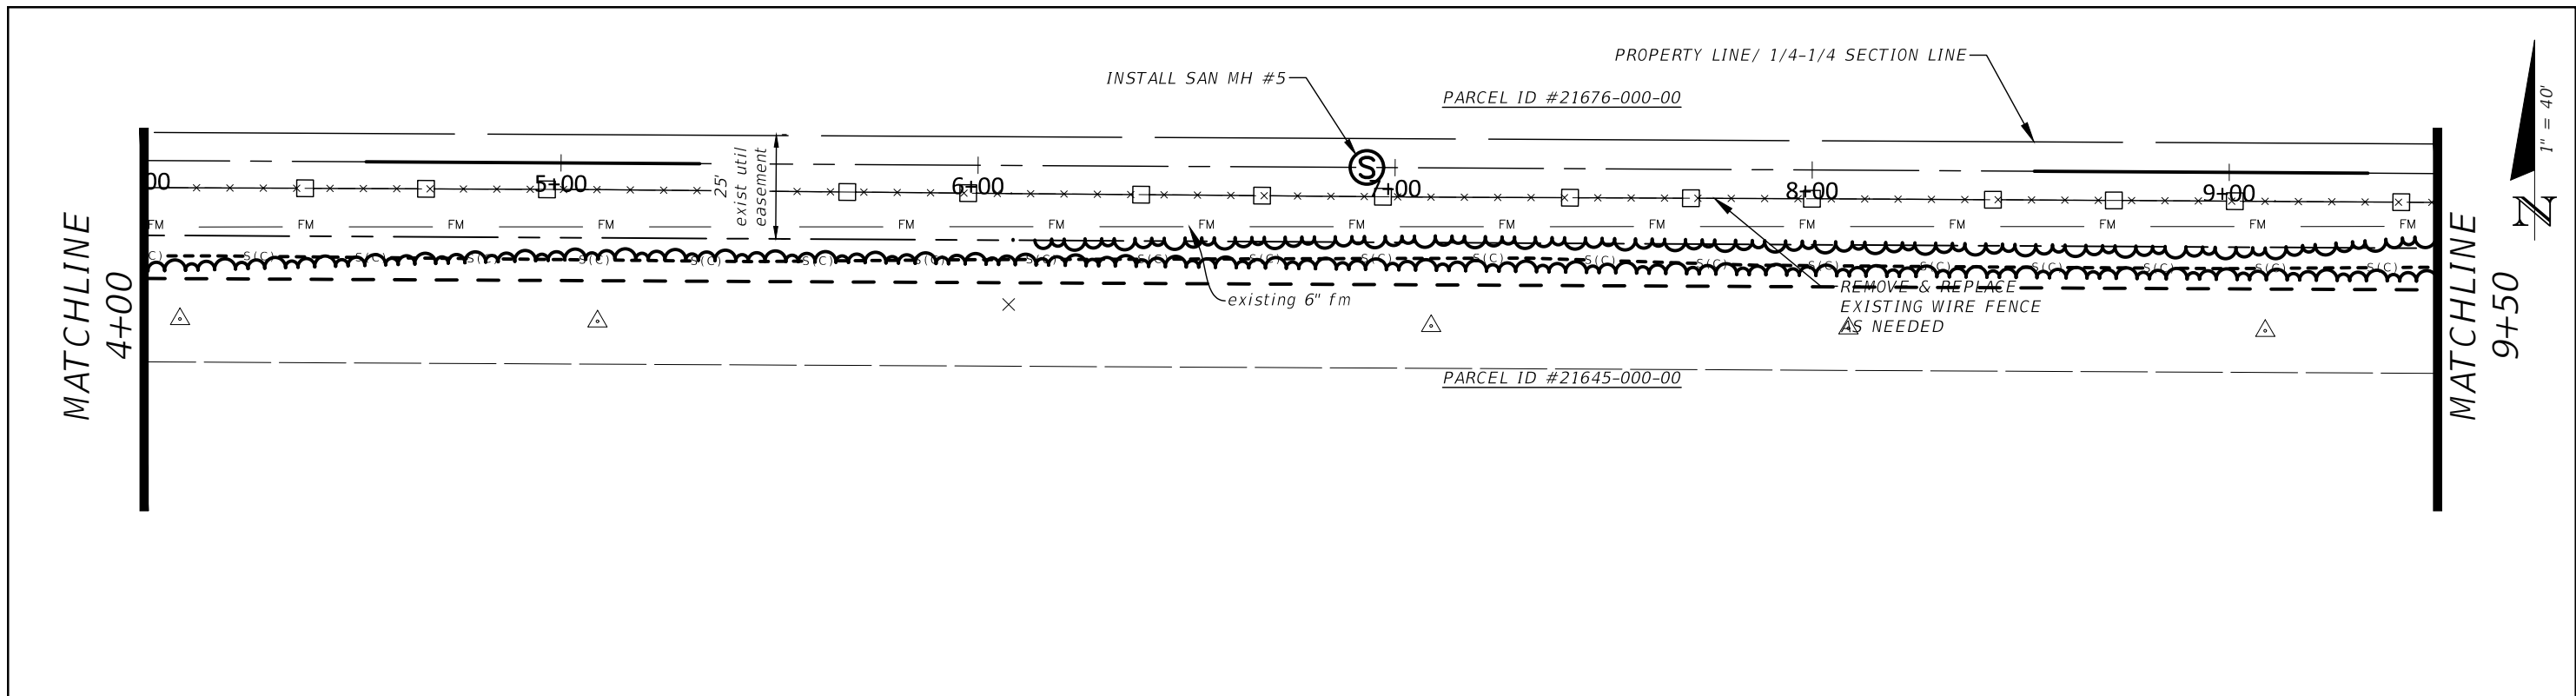


NOTE:
REMOVE ALL TREES, CLEAR, & GRUB
WITHIN ENTIRE 25' UTILITY EASEMENT

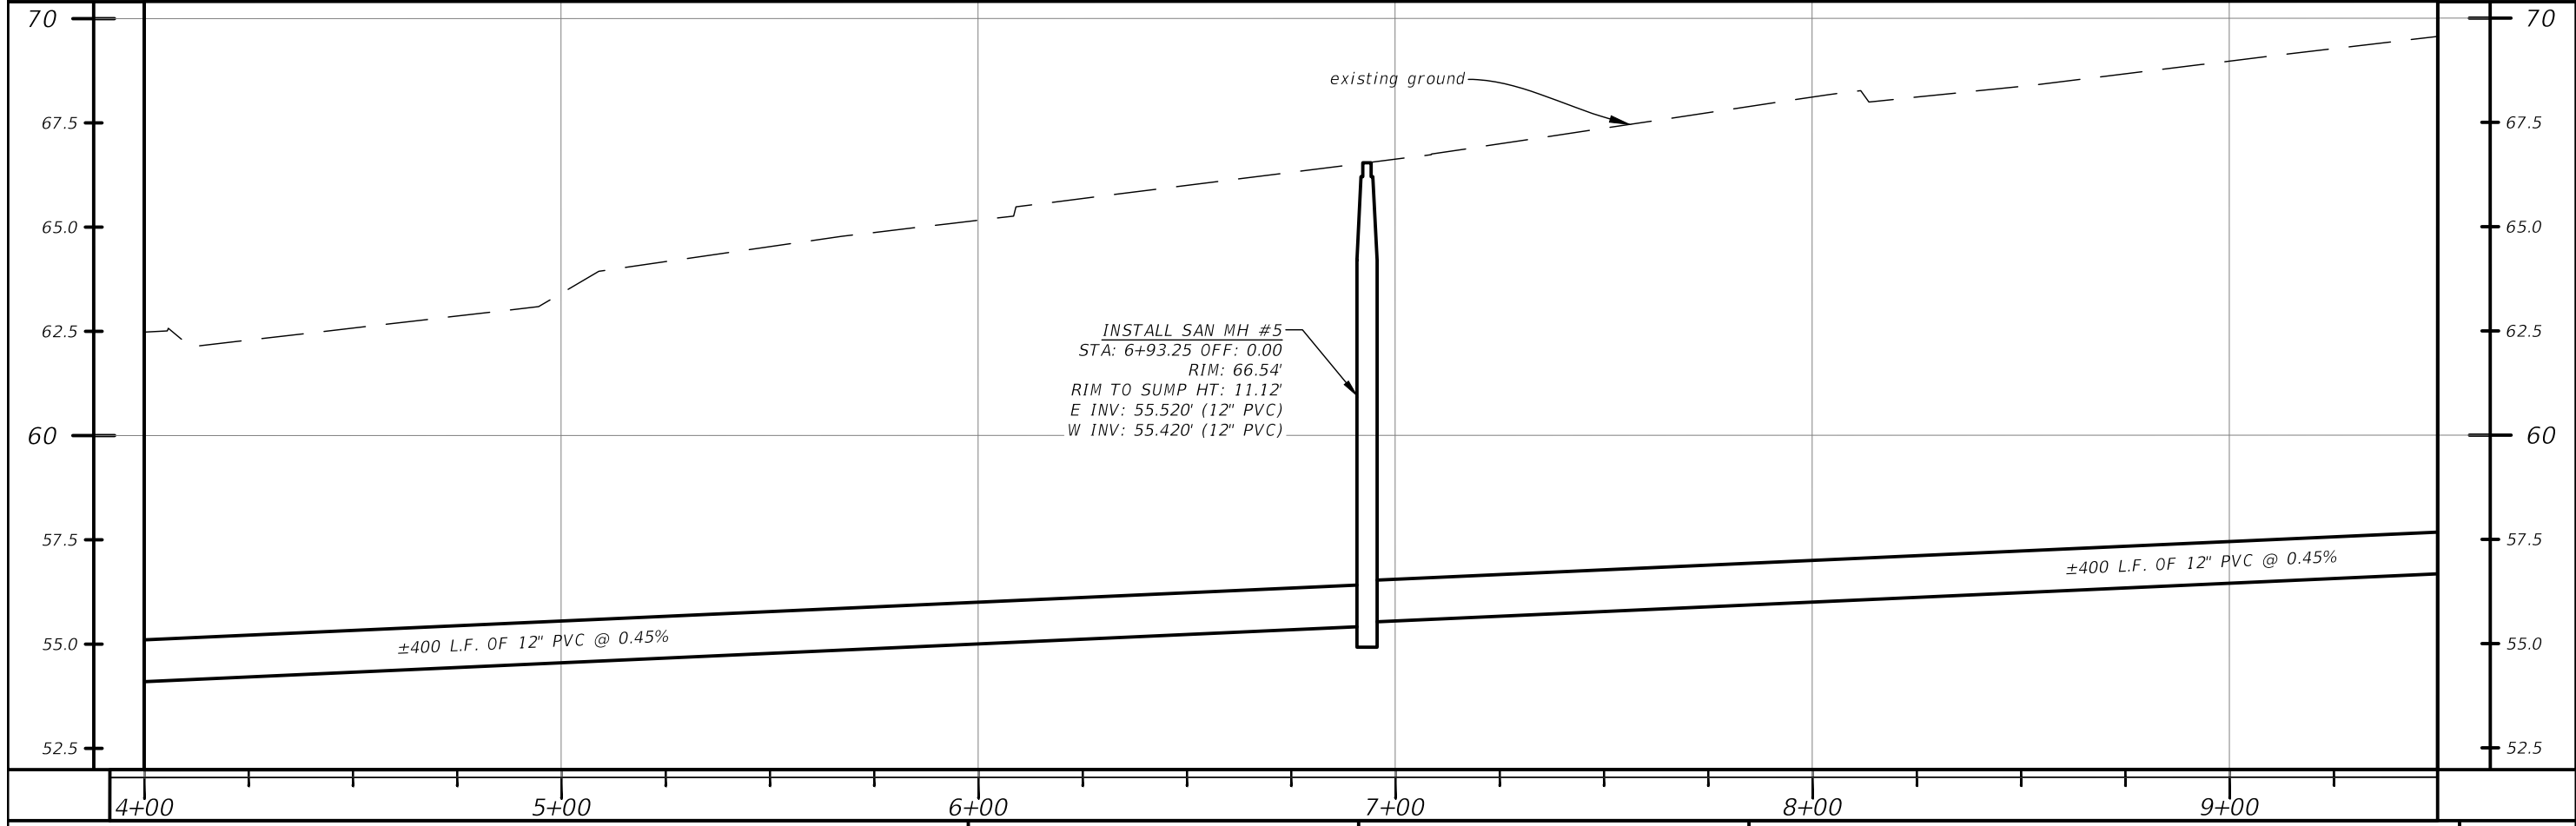

REVISIONS				HECTOR A. COLON, PE P.E. LICENSE NUMBER 84007 CITY OF OCALA, FLORIDA 1805 NE 30TH AVENUE OCALA, FLORIDA 34470	PREPARED BY 	PROJECT NO. --- PROJECT NAME: NW 44TH AVENUE EXTENSION PHASE 2 UTILITY PLAN AND PROFILE (10)	SHEET NO. 67
DATE	DESCRIPTION	DATE	DESCRIPTION				

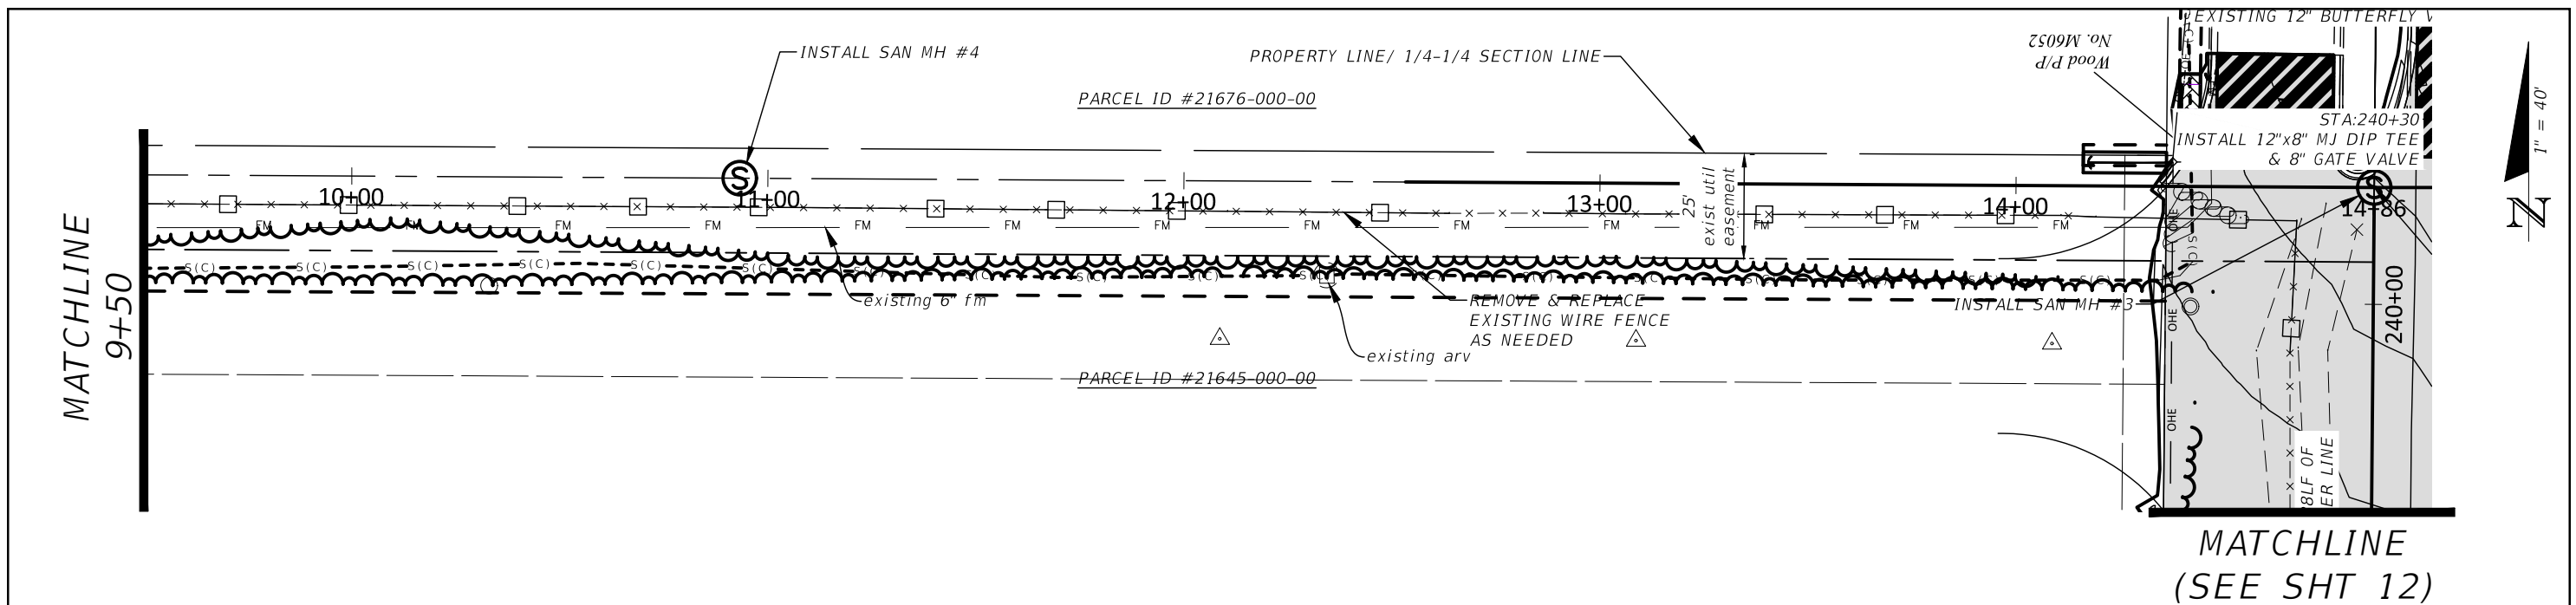

NOTE:
 REMOVE ALL TREES, CLEAR, & GRUB
 WITHIN ENTIRE 25' UTILITY EASEMENT

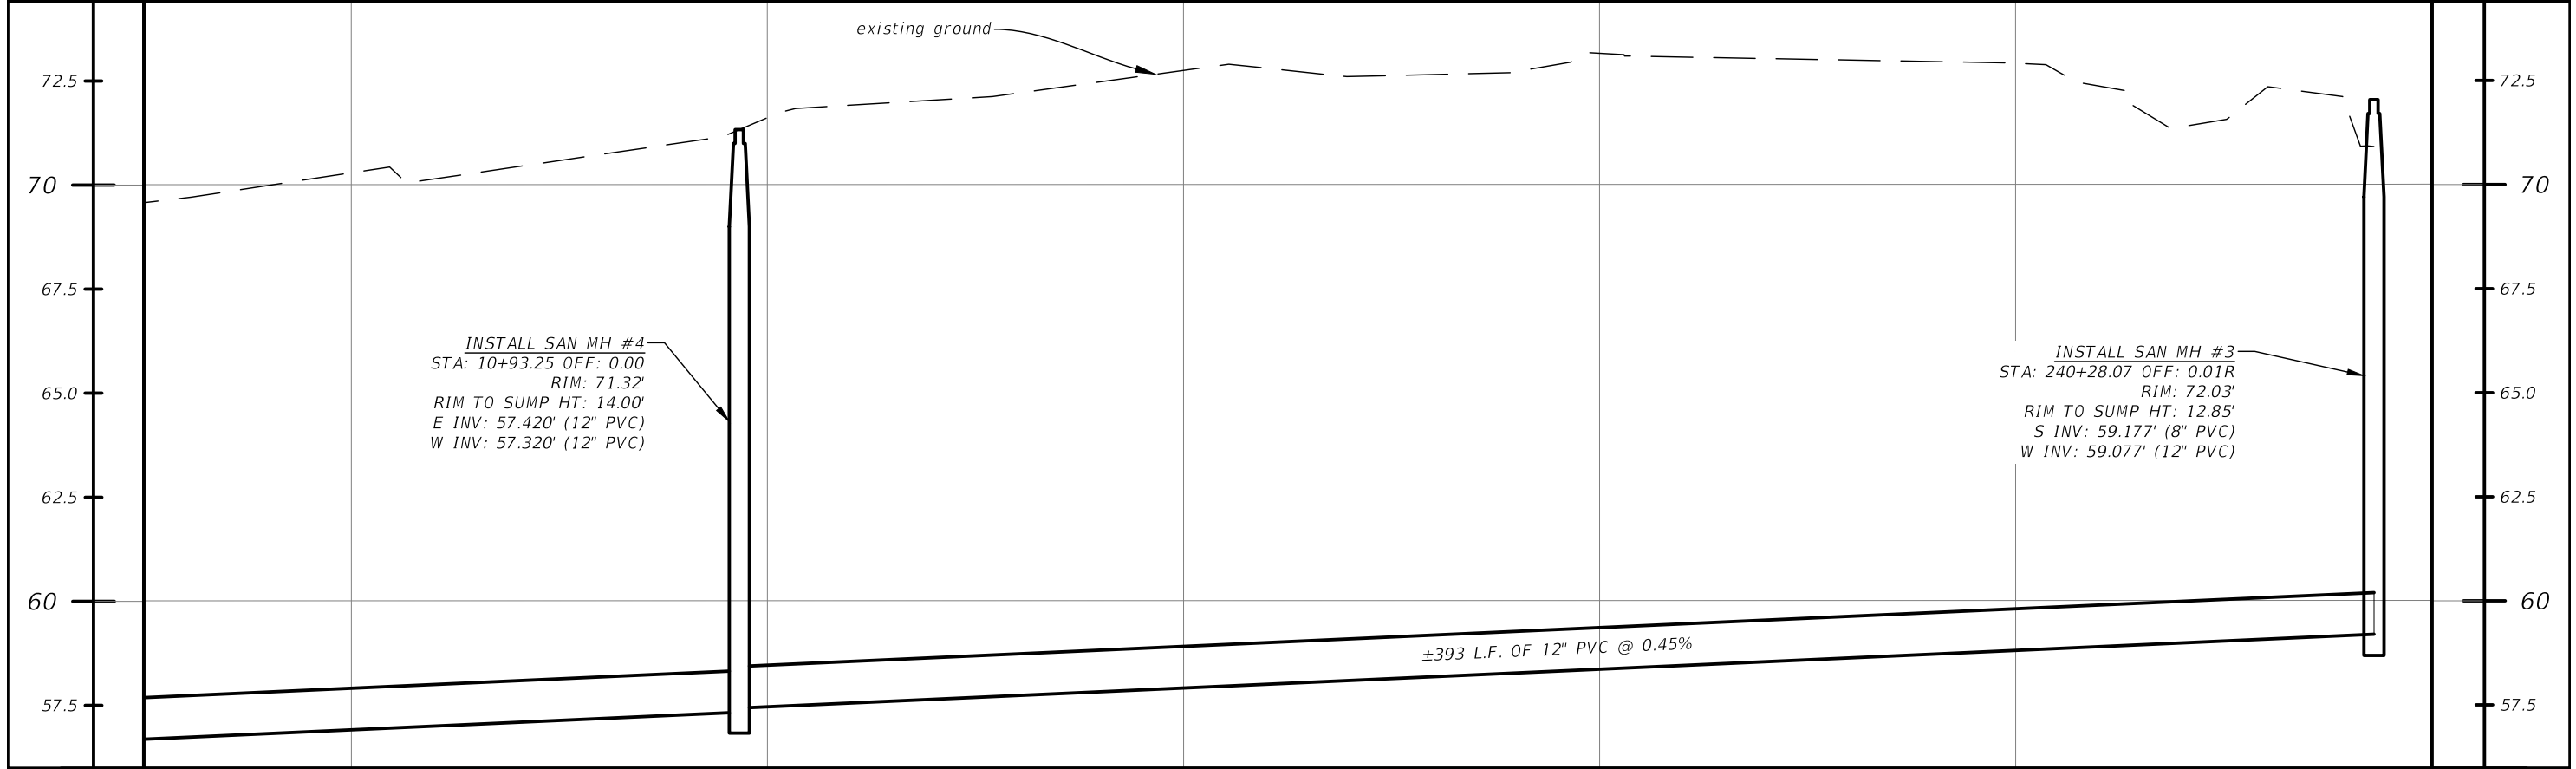


REVISIONS				HECTOR A. COLON, PE P.E. LICENSE NUMBER 84007 CITY OF OCALA, FLORIDA 1805 NE 30TH AVENUE OCALA, FLORIDA 34470	PREPARED BY 	PROJECT NO. --- PROJECT NAME: NW 44TH AVENUE EXTENSION PHASE 2 UTILITY PLAN AND PROFILE (11)	SHEET NO. 68
DATE	DESCRIPTION	DATE	DESCRIPTION				

GENERAL NOTES:

1. ALL CONSTRUCTIONS SHALL BE IN ACCORDANCE TO THE JANUARY 2022 EDITION OF THE CITY OF OCALA'S "STANDARD SPECIFICATIONS FOR CONSTRUCTION OF STREETS, STORMWATER, TRAFFIC, WATER & SEWER INFRASTRUCTURE".
2. ALL UNSUITABLE MATERIALS ENCOUNTERED SHALL BE DISPOSED OF AND REPLACED WITH APPROVED MATERIALS.
3. NEW WATER MAIN TO BE INSTALLED AT 36" DEEP (MIN.) TO TOP OF PIPE EXCEPT WHERE VERTICAL ADJUSTMENTS ARE REQUIRED TO AVOID CONFLICTS. SEE ALSO NOTES 7 AND 8 BELOW.
4. ALL UTILITIES SHOWN ON THESE PLANS HAVE BEEN PLOTTED FROM THE BEST AVAILABLE RECORDS. HOWEVER, IT IS THE CONTRACTORS RESPONSIBILITY TO VERIFY THEIR LOCATIONS AND CONDITIONS FROM THE UTILITY AGENCIES PRIOR TO CONSTRUCTION.
5. EXCAVATED MATERIALS SHALL BE LOADED ONTO DUMP TRUCKS DIRECTLY BEHIND THE EQUIPMENT AND HAULED OFF TO THE DESIGNATED SITE. TRAFFIC CONTROL MEASURES SHALL BE PLACED ACCORDINGLY TO ACCOMMODATE THIS PROCESS.
6. INSTALL INLET PROTECTION DEVICES AT ALL INLETS TO MINIMIZE DEBRIS ENTERING THE STORM DRAIN SYSTEM. (AS APPROVED BY FDEP)
7. THE CONTRACTOR SHALL BE NOISE SENSITIVE FOR NIGHT OPERATIONS.
8. CONTRACTOR TO PERFORM HYDROSTATIC TESTING OF WATER MAIN AND WATER SERVICES.
9. NEW OR RELOCATED WATER MAINS SHALL BE LAID TO PROVIDE A HORIZONTAL DISTANCE OF AT LEAST 6 FEET AND PREFERABLY 10 FEET, BETWEEN THE OUTSIDE OF THE WATER MAIN AND THE OUTSIDE OF ANY EXISTING GRAVITY SEWER, SEWER FORCE MAIN, OR RECLAIMED WATER MAINS. THE MINIMUM HORIZONTAL SEPARATION DISTANCE BETWEEN WATER MAINS AND GRAVITY-TYPE SANITARY SEWERS SHALL BE REDUCED TO 3 FEET WHERE BOTTOM OF THE WATER MAIN IS LAID AT LEAST 6 INCHES ABOVE THE TOP OF THE SEWER. NEW OR RELOCATED UNDERGROUND WATER MAINS CROSSING ANY EXISTING OR NEW GRAVITY SEWER SHALL BE LAID SO THE OUTSIDE OF THE WATER MAIN IS AT LEAST 6 INCHES AND PREFERABLY 12 INCHES ABOVE OR AT LEAST 12 INCHES BELOW THE OUTSIDE OF THE OTHER PIPE LINE. IT IS PREFERABLE TO INSTALL THE WATER MAIN ABOVE OTHER PIPE LINES.
10. AT THE UTILITY CROSSINGS, ONE FULL LENGTH OF WATER MAIN PIPE SHALL BE CENTERED ABOVE OR BELOW THE CROSSING PIPELINES, SO THAT WATER LINE JOINTS ARE AS FAR AS POSSIBLE FROM THE CROSSING PIPE. PIPE CROSSINGS SHALL BE ARRANGED SO THAT ALL WATER MAIN JOINTS ARE AT LEAST 3 FEET FROM JOINTS IN VACUUM-TYPE RECLAIMED WATER SEWER MAINS AND AT LEAST 6 FEET FROM ALL JOINTS IN GRAVITY SEWERS AND SEWER FORCE MAINS.
11. WATER METER SERVICES MAY BE REMOVED/ADDED BASED ON ACTUAL FIELD CONDITIONS.
12. ACTUAL LOCATIONS AND SIZES OF WATER MAINS AND METERS MAY VARY FROM WHAT IS SHOWN. CONTRACTOR IS RESPONSIBLE FOR FIELD VISIT PRIOR TO BID.
13. TAPS MAY BE DELETED IF NEW MAIN CAN BE CONNECTED DIRECTLY TO OLD MAIN VIA PIPE-SLEEVES AND/OR EXISTING VALVES.
14. IT IS THE RESPONSIBILITY OF THE CONTRACTOR TO LOCATE EXISTING SEWER LATERALS. CITY MAY PROVIDE AS-BUILTS IF REQUESTED.
15. WHERE WATER METERS ARE TO BE RELOCATED, THE COST OF MATERIAL AND LABOR TO RELOCATE THE METER BOX TO THE NEW LOCATION SHALL BE CONSIDERED PART OF THE RELOCATION COST AND SHALL INCLUDE METER RELOCATIONS WITHIN 20' OF THE ORIGINAL LOCATION. FOR RELOCATIONS MORE THAN 20' FROM THE OLD LOCATION, THE COST OF LABOR AND MATERIAL SHALL BE INCLUDED IN THE COST PER FOOT FOR "EXTENDING CUSTOMER SERVICE TO RELOCATED METER".
16. WHERE NON-STANDARD METER BOXES ARE FOUND, THE CONTRACTOR SHALL REPLACE THE EXISTING METER BOX WITH A STANDARD GULF BOX. UNIT PRICE SHALL INCLUDE ALL MATERIALS NECESSARY TO REMOVE AND REPLACE THE METER BOX.
17. WHERE WATER MAINS AND APPURTENANCES ARE TO BE ABANDONED, THE CONTRACTOR SHALL ABANDON THE SYSTEM AS FOLLOWS:
18. WATER VALVES - REMOVE ALL WATER VALVES ON ABANDONED WATER MAINS WHERE WATER MAINS CAN BE SHUT DOWN OR REDUCED TO A WORKABLE FLOW. FOR WATER MAINS THAT CANNOT BE SHUT DOWN FOR VALVE REMOVAL, THEN THE CONTRACTOR SHALL CLOSE THE VALVE, REMOVE VALVE BOX, CUT AND CAP PIPES ON DOWNSTREAM SIDE OF THE VALVE.
19. FIRE HYDRANTS - REMOVE ALL FIRE HYDRANT ASSEMBLIES (FROM VALVE TO HYDRANT) ON EXISTING MAINS WHICH ARE TO BE ABANDONED AND CAP TEE.
20. WATER SERVICES - CLOSE SERVICE VALVE AT WATER MAIN, THEN CUT AND CAP SERVICE PIPE AT SERVICE VALVE. REMOVE ALL METER BOXES, AND CAP ALL PIPES LEFT IN PLACE.
21. WATER MAINS - REMOVE PIPE WHERE REQUIRED FOR CONSTRUCTION. WHERE PIPES ARE LEFT IN PLACE, CAP ALL EXPOSED PIPES. WHERE PIPES LEFT IN PLACE ARE CUT, BROKEN, OR DAMAGED, THE PIPE IS TO BE CUT AND PIPE ENDS TO BE CAPPED ACCORDINGLY. IF REQUIRED FOR PIPES IN FDOT RIGHT-OF-WAY, THEN GROUT ALL ABANDONED PIPES AND FILL WITH FLOWABLE FILL.
22. WHERE PAVEMENT HAS TO BE REMOVED, REPLACE PAVEMENT IN ACCORDANCE WITH DETAIL 478-6.1B TO PROPERLY ABANDON THE WATER MAIN. PAVEMENT IN FDOT RIGHT-OF-WAY SHALL BE REPLACED TO FDOT STANDARDS IN ACCORDANCE WITH PERMIT REQUIREMENTS. RE-STRIPE PAVEMENT AS REQUIRED.
23. WHERE 2" WATER MAINS ARE CALLED FOR ON THE PLANS, INSTALL STANDARD 2" PVC WATER MAINS IN ALL CITY RIGHT OF WAYS AND 2" HDPE IN ALL FDOT RIGHT OF WAYS. FOR ALL DRIVEWAY AND STREET CROSSINGS, CITY AND FDOT, DIRECTIONAL BORE 2" HDPE. AT THE DISCRETION OF THE ENGINEER, DIRECTIONAL BORES MAY BE EXTENDED BETWEEN REQUIRED BORES TO AVOID MULTIPLE TRANSITIONS BETWEEN PIPE MATERIALS IN A SHORT AREA OF PIPE.
24. REVIEW AND COMPLY WITH THE "SPECIAL PROVISIONS" AND OTHER ATTACHMENTS TO THE FDOT PERMIT FOR THIS PROJECT.
25. CALL "FLORIDA SUNSHINE ONE-CALL" FOR UTILITY LOCATION SERVICES AT LEAST 2 BUSINESS DAYS PRIOR TO CONSTRUCTION (1-800-432-4770).
26. COORDINATE ALL UTILITY CLEARANCES WITH THE OWNER OF SUCH UTILITIES PRIOR TO CONSTRUCTION COMMENCEMENT.


CITY OF OCALA STANDARD DETAILS REQUIRED:

1. TYPICAL UTILITY LOCATIONS IN 100' RIGHT-OF-WAY WITH CURB & GUTTER #G-4
2. RESTRAINED JOINT SYSTEM #G-11
3. VALVE BOX INSTALLATION #G-13 & G-14
4. LOCATING WIRE #G-15 (A-G)
5. TRENCH EXCAVATION #G-16
6. TRENCH BACKFILL #G-18
7. SEPARATION OF WATER MAINS #W-2
8. FIRE HYDRANT ASSEMBLY (PERPENDICULAR TO MAIN) #W-3
9. FIRE HYDRANT ASSEMBLY (PARALLEL TO MAIN) #W-4
10. WATER MAIN TAP (4" AND ABOVE) #W-26
11. TEMPORARY BLOWOFF ASSEMBLY #W-27
12. WATER MAIN BY-PASS #W-29
13. TEMPORARY JUMPER CONNECTION #W-30
14. TEMPORARY JUMPER CONNECTION (WITH FIRE HYDRANT) #W-31
15. PRECAST CONCRETE MANHOLE (5' TO 12' DEPTH) #SS-3
16. PRECAST CONCRETE MANHOLE (OVER 12' DEPTH) #SS-4
17. SEWER HINGED MANHOLE COVER #SS-5A
18. SEWER MANHOLE STUBOUT #SS-7
19. SEWER MANHOLE JOINT CONSTRUCTION #SS-8
20. JACKING & BORING DETAIL #G-8

REVISIONS				HECTOR A. COLON, PE P.E. LICENSE NUMBER 84007 CITY OF OCALA, FLORIDA 1805 NE 30TH AVENUE OCALA, FLORIDA 34470	PREPARED BY	NW 44th AVENUE EXTENSION PHASE 2	SHEET NO.
DATE	DESCRIPTION	DATE	DESCRIPTION			UTILITY NOTES	69
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BIKE STRIPING NOTE:


1. THE EDGE OF THE BIKE LANE ADJACENT TO THE TRAVEL WAY IS TWO (2) 6" WHITE STRIPES, SET 8" APART PER FDOT SPI 711-001, BEING EITHER SOLID OR 2'-4" SKIP PER THE MARKING PLAN. OUTER LINES OMITTED FOR CLARITY.

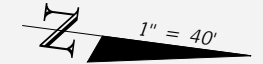

SW 46TH AVENUE

STATE ROAD No. 40

DESIGN SPEED: 35 mi/h
 STA. 200+00.00
 Beg. STA. 200+00.00
 40
 41
 42

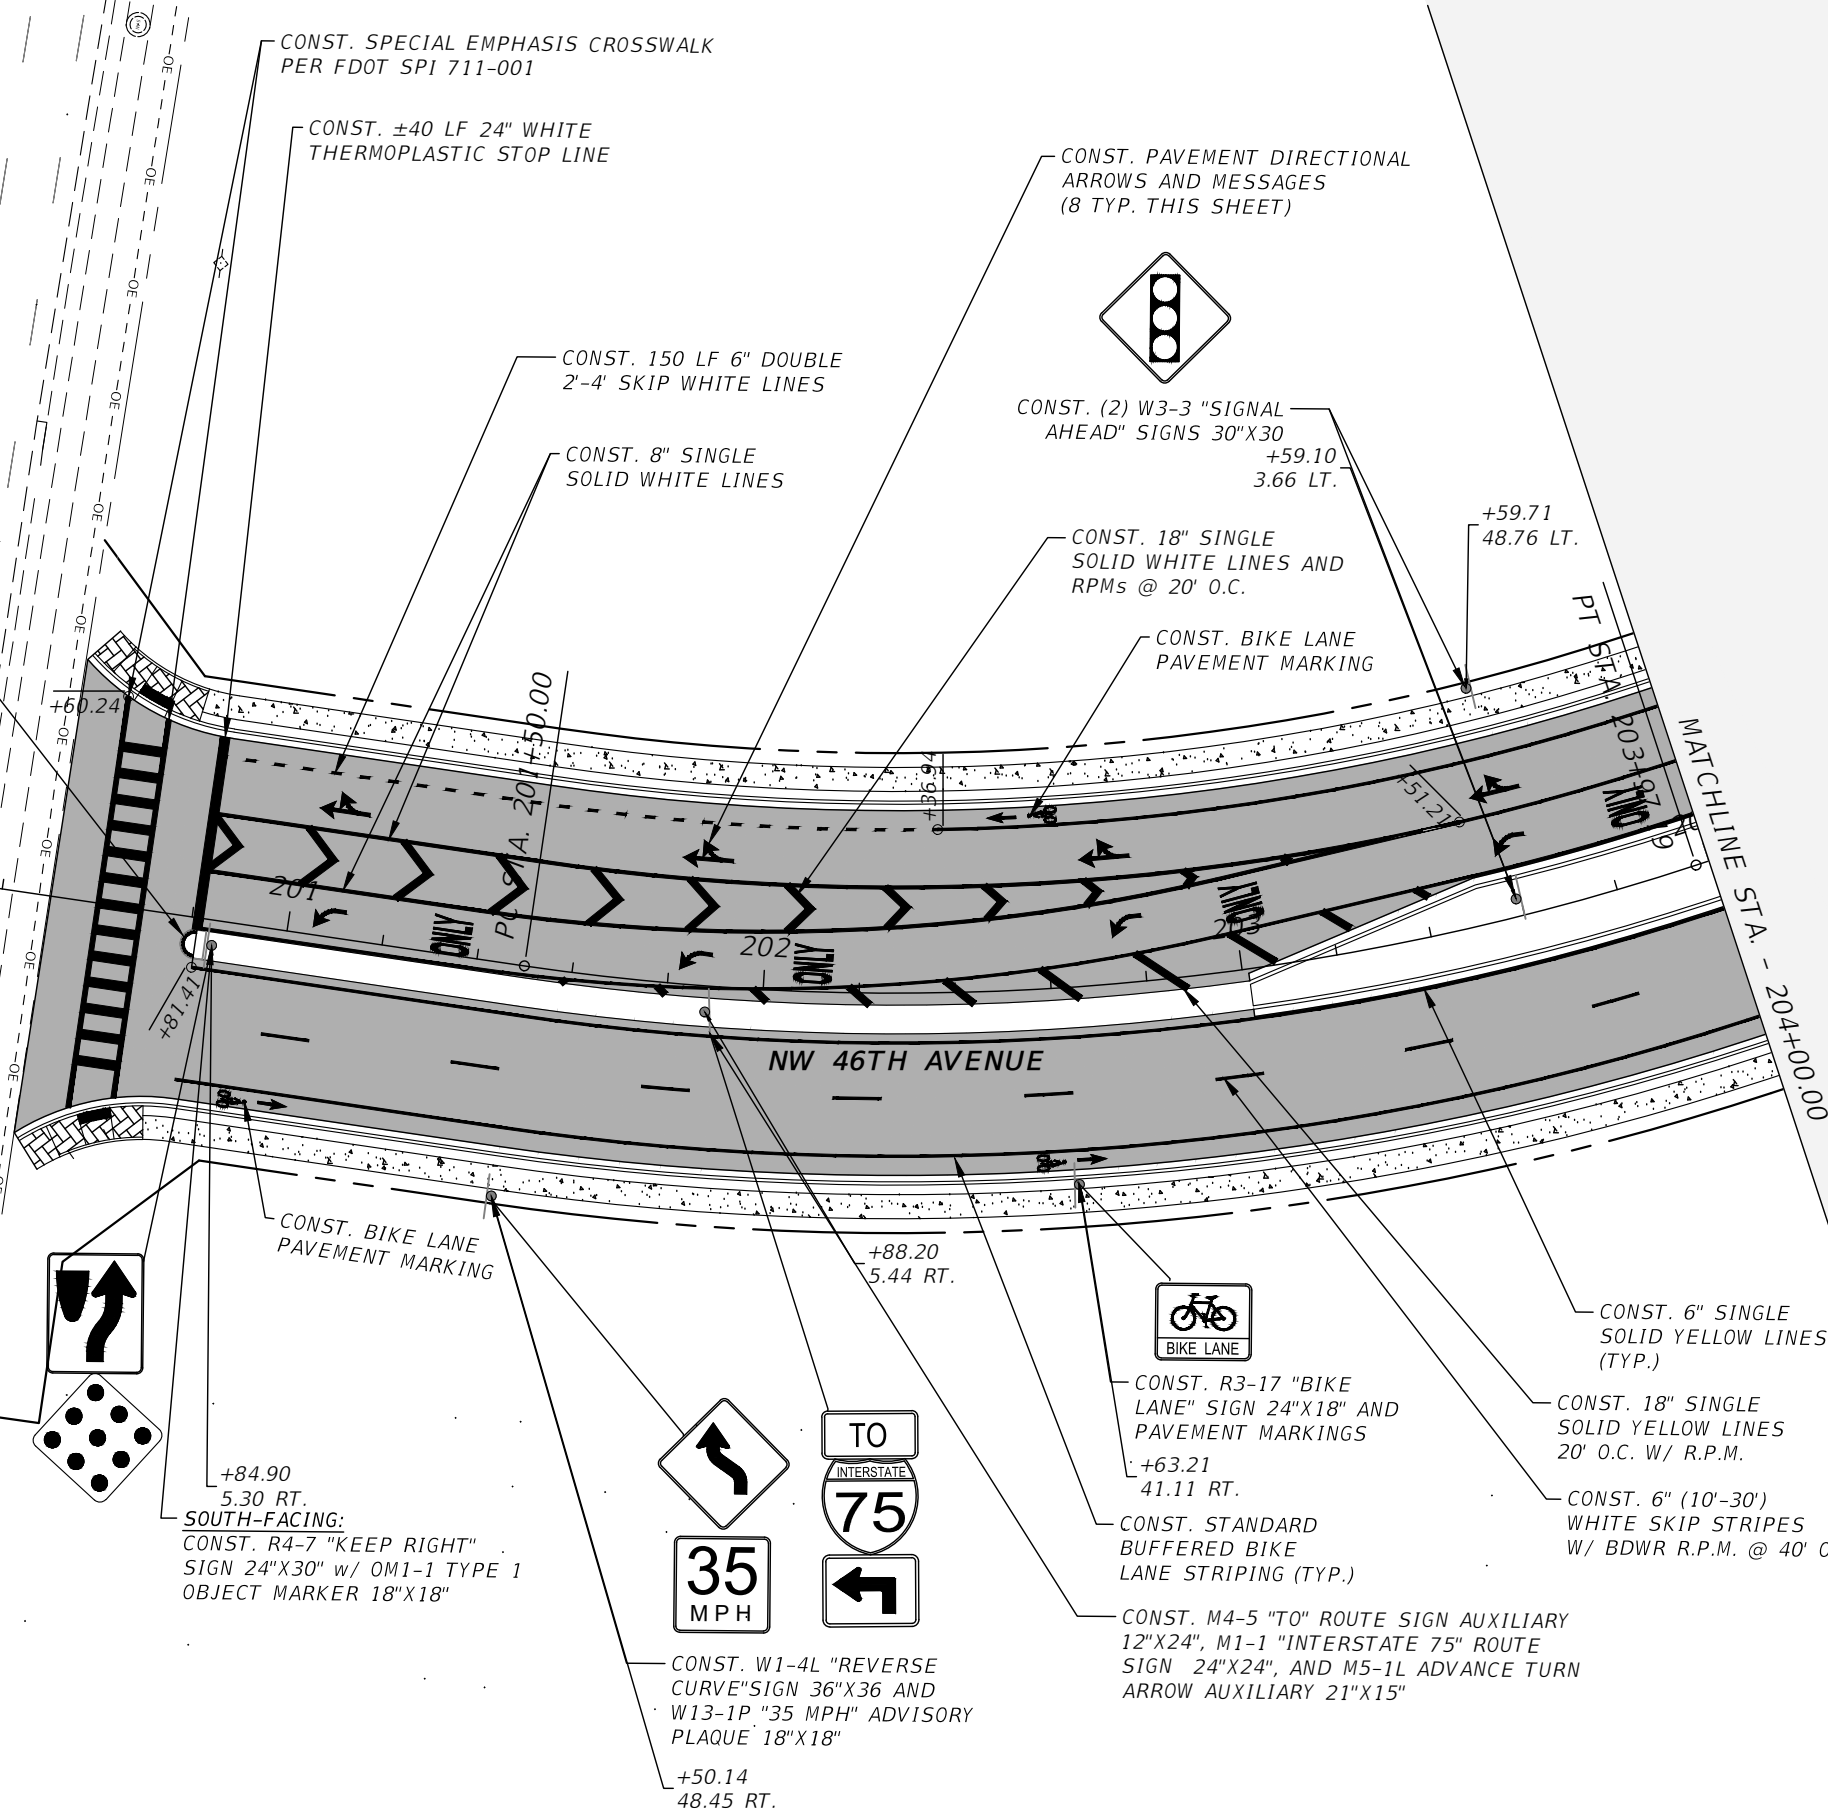

REVISIONS	
DATE	DESCRIPTION
1/25/23	Revised Striping
2/9/23	Revised Project's Starting Point
4/6/23	Revised notes & pavement markings

NOEL JOHN COOPER, P.E.
 P.E. LICENSE NUMBER 69534
 STATE OF FLORIDA, DATE: _____
 VALID ONLY WITH EMBOSSED SEAL.

PREPARED BY

Gary Anson

NW 44th AVENUE EXTENSION PHASE 2



SIGNAGE AND STRIPING PLAN (1)

SHEET NO.
 70

THE OFFICIAL RECORD OF THIS SHEET IS THE ELECTRONIC FILE DIGITALLY SIGNED AND SEALED UNDER RULE 61G15-23.004, F.A.C.

BIKE STRIPING NOTE:

1. THE EDGE OF THE BIKE LANE ADJACENT TO THE TRAVEL WAY IS TWO (2) 6" WHITE STRIPES, SET 8" APART PER FDOT SPI 711-001, BEING EITHER SOLID OR 2'-4" SKIP PER THE MARKING PLAN. OUTER LINES OMITTED FOR CLARITY.

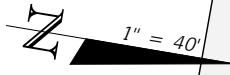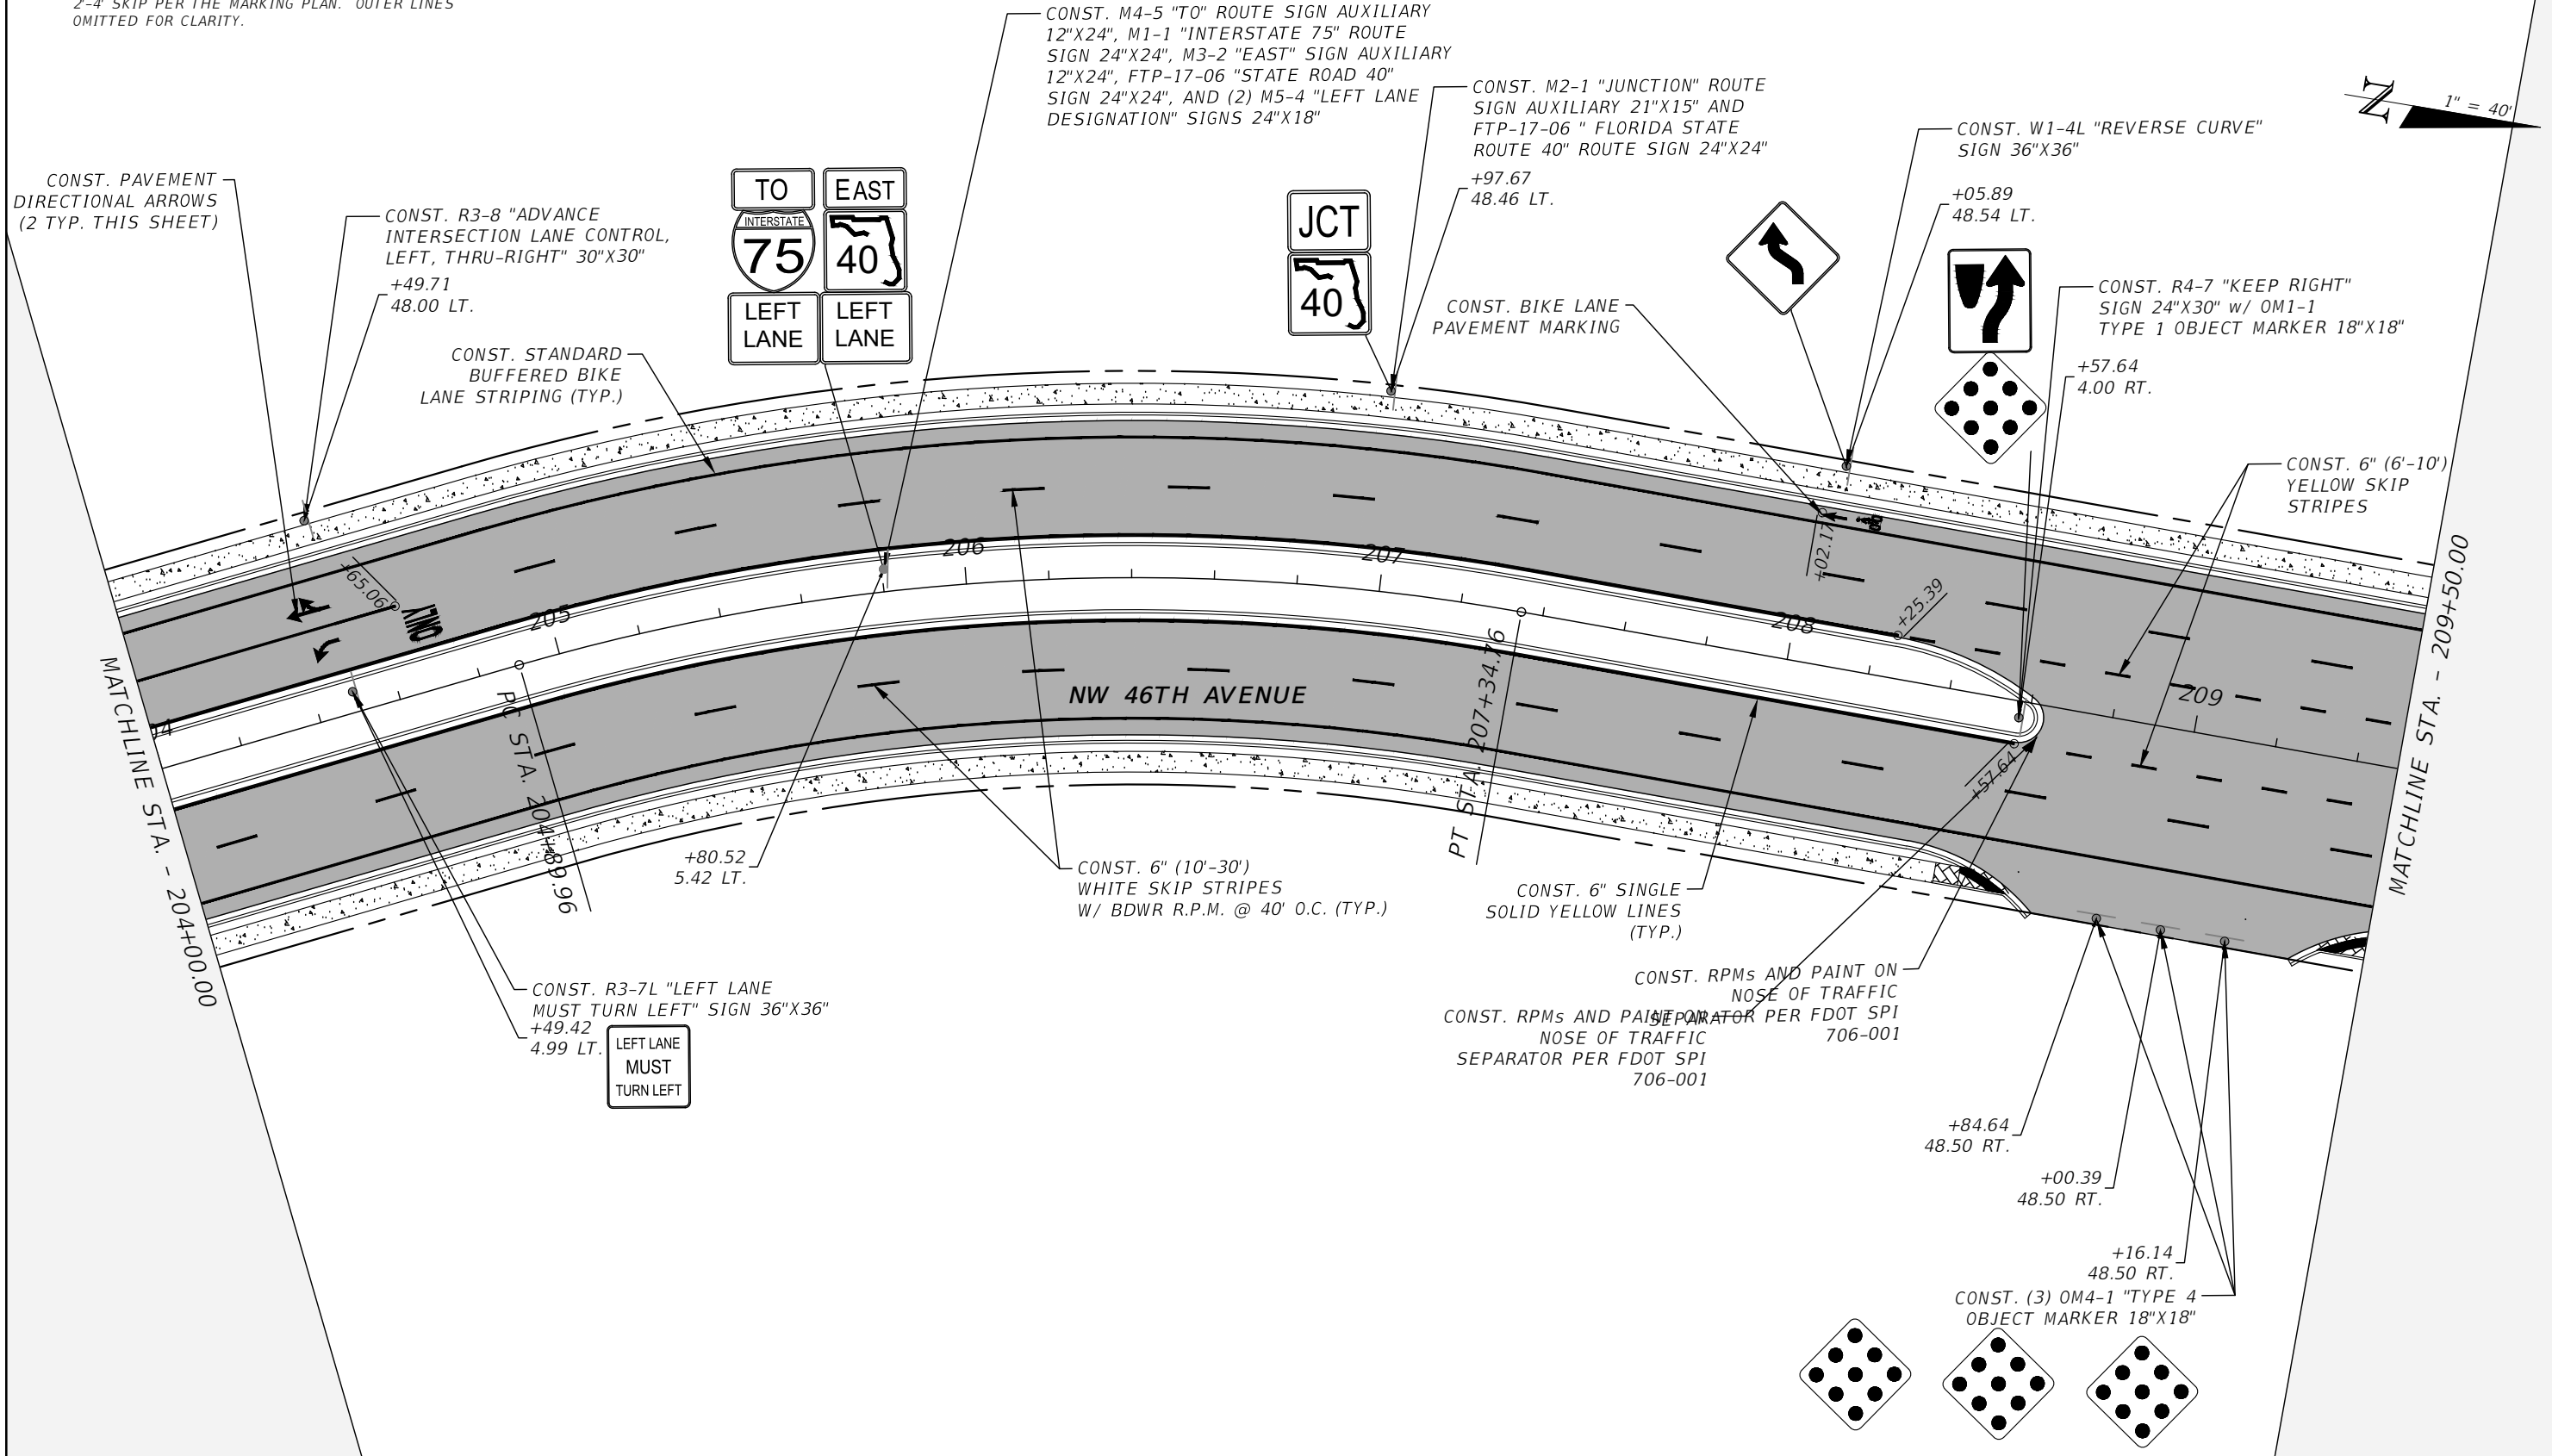

REVISIONS			
DATE	DESCRIPTION	DATE	DESCRIPTION
4/6/23	Revised notes, pavement markings, & signs	----	----

NOEL JOHN COOPER, P.E.
 P.E. LICENSE NUMBER 69534
 STATE OF FLORIDA, DATE: _____
 VALID ONLY WITH EMBOSSED SEAL.

PREPARED BY

Gary Anson

NW 44th AVENUE EXTENSION PHASE 2



SIGNAGE AND STRIPING PLAN (2)

SHEET NO.
71

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BIKE STRIPING NOTE:

1. THE EDGE OF THE BIKE LANE ADJACENT TO THE TRAVEL WAY IS TWO (2) 6" WHITE STRIPES, SET 8" APART PER FDOT SPI 711-001, BEING EITHER SOLID OR 2'-4" SKIP PER THE MARKING PLAN. OUTER LINES OMITTED FOR CLARITY.

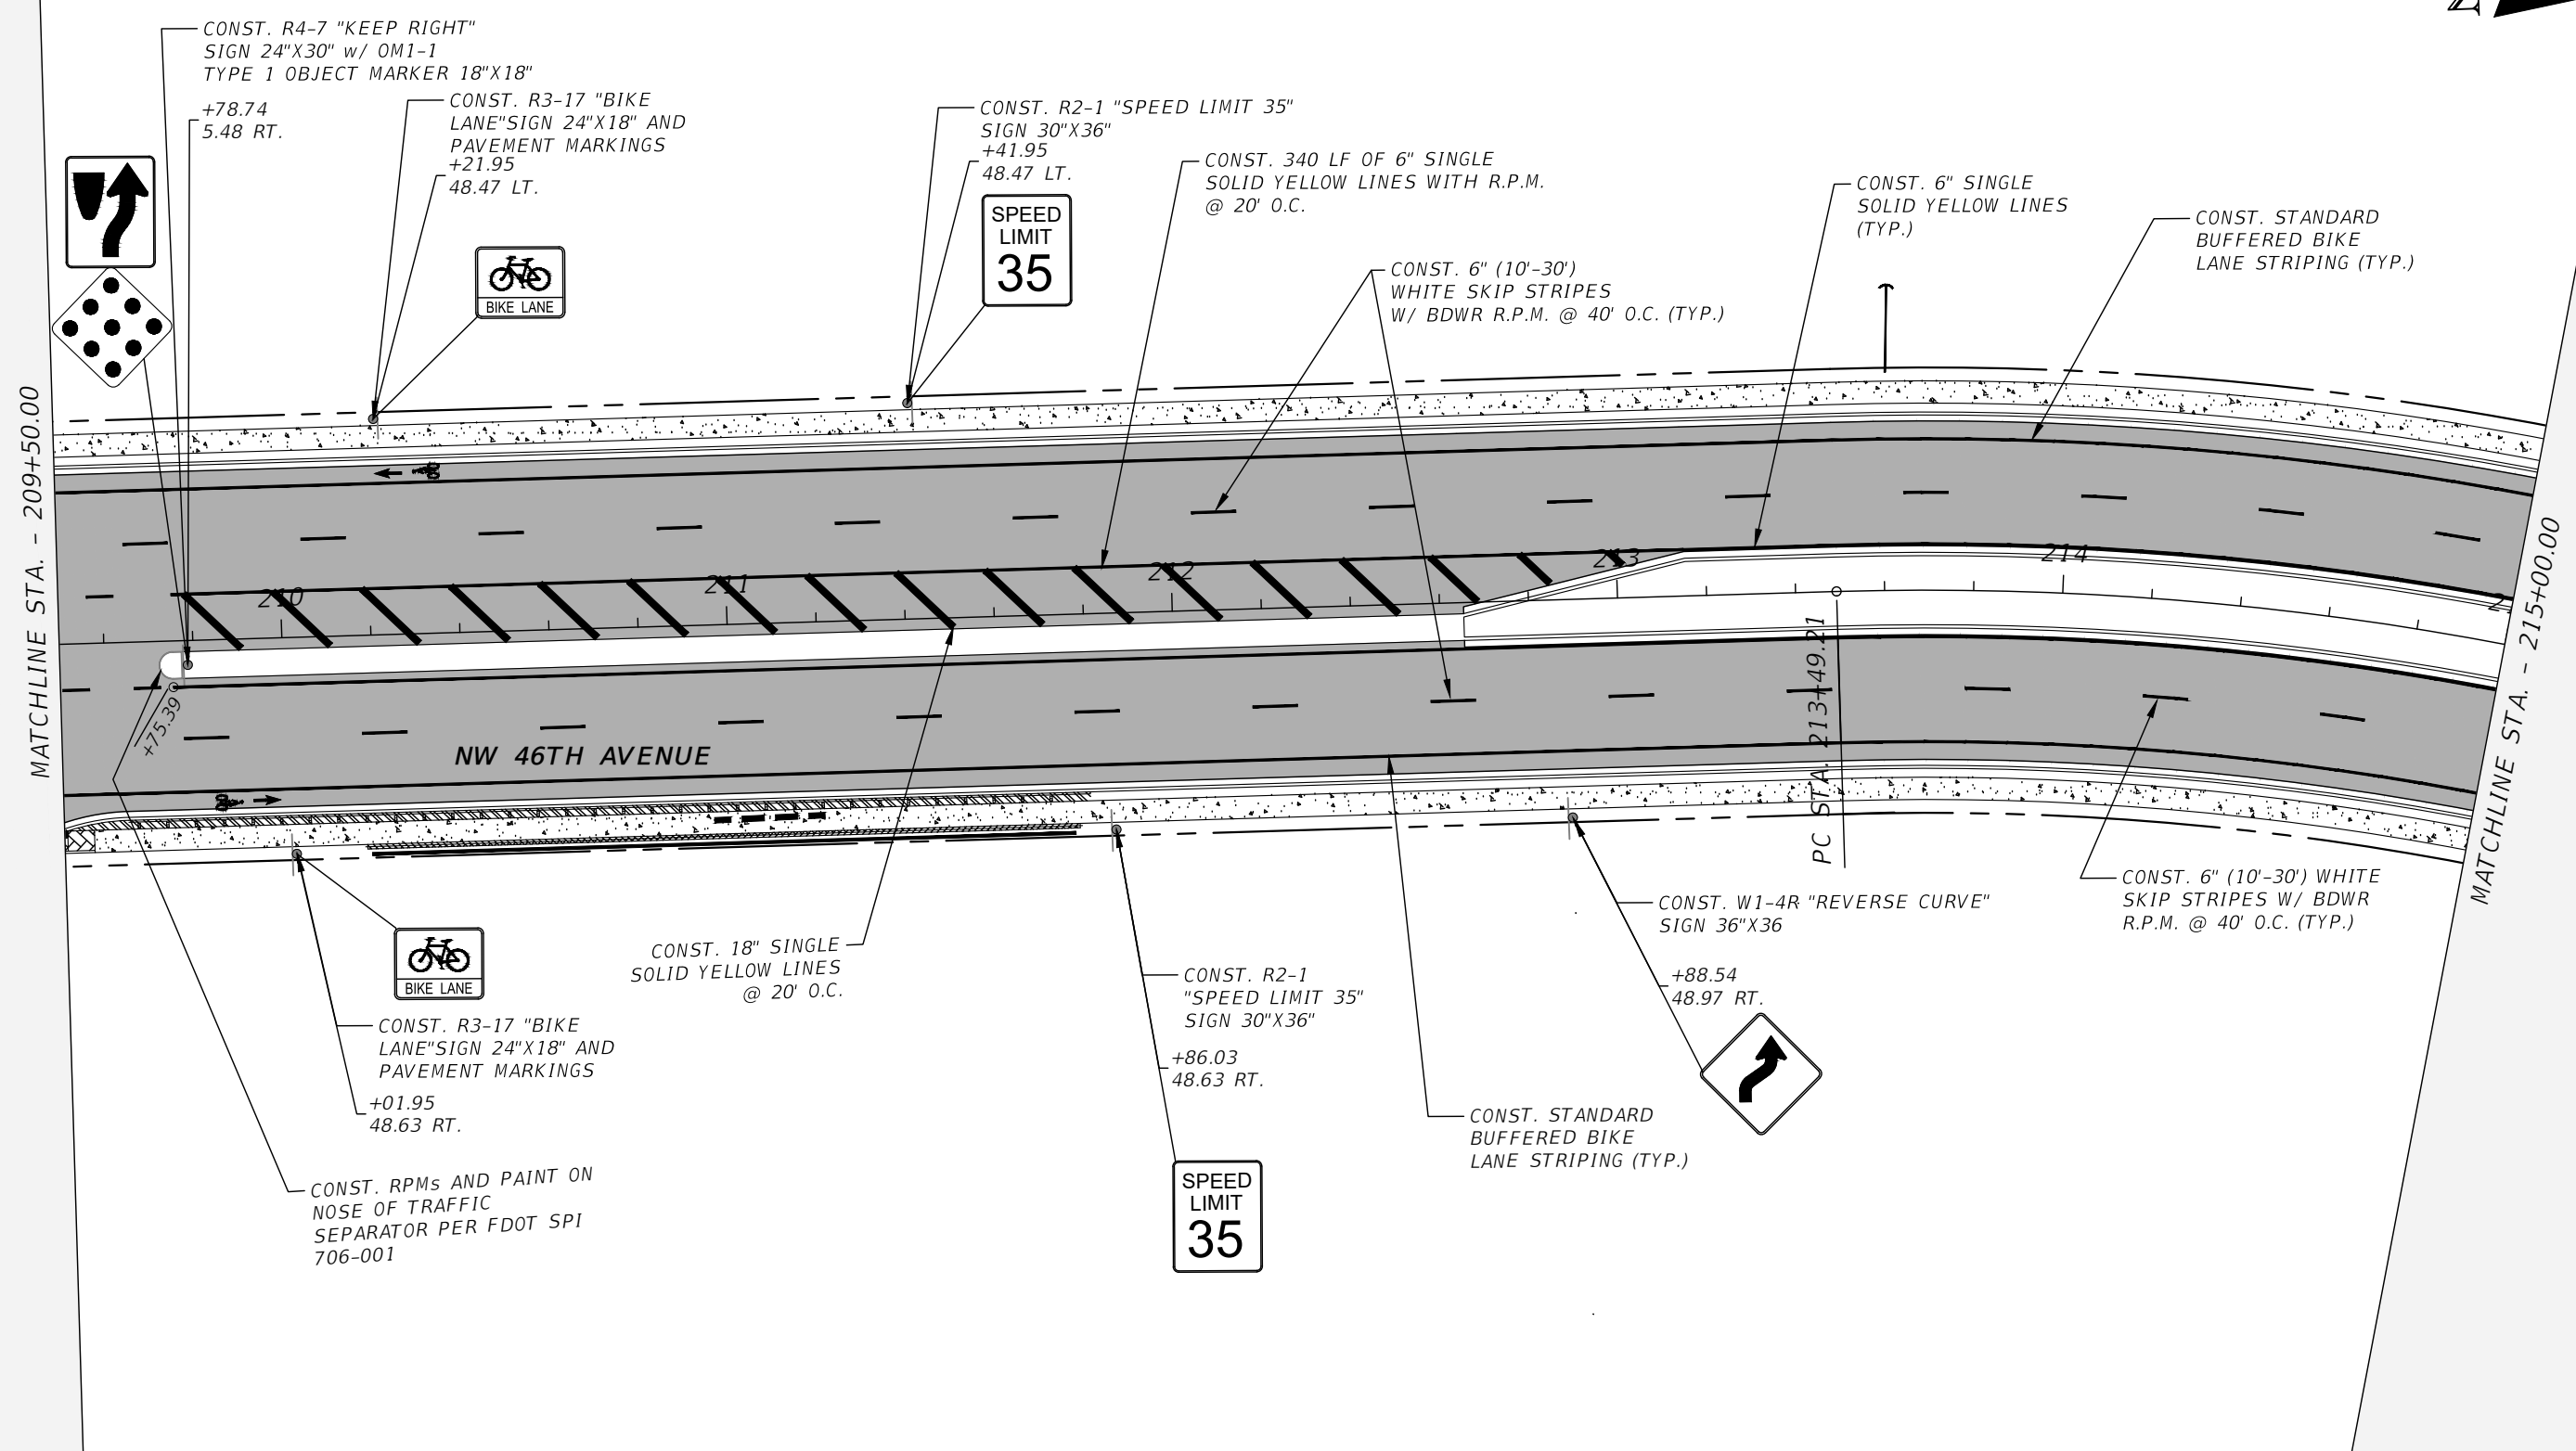
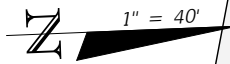


THE OFFICIAL RECORD OF THIS SHEET IS THE ELECTRONIC FILE DIGITALLY SIGNED AND SEALED UNDER RULE 61G15-23.004, F.A.C.

REVISIONS				NOEL JOHN COOPER, P.E. P.E. LICENSE NUMBER 69534 STATE OF FLORIDA, DATE: _____ VALID ONLY WITH EMBOSSED SEAL.		NW 44th AVENUE EXTENSION PHASE 2		SHEET NO. 72
DATE	DESCRIPTION	DATE	DESCRIPTION			SIGNAGE AND STRIPING PLAN (3)		
4/6/23	Revised notes, pavement markings, & signs	---	---					

BIKE STRIPING NOTE:

1. THE EDGE OF THE BIKE LANE ADJACENT TO THE TRAVEL WAY IS TWO (2) 6" WHITE STRIPES, SET 8" APART PER FDOT SPI 711-001, BEING EITHER SOLID OR 2'-4" SKIP PER THE MARKING PLAN. OUTER LINES OMITTED FOR CLARITY.

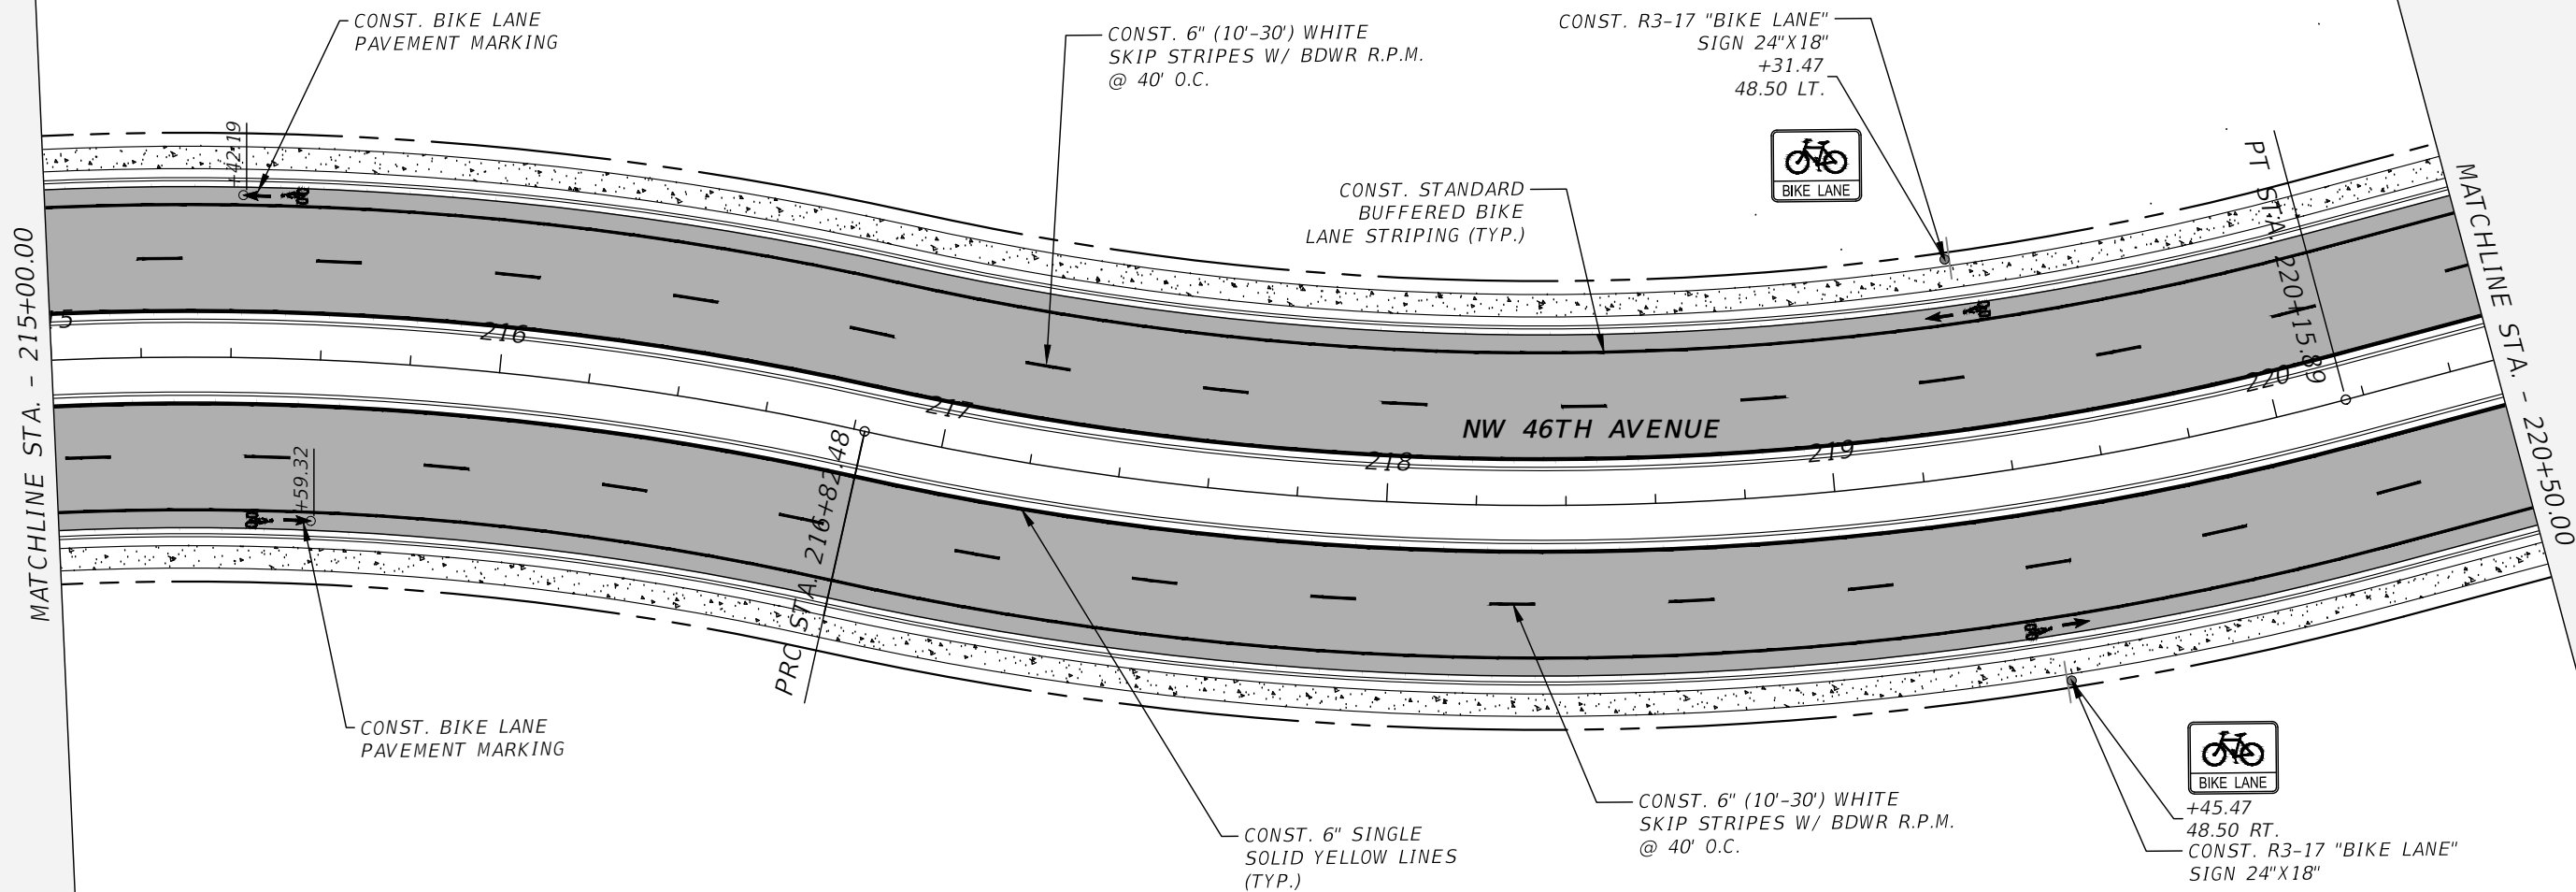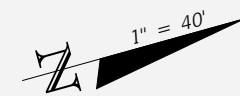

THE OFFICIAL RECORD OF THIS SHEET IS THE ELECTRONIC FILE DIGITALLY SIGNED AND SEALED UNDER RULE 61G15-23.004, F.A.C.

REVISIONS			
DATE	DESCRIPTION	DATE	DESCRIPTION
4/6/23	Revised notes	---	---

NOEL JOHN COOPER, P.E.
P.E. LICENSE NUMBER 69534
STATE OF FLORIDA, DATE: _____
VALID ONLY WITH EMBOSSED SEAL.

PREPARED BY

Gary Anson



NW 44th AVENUE EXTENSION PHASE 2

SIGNAGE AND STRIPING PLAN (4)

SHEET NO.
73

BIKE STRIPING NOTE:

1. THE EDGE OF THE BIKE LANE ADJACENT TO THE TRAVEL WAY IS TWO (2) 6" WHITE STRIPES, SET 8" APART PER FDOT SPI 711-001, BEING EITHER SOLID OR 2'-4" SKIP PER THE MARKING PLAN. OUTER LINES OMITTED FOR CLARITY.

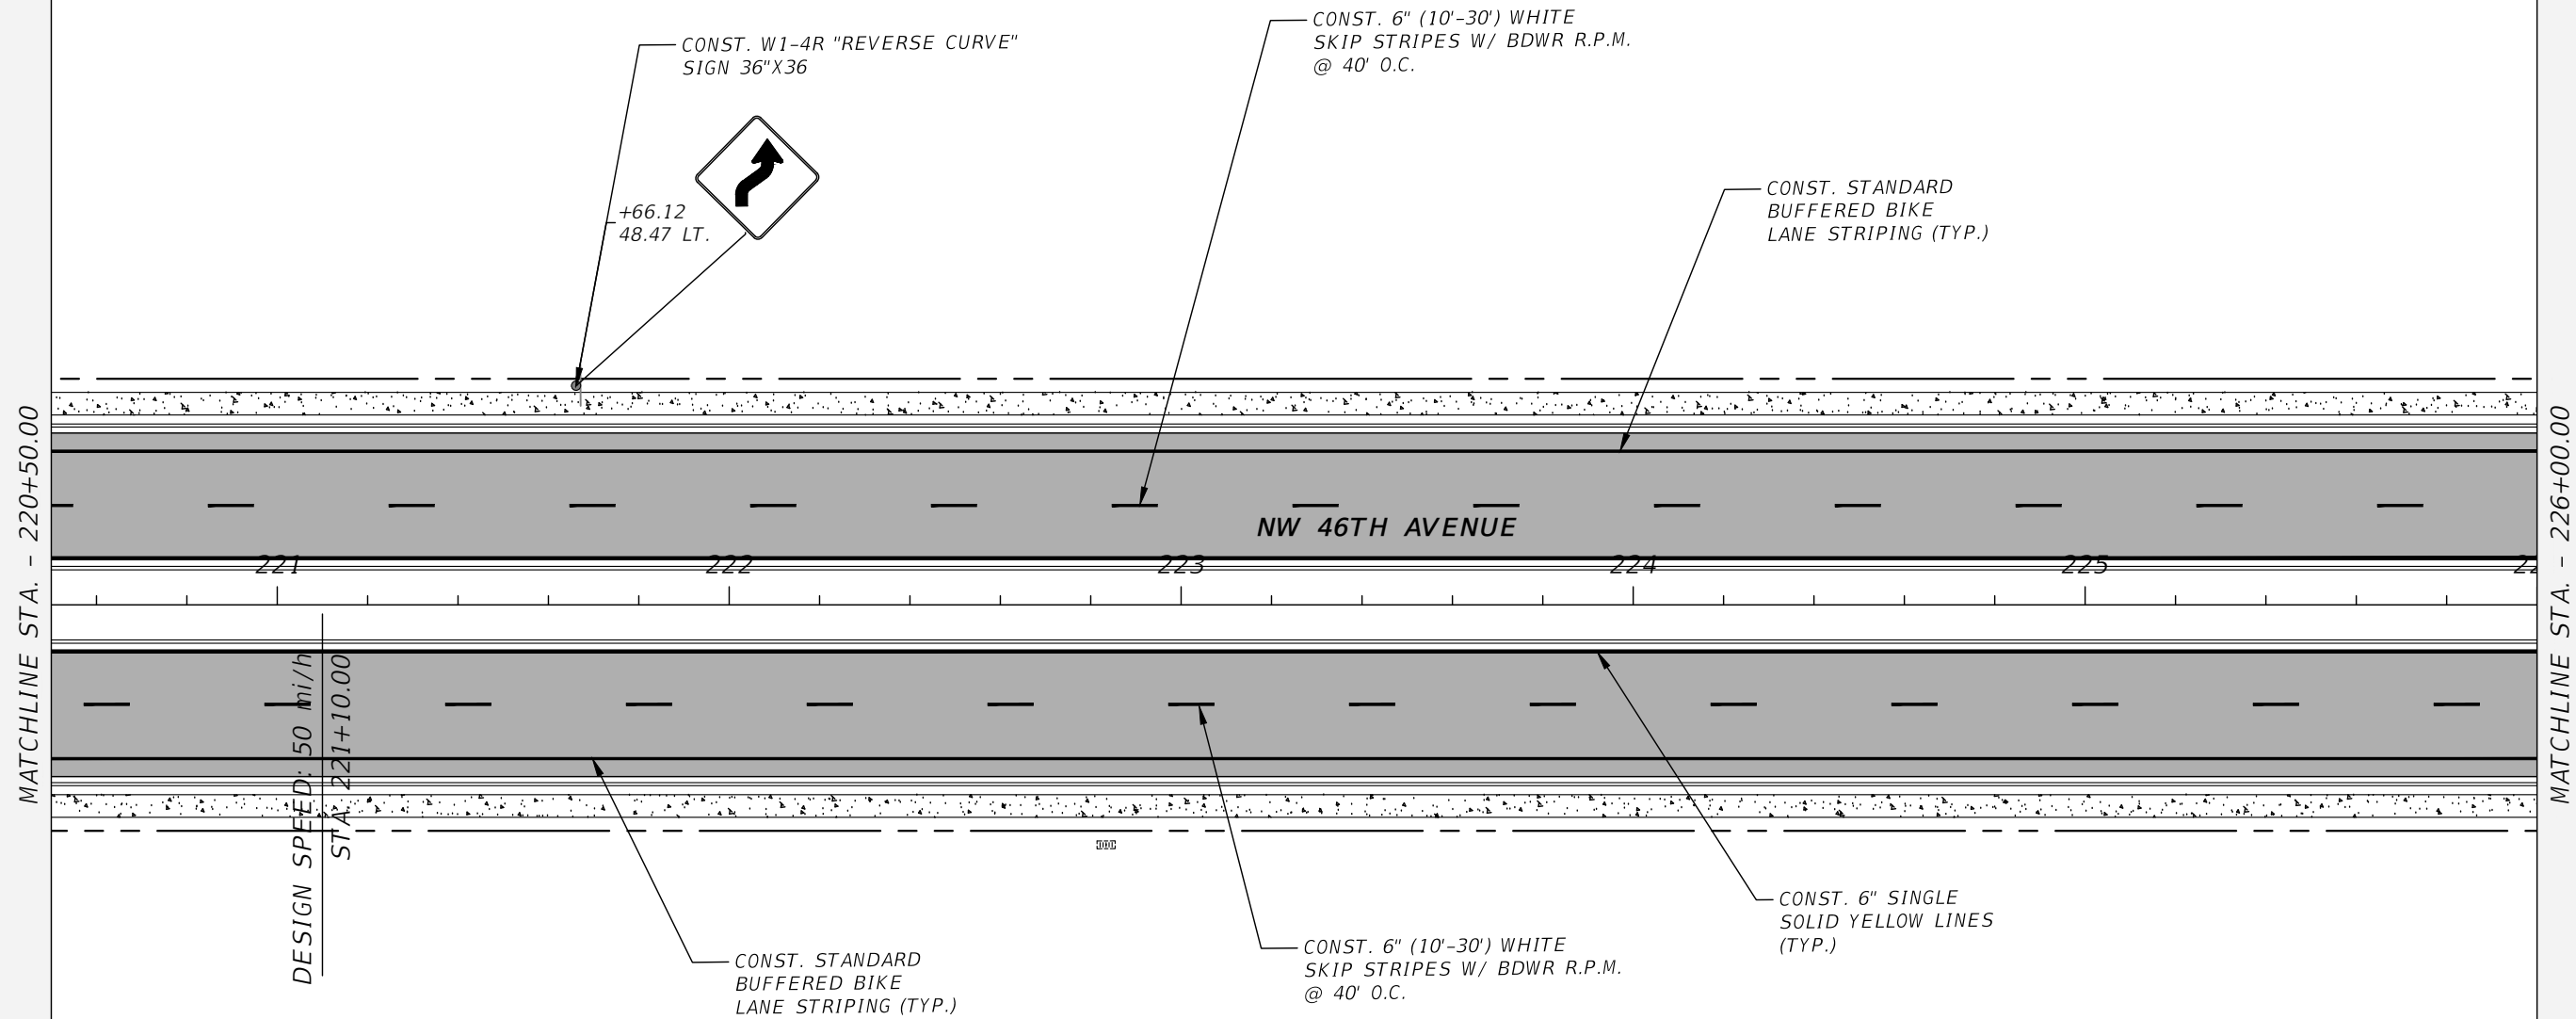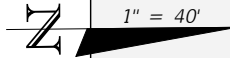

MATCHLINE STA. - 220+50.00

MATCHLINE STA. - 226+00.00

DESIGN SPEED: 50 mi/h
STA: 221+10.00

NW 46TH AVENUE

221

222

223

224

225

226

CONST. STANDARD BUFFERED BIKE LANE STRIPING (TYP.)

CONST. 6" (10'-30') WHITE SKIP STRIPES W/ BDWR R.P.M. @ 40' O.C.

CONST. 6" SINGLE SOLID YELLOW LINES (TYP.)

REVISIONS			
DATE	DESCRIPTION	DATE	DESCRIPTION
4/6/23	Revised notes & signs	---	---

NOEL JOHN COOPER, P.E.
P.E. LICENSE NUMBER 69534
STATE OF FLORIDA, DATE: _____
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Gary Anson

NW 44th AVENUE EXTENSION PHASE 2



SIGNAGE AND STRIPING PLAN (5)

SHEET NO.
74

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BIKE STRIPING NOTE:

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MATCHLINE STA. - 226+00.00

MATCHLINE STA. - 231+50.00

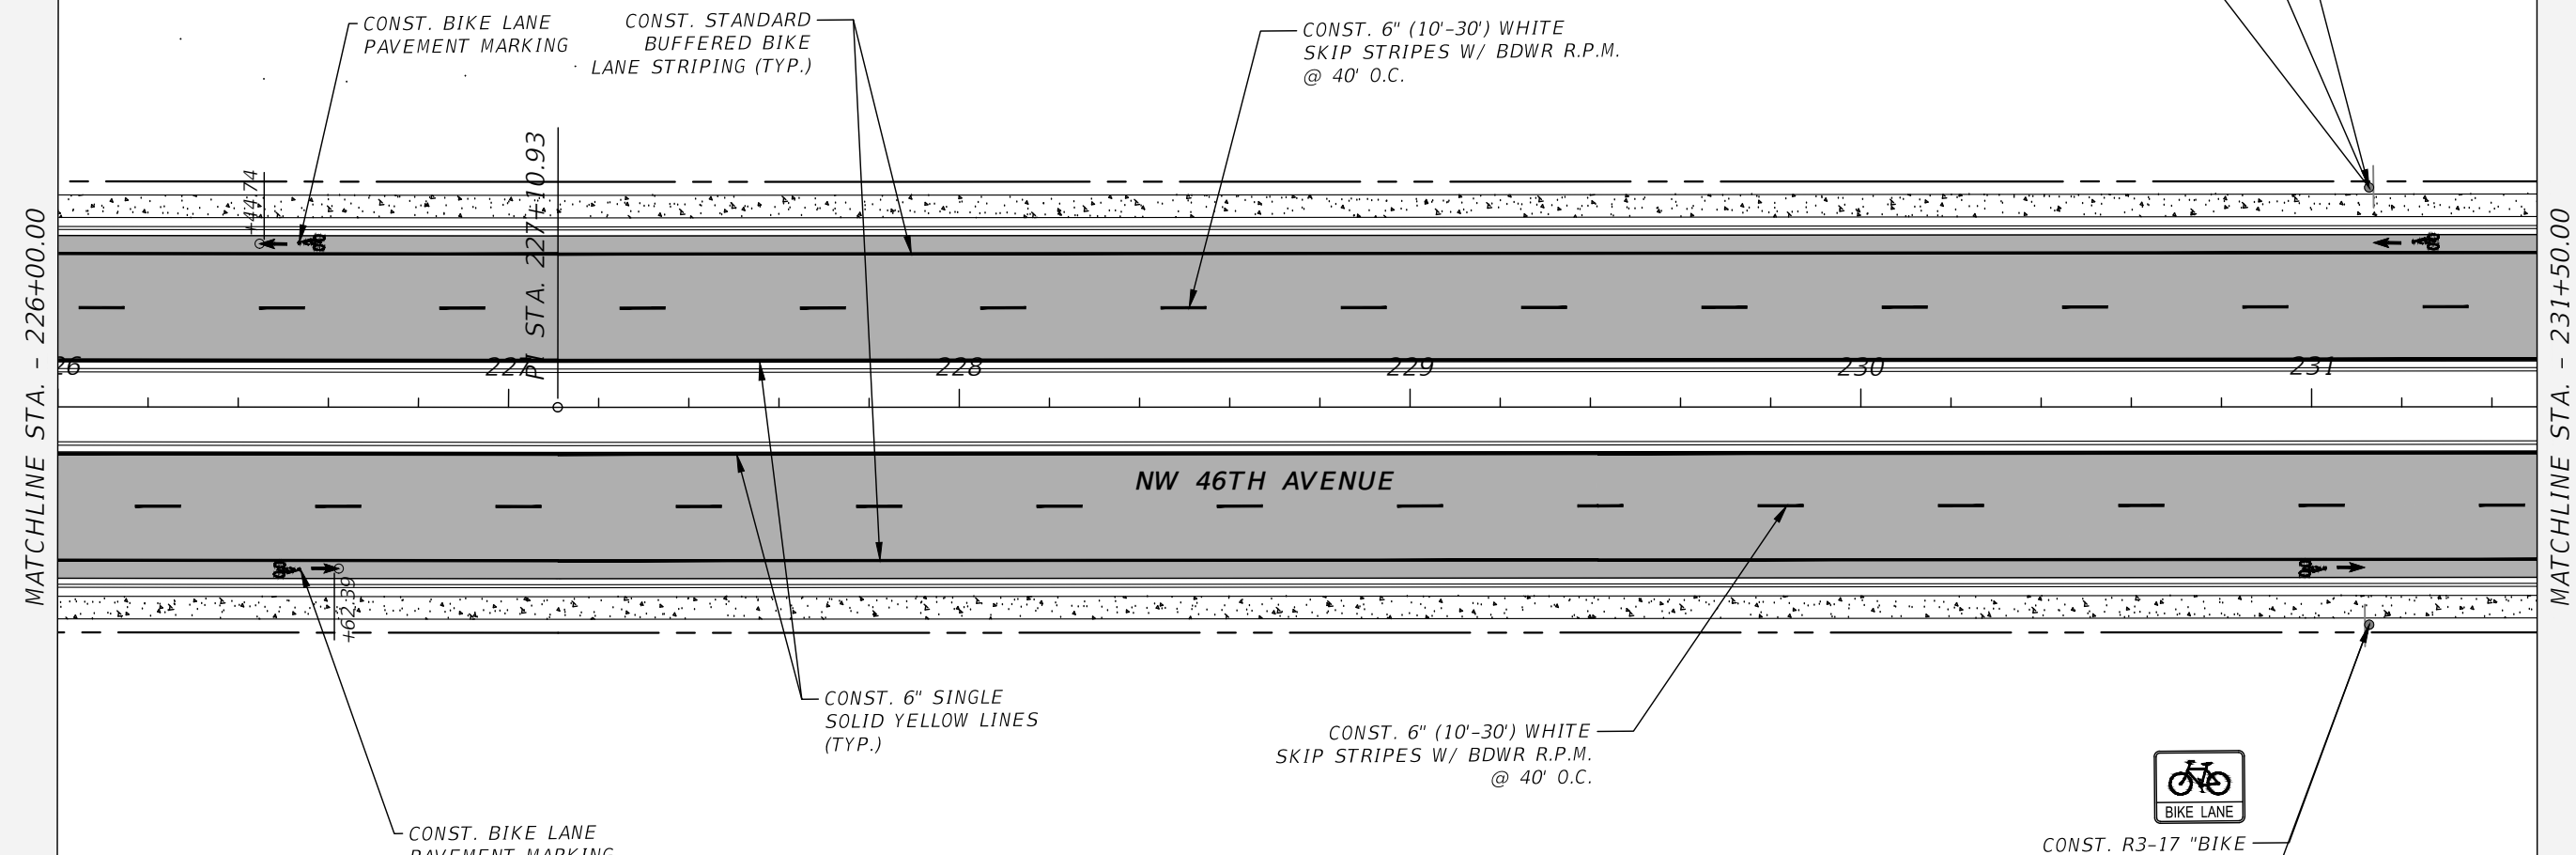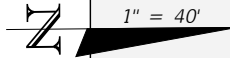CONST. R3-17 "BIKE LANE" SIGN 24"X18" AND PAVEMENT MARKINGS
+12.76
48.64 LT.



CONST. 6" (10'-30') WHITE SKIP STRIPES W/ BDWR R.P.M. @ 40' O.C.

CONST. R3-17 "BIKE LANE" SIGN 24"X18" AND PAVEMENT MARKINGS
+12.76
48.30 RT.



REVISIONS			
DATE	DESCRIPTION	DATE	DESCRIPTION
4/6/23	Revised notes	---	---

NOEL JOHN COOPER, P.E.
P.E. LICENSE NUMBER 69534
STATE OF FLORIDA, DATE: _____
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PREPARED BY
OCALA
CITY ENGINEER'S OFFICE



NW 44th AVENUE EXTENSION PHASE 2
SIGNAGE AND STRIPING PLAN (6)

SHEET NO.
75

THE OFFICIAL RECORD OF THIS SHEET IS THE ELECTRONIC FILE DIGITALLY SIGNED AND SEALED UNDER RULE 61G15-23.004, F.A.C.

BIKE STRIPING NOTE:

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REVISIONS			
DATE	DESCRIPTION	DATE	DESCRIPTION
4/6/23	Revised notes	---	---

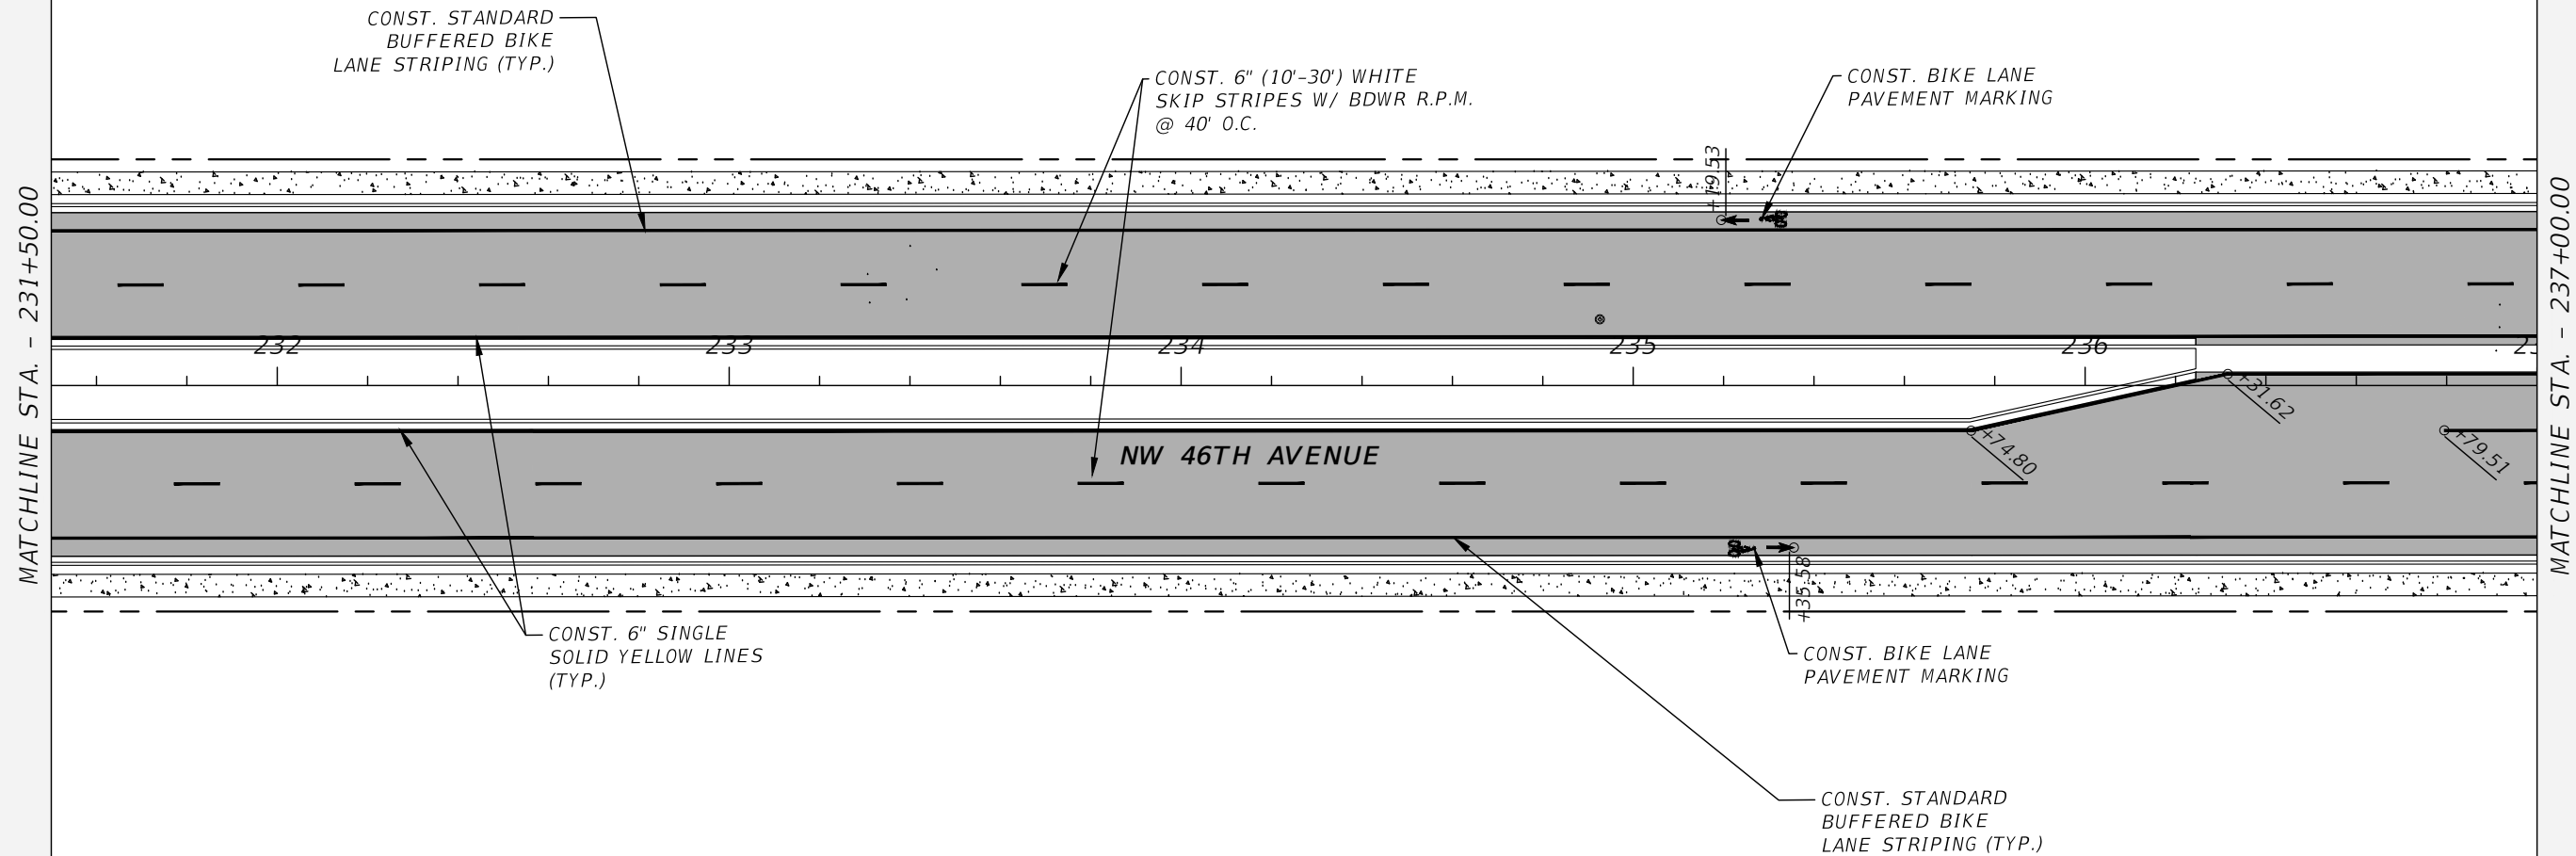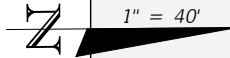NOEL JOHN COOPER, P.E.
P.E. LICENSE NUMBER 69534
STATE OF FLORIDA, DATE: _____
VALID ONLY WITH EMBOSSED SEAL.

PREPARED BY

Gary Anson

NW 44th AVENUE EXTENSION PHASE 2



SIGNAGE AND STRIPING PLAN (7)

SHEET NO.
76

THE OFFICIAL RECORD OF THIS SHEET IS THE ELECTRONIC FILE DIGITALLY SIGNED AND SEALED UNDER RULE 61G15-23.004, F.A.C.


BIKE STRIPING NOTE:

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
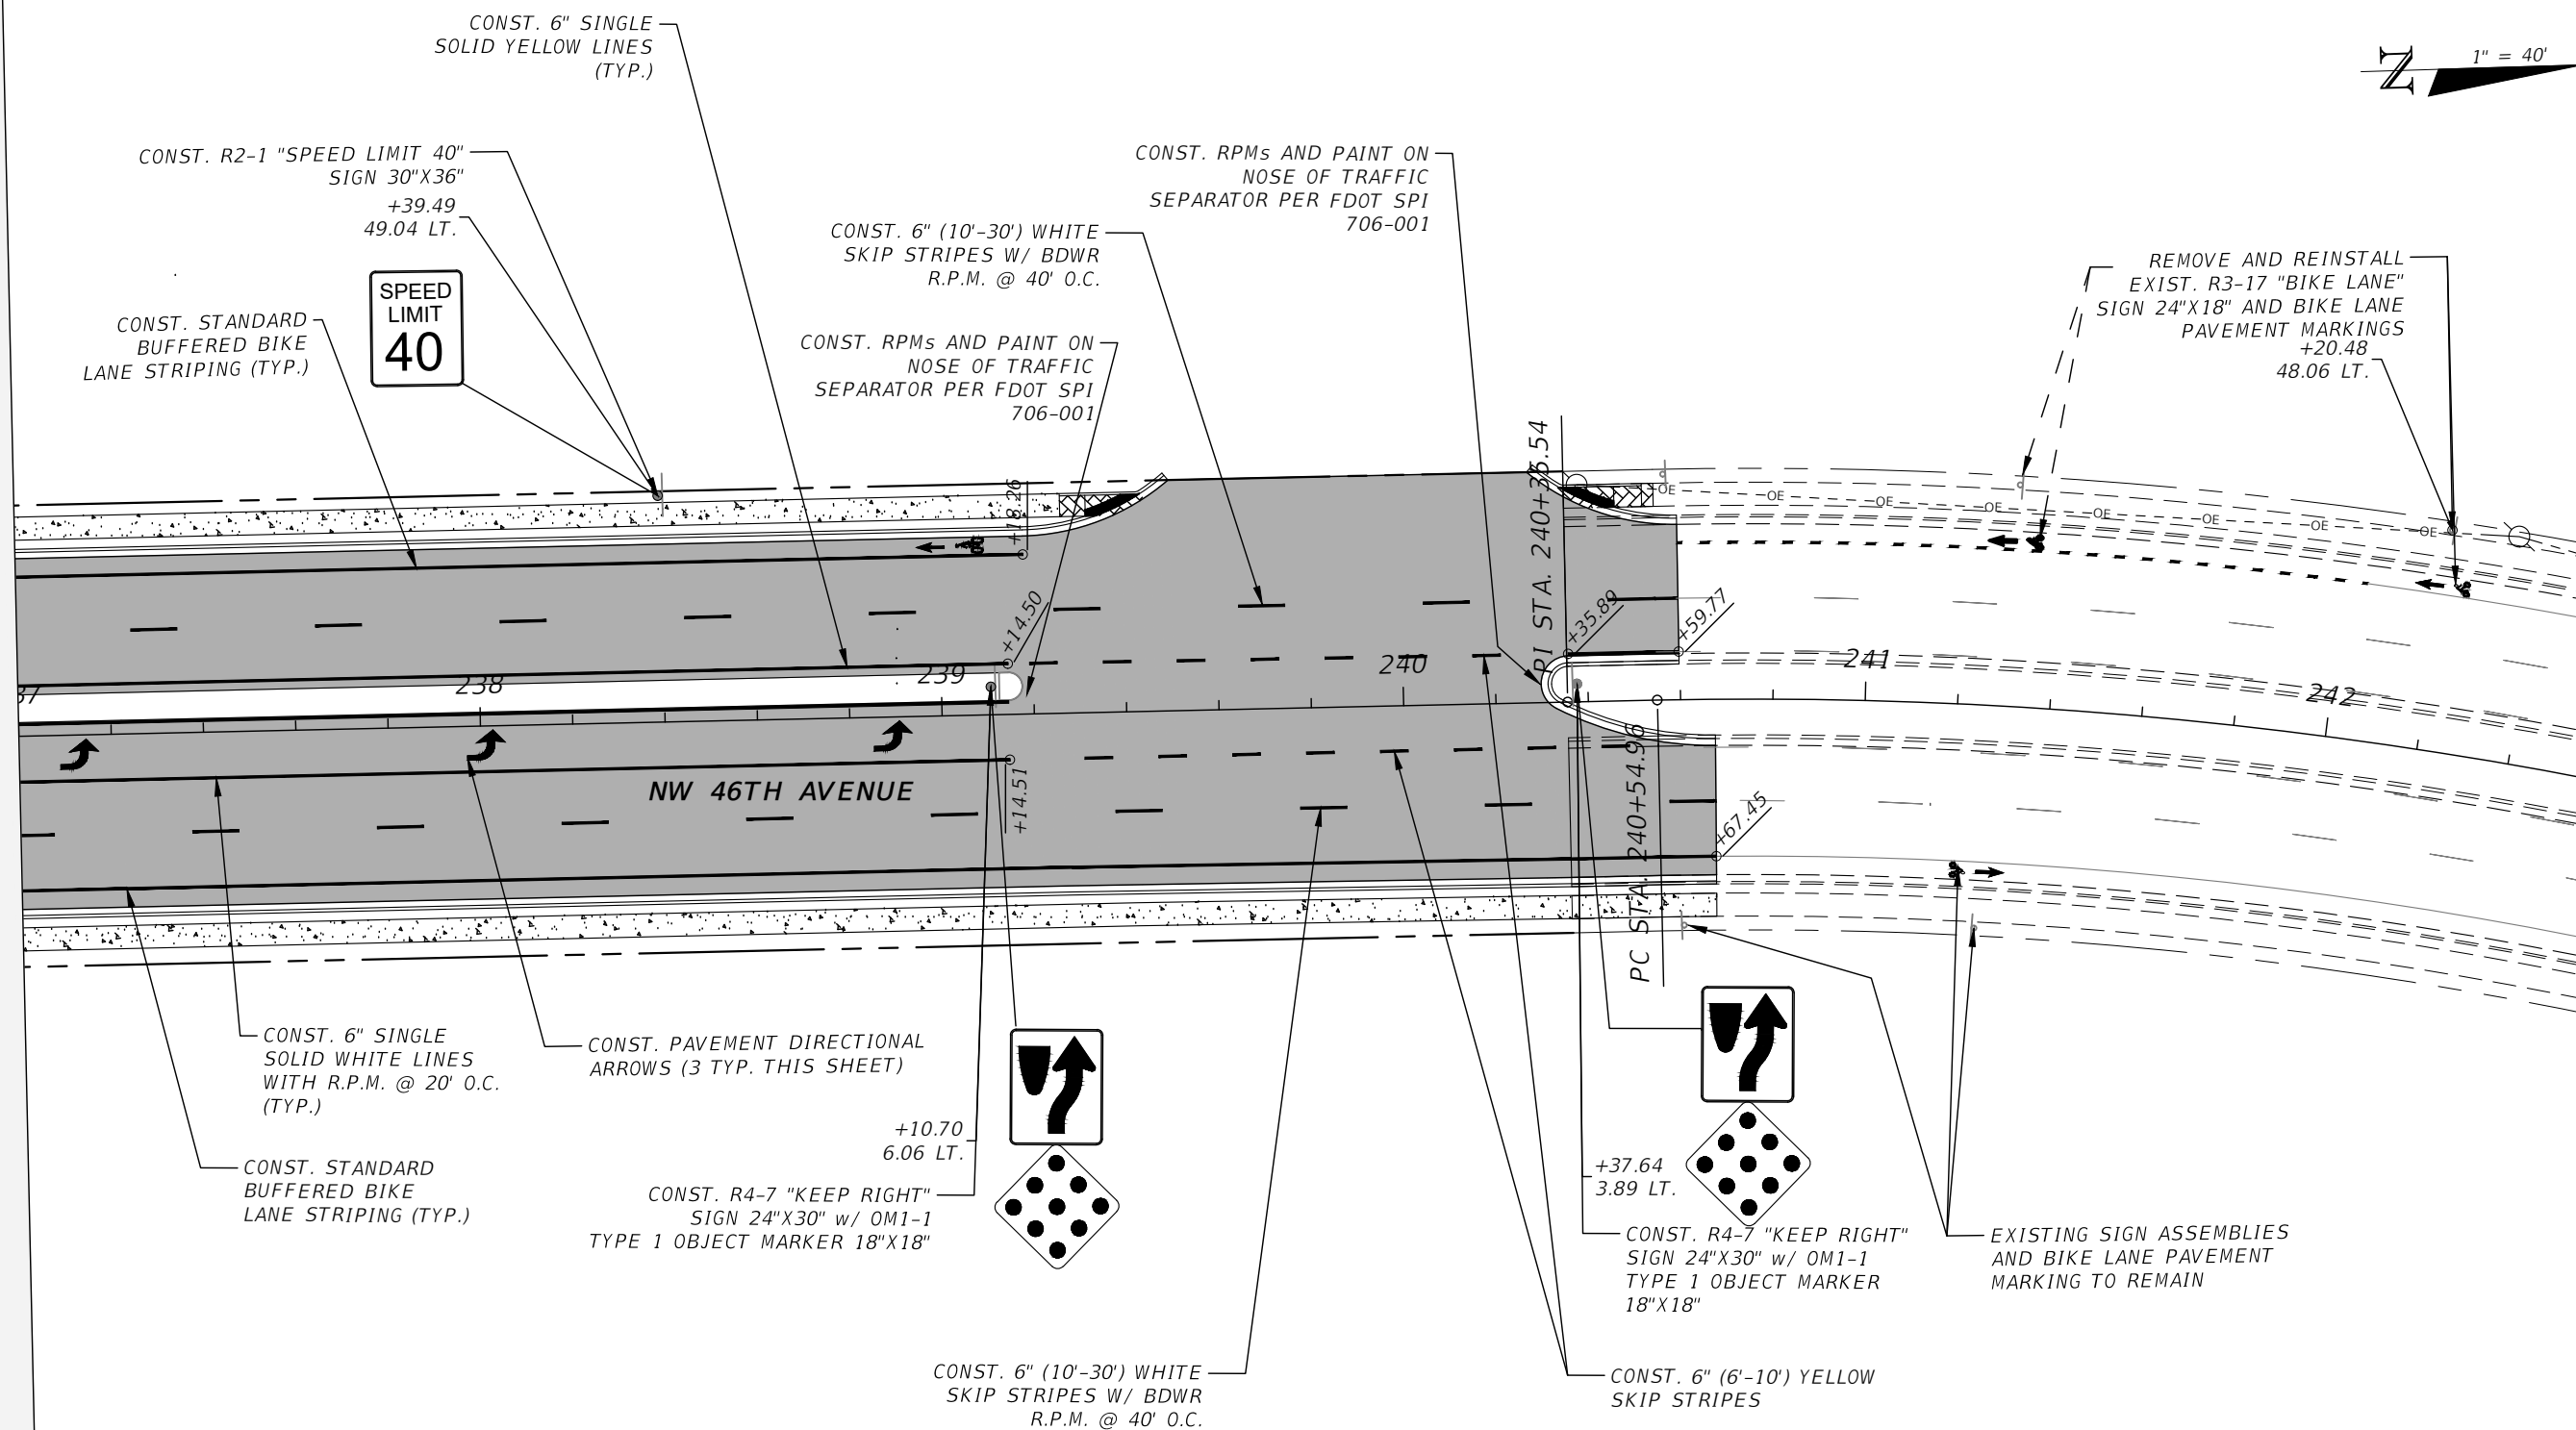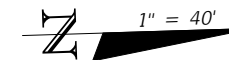
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
REVISIONS				NOEL JOHN COOPER, P.E. P.E. LICENSE NUMBER 69534 STATE OF FLORIDA, DATE: _____ VALID ONLY WITH EMBOSSED SEAL.		NW 44th AVENUE EXTENSION PHASE 2		SHEET NO. 77
DATE	DESCRIPTION	DATE	DESCRIPTION			SIGNAGE AND STRIPING PLAN (8)		
4/6/23	Revised notes, pavement markings, & signs	---	---					



NOTE:
A TEMPORARY ACCESS PERMIT WILL NEED TO BE APPLIED FOR IF A CONSTRUCTION ENTRANCE TO SR 40 IS USED.

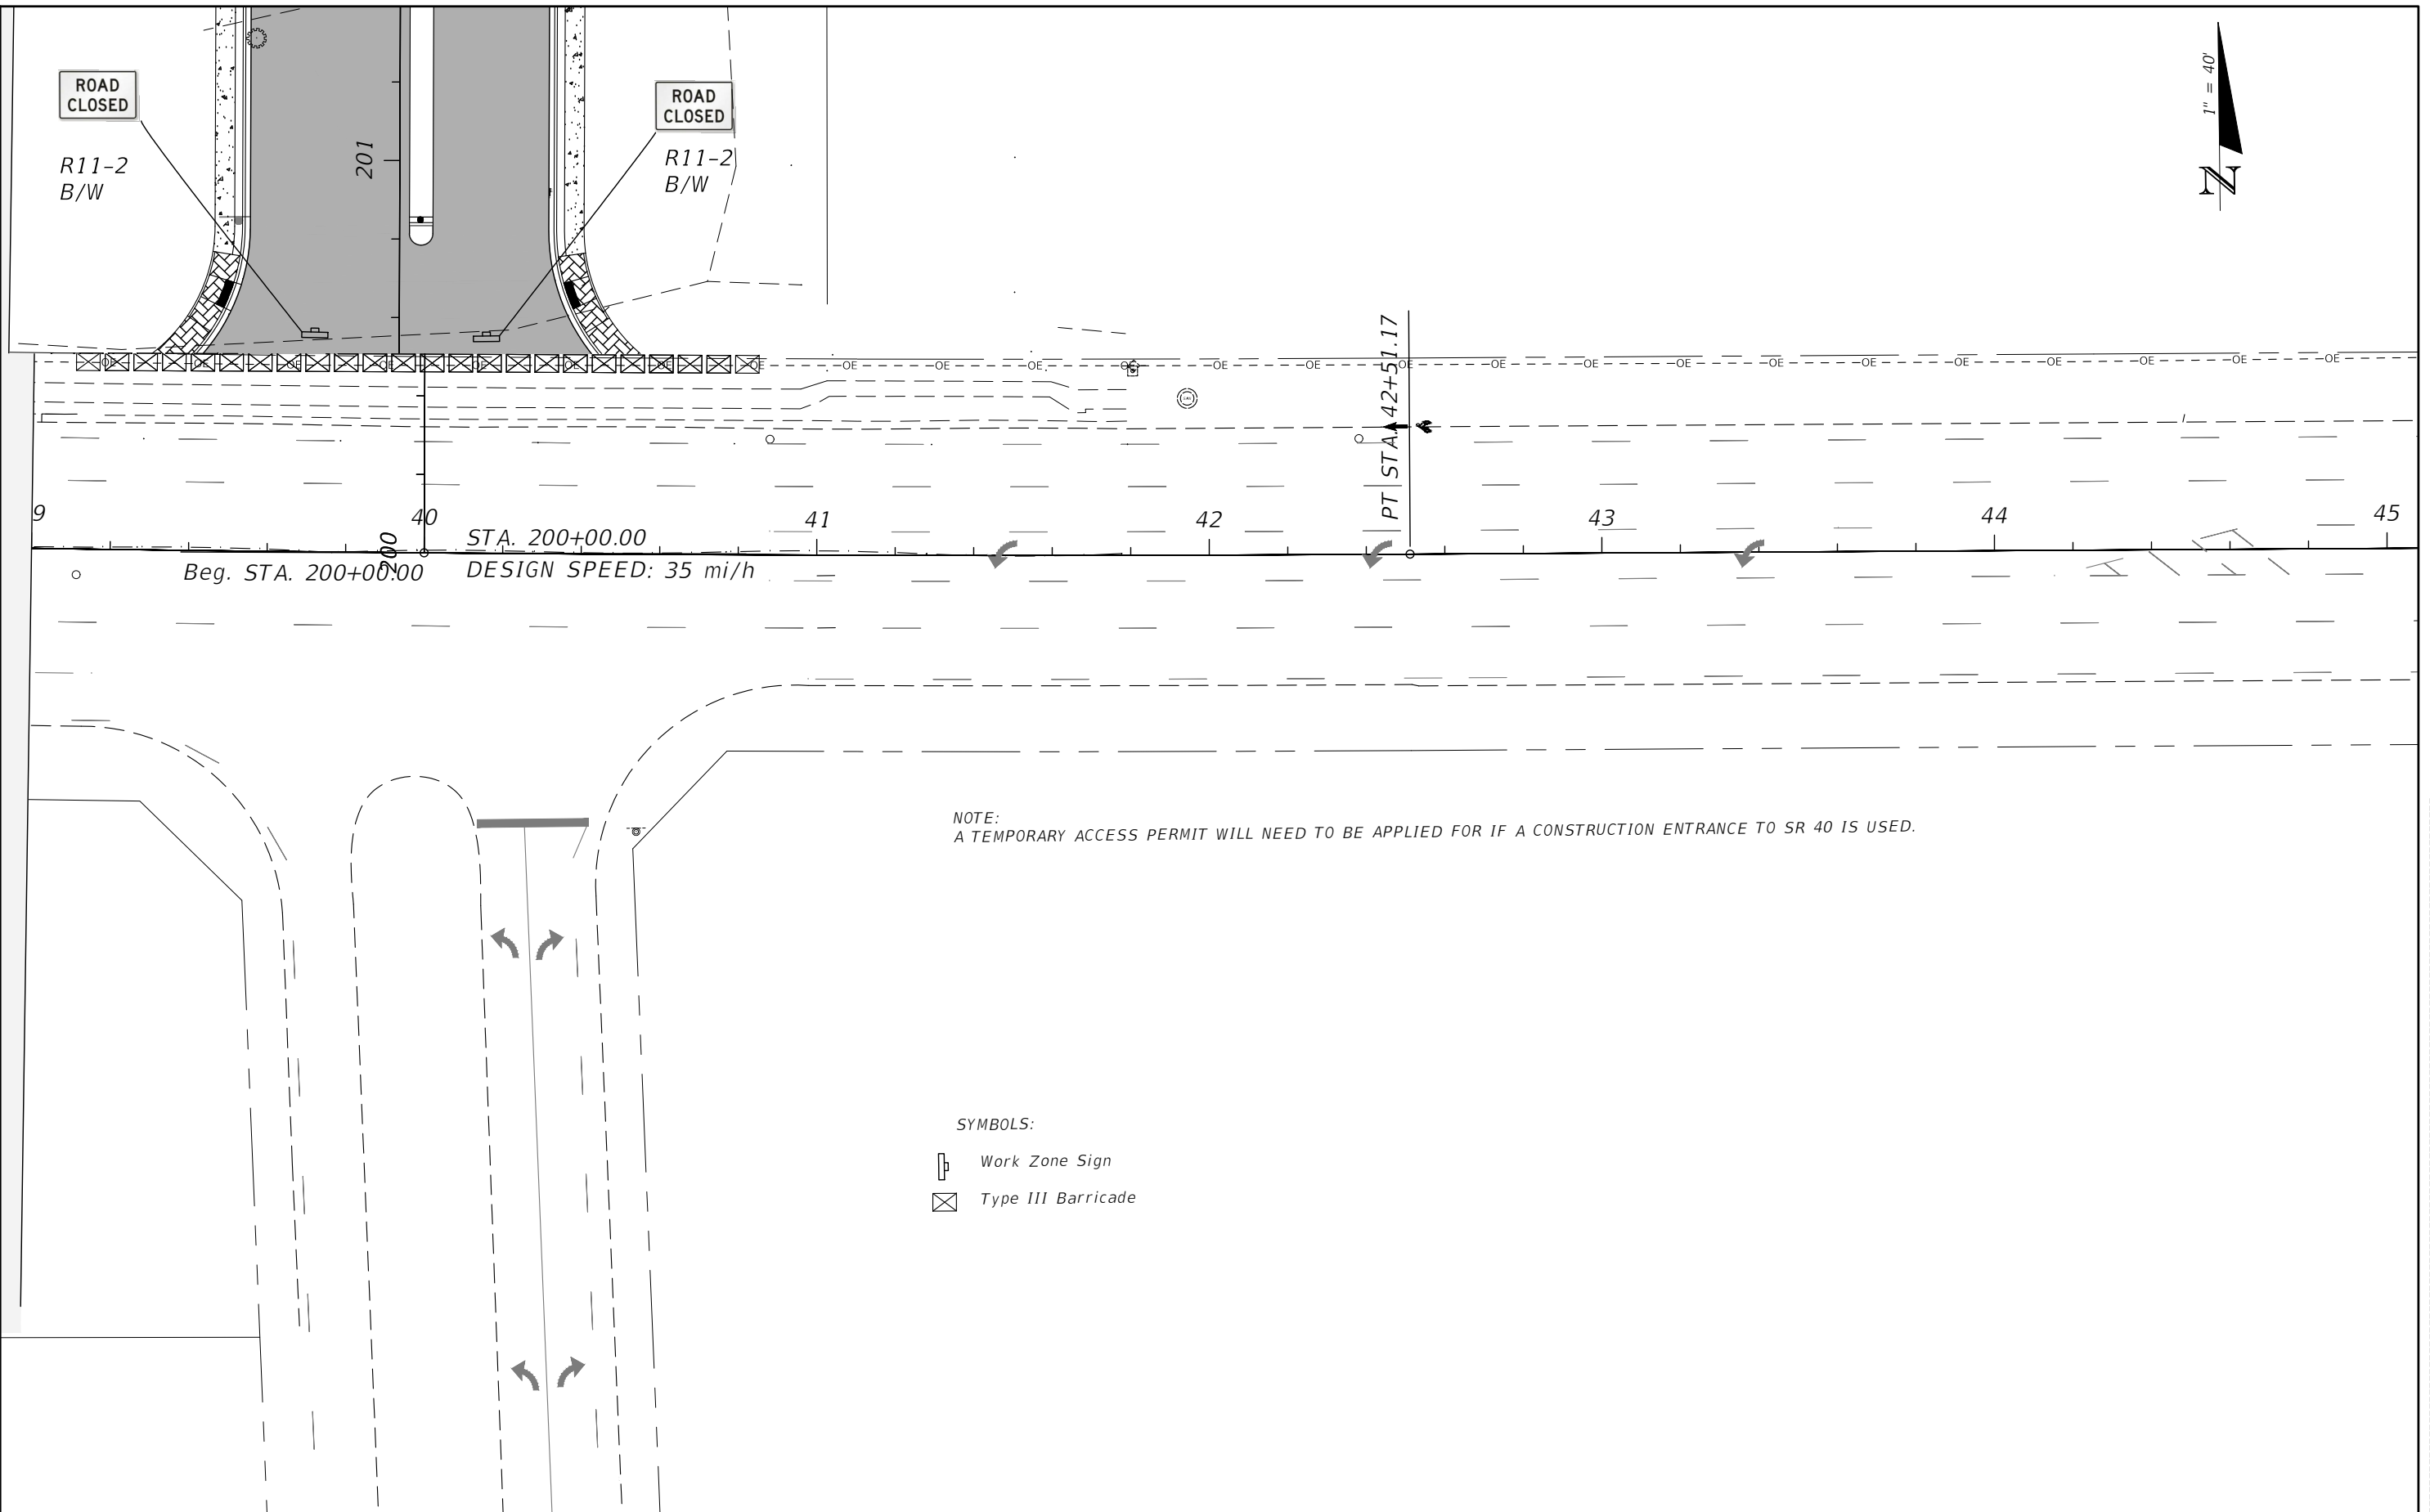SYMBOLS:

-  Work Zone Sign
-  Type III Barricade

REVISIONS		PREPARED BY		SW/NW 44th AVENUE EXTENSION PHASE 2		SHEET NO.
DATE	DESCRIPTION	DATE	DESCRIPTION			
1/25/23	REMOVED PROPOSED STRIPING			 TEMPORARY TRAFFIC CONTROL PLAN (NW 44th AVE & SR 40)		78
2/15/23	REMOVED TEMPORARY PEDESTRIAN WAY					
3/8/23	MODIFIED NOTES FOR PEDESTRIAN WAY & SIGN LOCATION.					
				NOEL JOHN COOPER, P.E. P.E. LICENSE NUMBER 69534 STATE OF FLORIDA, DATE: _____ VALID ONLY WITH EMBOSSED SEAL.		